
| DRAWING | LIST | | | | | | | |
|---|--|------------------------------|--|--|--|--|--|--|
| SHEET | DESCRIPTION | SCALE | | | | | | |
| Plans | | | | | | | | |
| A-001 A-100 | PLOT PLAN FOUNDATION / BASEMENT PLAN | 1:100 1/4" = 1'-0" | | | | | | |
| A-100 A-101 | FOUNDATION / BASEMENT PLAN FLOOR 01 DEMO PLAN | 1/4" = 1'-0" 1/4" = 1'-0" | | | | | | |
| A-102 | | 1/4" = 1'-0" | | | | | | |
| A-103 A-104 A-105 | FLOOR 01 PROPOSED PLAN + WALL TYPES + EQUIP. SCHEDULE1/4" = 1'-0"FLOOR 02 PROPOSED PLAN + DOOR AND WINDOW SCHEDULES1/4" = 1'-0"ROOF PLAN1/4" = 1'-0" | | | | | | | |
| Exterior Elevations | | 1/4" - 1' 0" | | | | | | |
| ۹-200 ۹-201 | EXTERIOR ELEVATIONS - EAST, WEST, SOUTH EXISTING EXTERIOR ELEVATIONS - EAST, WEST, SOUTH PROPOSED | 1/4" = 1'-0" 1/4" = 1'-0" | | | | | | |
| | EXTERIOR ELEVATIONS - NORTH EXISTING + PROPOSED | 1/4" = 1'-0" | | | | | | |
| Building + Wall Sec -300 | BUILDING SECTIONS | 1/4" = 1'-0" | | | | | | |
| -500 | TYPICAL EXTERIOR DTLS | 1 1/2" = 1'-0" | | | | | | |
| 1. GC SHALL BE RES AND DIMENSIONS F COORDINATION ISS | SPONSIBLE FOR CHECKING ALL "CONTRACT DOCUMENTS," FIELD C OR ACCURACY. IF THERE ARE ANY QUESTIONS REGARDING THESE UES, THE GC IS RESPONSIBLE FOR OBTAINING A CLARIFICATION (A ST WRITING DOWN HIS/HER QUESTIONS AND SENDING (IE. EMAIL) A | OR OTHER SI) FROM THE | | | | | | |
| INFORMATION (RFI) OTHER RELATED W | TO THE ARCHITECT BEFORE PROCEEDING WITH THE WORK IN QUE ORK. | ESTION OR | | | | | | |
| THAN THE GC Or HI | D "BY OTHERS" OR "N.I.C." IS TO BE ACCOMPLISHED BY A CONTRAC S/HER SUBCONTRACTORS, AND IS NOT TO BE PART OF THE CONTR . COMPLY WITH THE REQUIREMENTS OF APPLICABLE LOCAL, STATE | ACT SUM. | | | | | | |
| CODES, ORDINANC | ES AND REGULATIONS. CONNECTICUT BUILDING CODE i. 2021 INTERNATIONAL RESIDENTIAL BUILDING CODE OF THE IC ii. 2021 INTERNATIONAL PLUMBING CODE iii. 2021 INTERNATIONAL PLUMBING CODE iv. 2021 INTERNATIONAL MECHANICAL CODE iv. 2021 INTERNATIONALENERGY CONSERVATION CODE v. 2020 NFPA 70, NATIONAL ELECTRICAL CODE, OF THE NFPA | | | | | | | |
| COMPLY WITH SECT | WITH 2021 IRC REQUIREMENTS, ADDITIONS, ALTERATIONS AND REF FION N1109 AND ANY UNCONDITIONED SPACE OR LOW-ENERGY SPA ME CONDITIONED SPACE SHALL COMPLY WITH SECTION N1108. | | | | | | | |
| COMPLY WITH THE i.N1100 ALTERA CONFOI THE ALT REQUIR UNALTE | E WITH 2021 IRC REQUIREMENTS FOR ADDITIONS AND ALTERATION FOLLOWING SECTIONS: (R502) ADDITIONS AND SECTIONS N1111 (R503) ALTERATIONS SO TH TIONS AND ADDITIONS TO THE EXISTING BUILDING ARE NOT LESS RMING WITH THE PROVISION OF THE EXISTING BUILDING PRIOR TO TERATION AND WHERE THE ADDITION SHALL CONFORM TO THE EMENTS OF NEW CONSTRUCTION WITHOUT REQUIRING THE RED PORTION OF THE EXISTING BUILDING TO COMPLY. ADDITIONS AN UNSAFE OR HAZARDOUS CONDITION OR OVERLOAD THE EXIST A. | AT SHALL NOT | | | | | | |
| ii. N113. ALTERE | 1.1 (R505.1.1): ANY UNCONDITIONED SPACE OR LOW-ENERGY SPACE D TO BECOME CONDITIONED SPACE SHALL COMPLY WITH SECTION NEWLY INSTALLED AS PART OF AN ALTERATION SHALL COMPLY WIT | N1108: HVAC | | | | | | |
| DUST AND DEBRIS \ | BLE FOR INSTALLING ADEQUATE PROTECTION FOR KEEPING ANY CONTINUES OF THE CONSTRUCTION SITE. IN THE EVENT THAT IT THE CONSTRUCTION SITE, CONTRACTOR IS RESPONSIBLE FOR | AT ANY DUST | | | | | | |
| | ONSIBLE FOR ALL FEES AND PERMITS NECESSARY TO COMPLETE TH CONTRACT DOCUMENTS. | HE WORK | | | | | | |
| A. IN CC | OPPING IN THE FOLLOWING LOCATIONS. ONCEALED SPACES OF STUD WALLS AND PARTITIONS, INCLUDING F 5, AT THE CEILING AND FLOOR LEVELS | URRED | | | | | | |
| OCCUR | L INTERCONNECTIONS BETWEEN VERTICAL AND HORIZONTAL SPAC AT SOFFITS, DROP CEILINGS, COVE CEILINGS, ETC. | | | | | | | |
| D. AT OF | DNCEALED SPACES AT STAIR STRINGERS AND THE TOP AND BOTTO PENINGS AROUND VENTS, PIPES, CHIMNEYS, AND FIRE PLACES, AT LEVEL, WITH NONCOMBSTIBLE MATERIALS. | | | | | | | |
| 8. PROVIDE GLASS SOFFITS FOR DRAF | FIBER INSULATION, MINERAL WOOL OR SPRAY FOAM EVERY 10' AT \ T STOP. | WALLS AND | | | | | | |
| | D ALL FIREPROOFING WHICH HAS BEEN DISTURBED DURING DEMC | DLITION. | | | | | | |
| 11. ALL DIMENSIONS | DRAWINGS. USE WRITTEN DIMENSIONS ONLY. 5, NOTES, FINISHES AND FIXTURES SHOWN ON TYPICAL FLOOR PLA APPLY TO ALL SIMILAR, SYMMETRICAL, OR OPPOSITE HAND SECTIO | | | | | | | |
| DRAWINGS, SAMPLI | ARCHITECT FOR REVIEW (PRIOR TO CONSTRUCTION) ALL REQUIRE ES, AND PRODUCT INFORMATION AS CALLED FOR BY THE PROJECT | | | | | | | |
| | BE TAKEN AT ALL TIMES TO PROTECT THE OWNER'S SITE AND PROP | ERTY. | | | | | | |
| | RGY COMPLIANCE DE INSULATION WITH VAPOR BARRIER AS INDICATED IN DRAWINGS MANUFACTURER'S INSTRUCTIONS TO MEET FOLLOWING MINIMUM | | | | | | | |
| | SE INDICATED ON THE DRAWINGS): LIEC R-30 | | | | | | | |
| CEILING WITH ATTIC | R-60 8: R-30 | | | | | | | |
| SLEEPING ROOM IN ROOM; IN EACH RO | ORS: CTOR/CARBON MONOXIDE DETECTOR SHALL BE INSTALLED OUTSI THE IMMEDIATE VICINITY OR WITHIN 15' OF THE ENTRANCE TO A S OM USED FOR SLEEPING PURPOSES AND ON EACH STORY WITHIN ELOW GRADE STORIES. | LEEPING | | | | | | |
| IN DWELLING UNITS | TORS SHALL BE REQUIRED IN THE HALLWAY AND IN THE ROOM TO SWHERE THE CEILING HEIGHT OF A ROOM OPEN TO A HALLWAY SEF DS THAT OF THE HALLWAY BY 24 INCHES OR MORE. | | | | | | | |
| READILY TESTING C | ETECTOR/CARBON MONOXIDE DETECTOR SHALL BE OF TYPE THAT OF SUCH DEVICE. TED DEVICES SHALL BE A MINIMUM DISTANCE OF 4" FROM ANY WALL | | | | | | | |
| MOUNTED DEVICES DETECTORS SHOW | ED DEVICES SHALL BE A MINIMUM DISTANCE OF 4" FROM ANY WALL S SHALL BE A MINIMUM OF 4" AND MAXIMUM OF 12" FROM THE CEILII N IN PLAN FOR APPROXIMATE LOCATION ONLY AND DO NOT INDICA RDINATE LOCATION IN FIELD WITH ARCHITECT. | NG. SD/CO2 | | | | | | |
| | STALLATION OF BATTERY POWERED SMOKE DETECTORS AND CARE ED DURING CONSTRUCTION IN THE VICINITY OF ALTERNATIONS AN | | | | | | | |
| | | | | | | | | |

N 75°09'00" | 157.00'


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19. CALL BEFORE YOU DIG: #1-800-922-4455

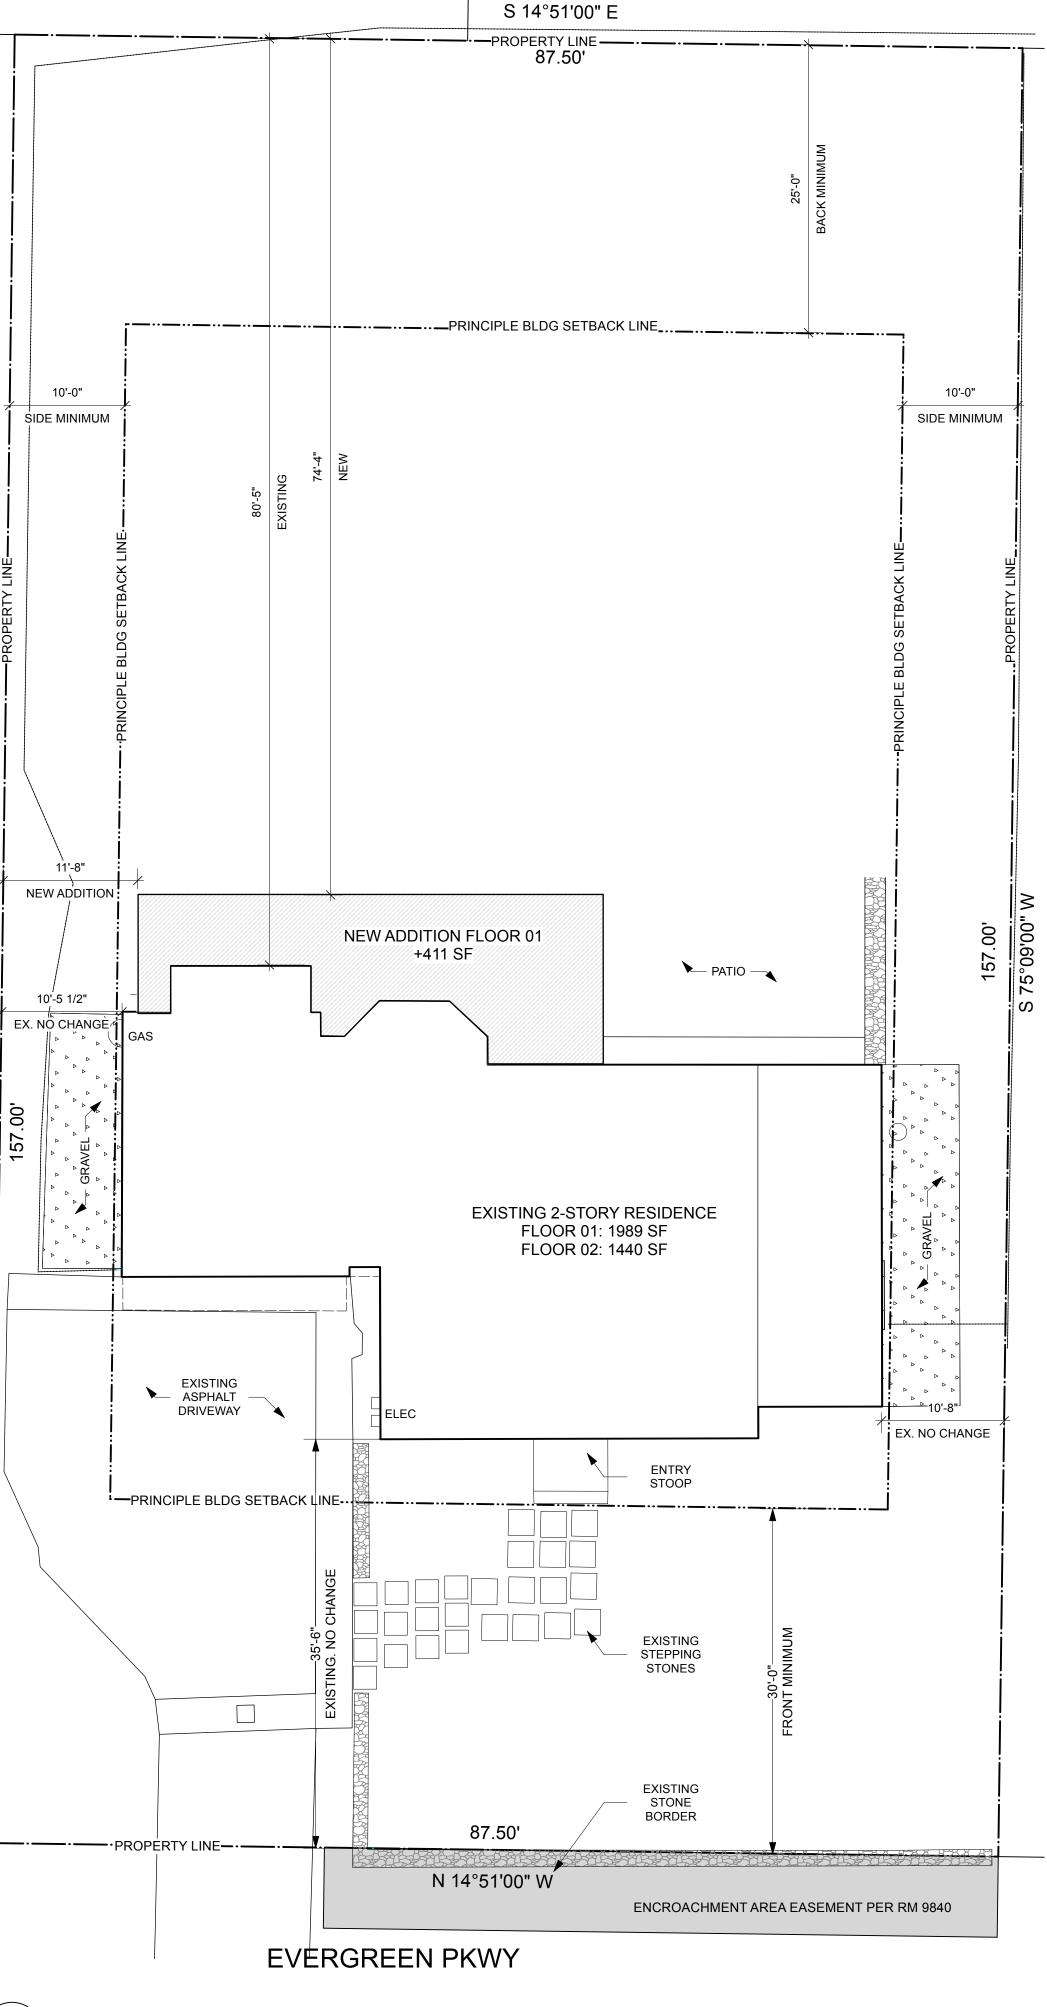



PLOT PLAN - PROPOSED Scale: 1:100



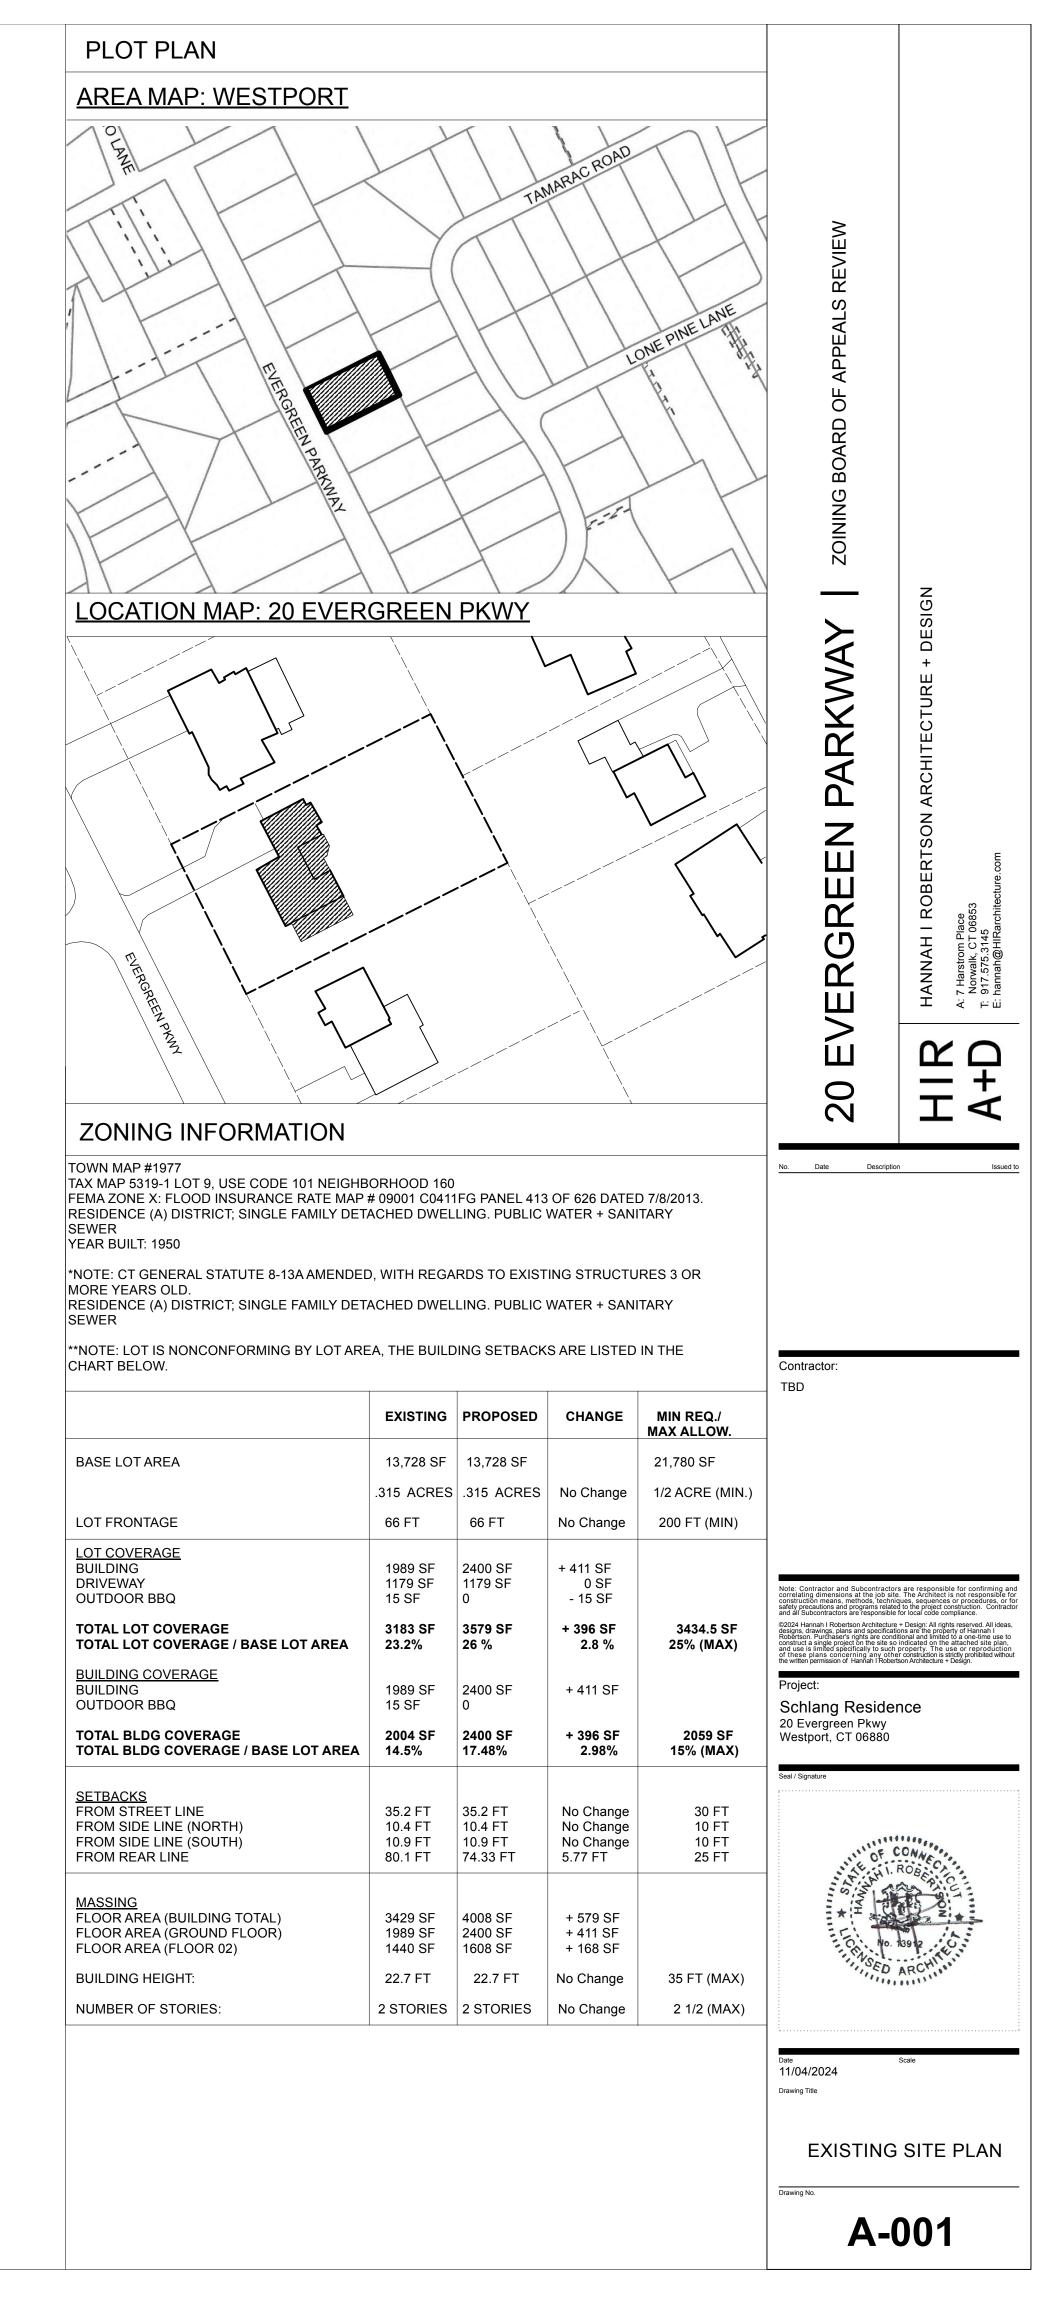


NEW 2 X 12 FLOOR

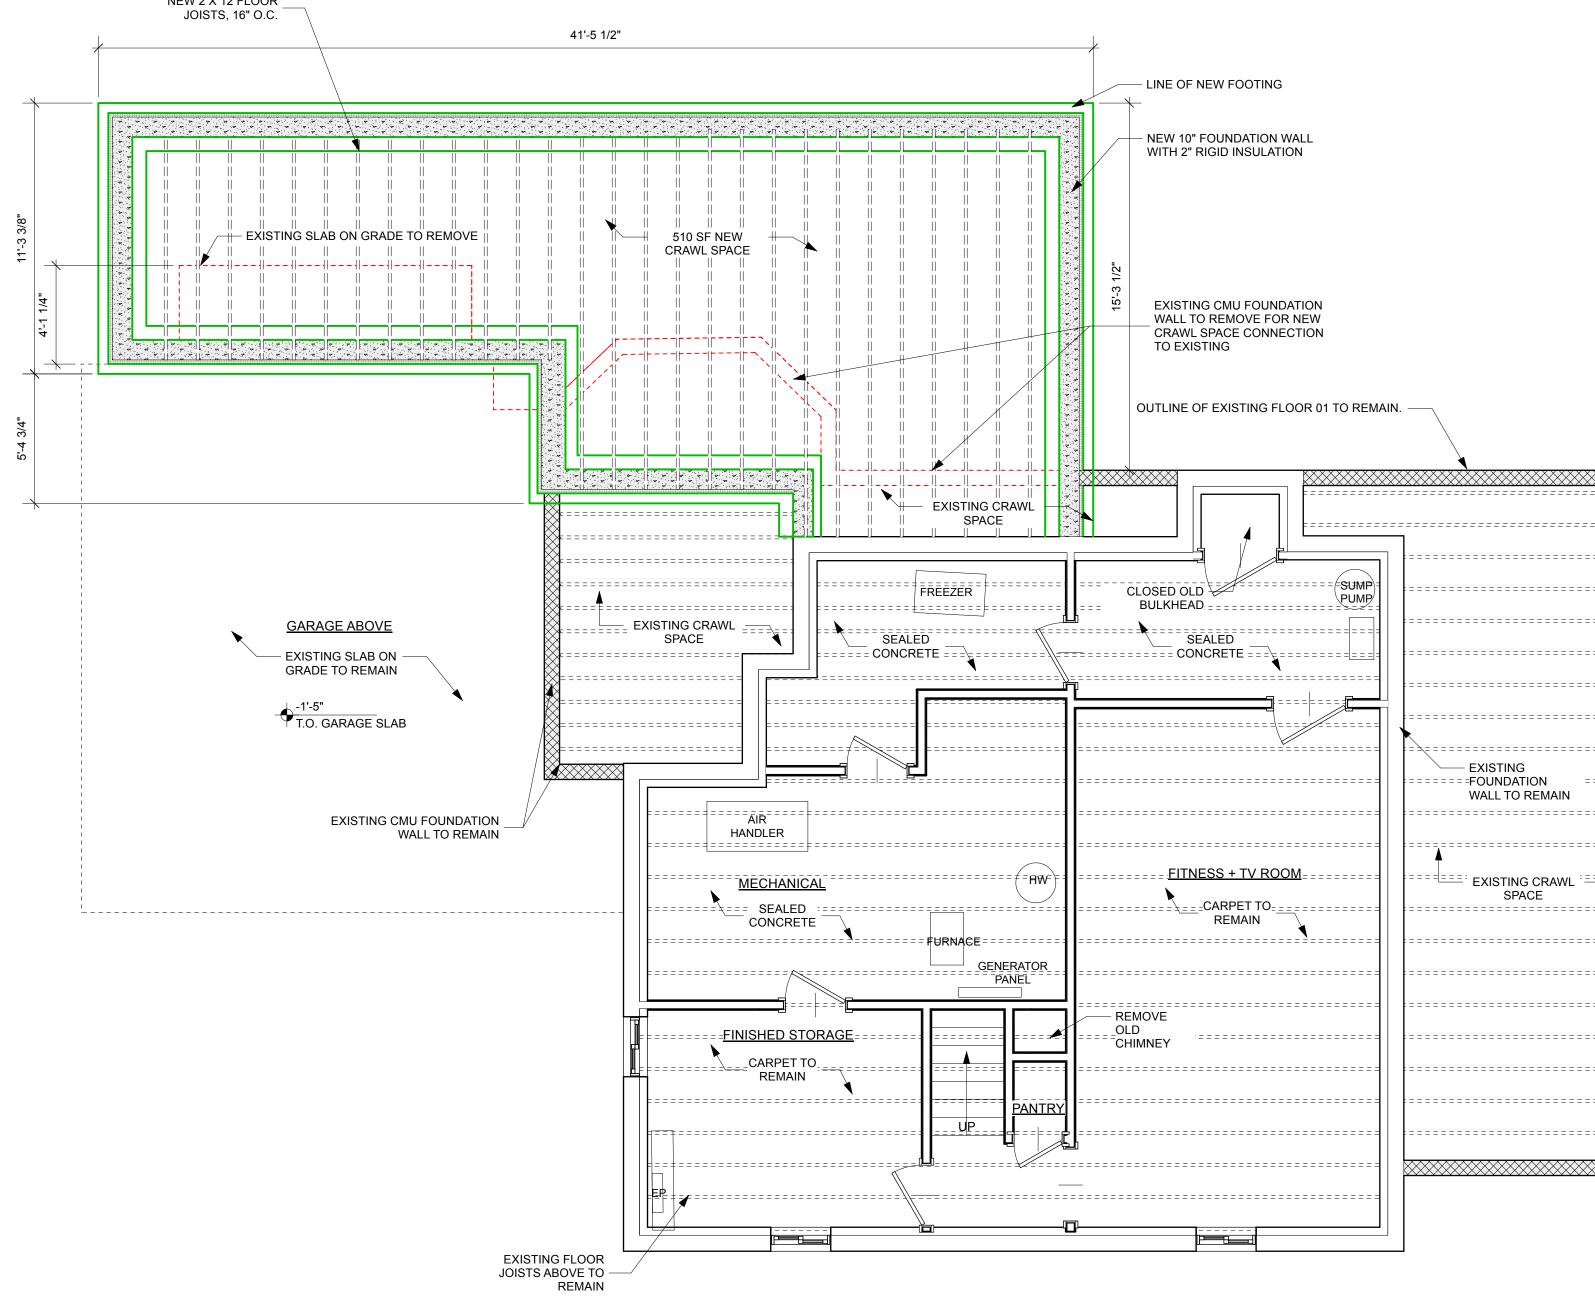


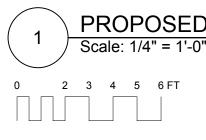



PROPOSED BASEMENT + FOUNDATION PLAN



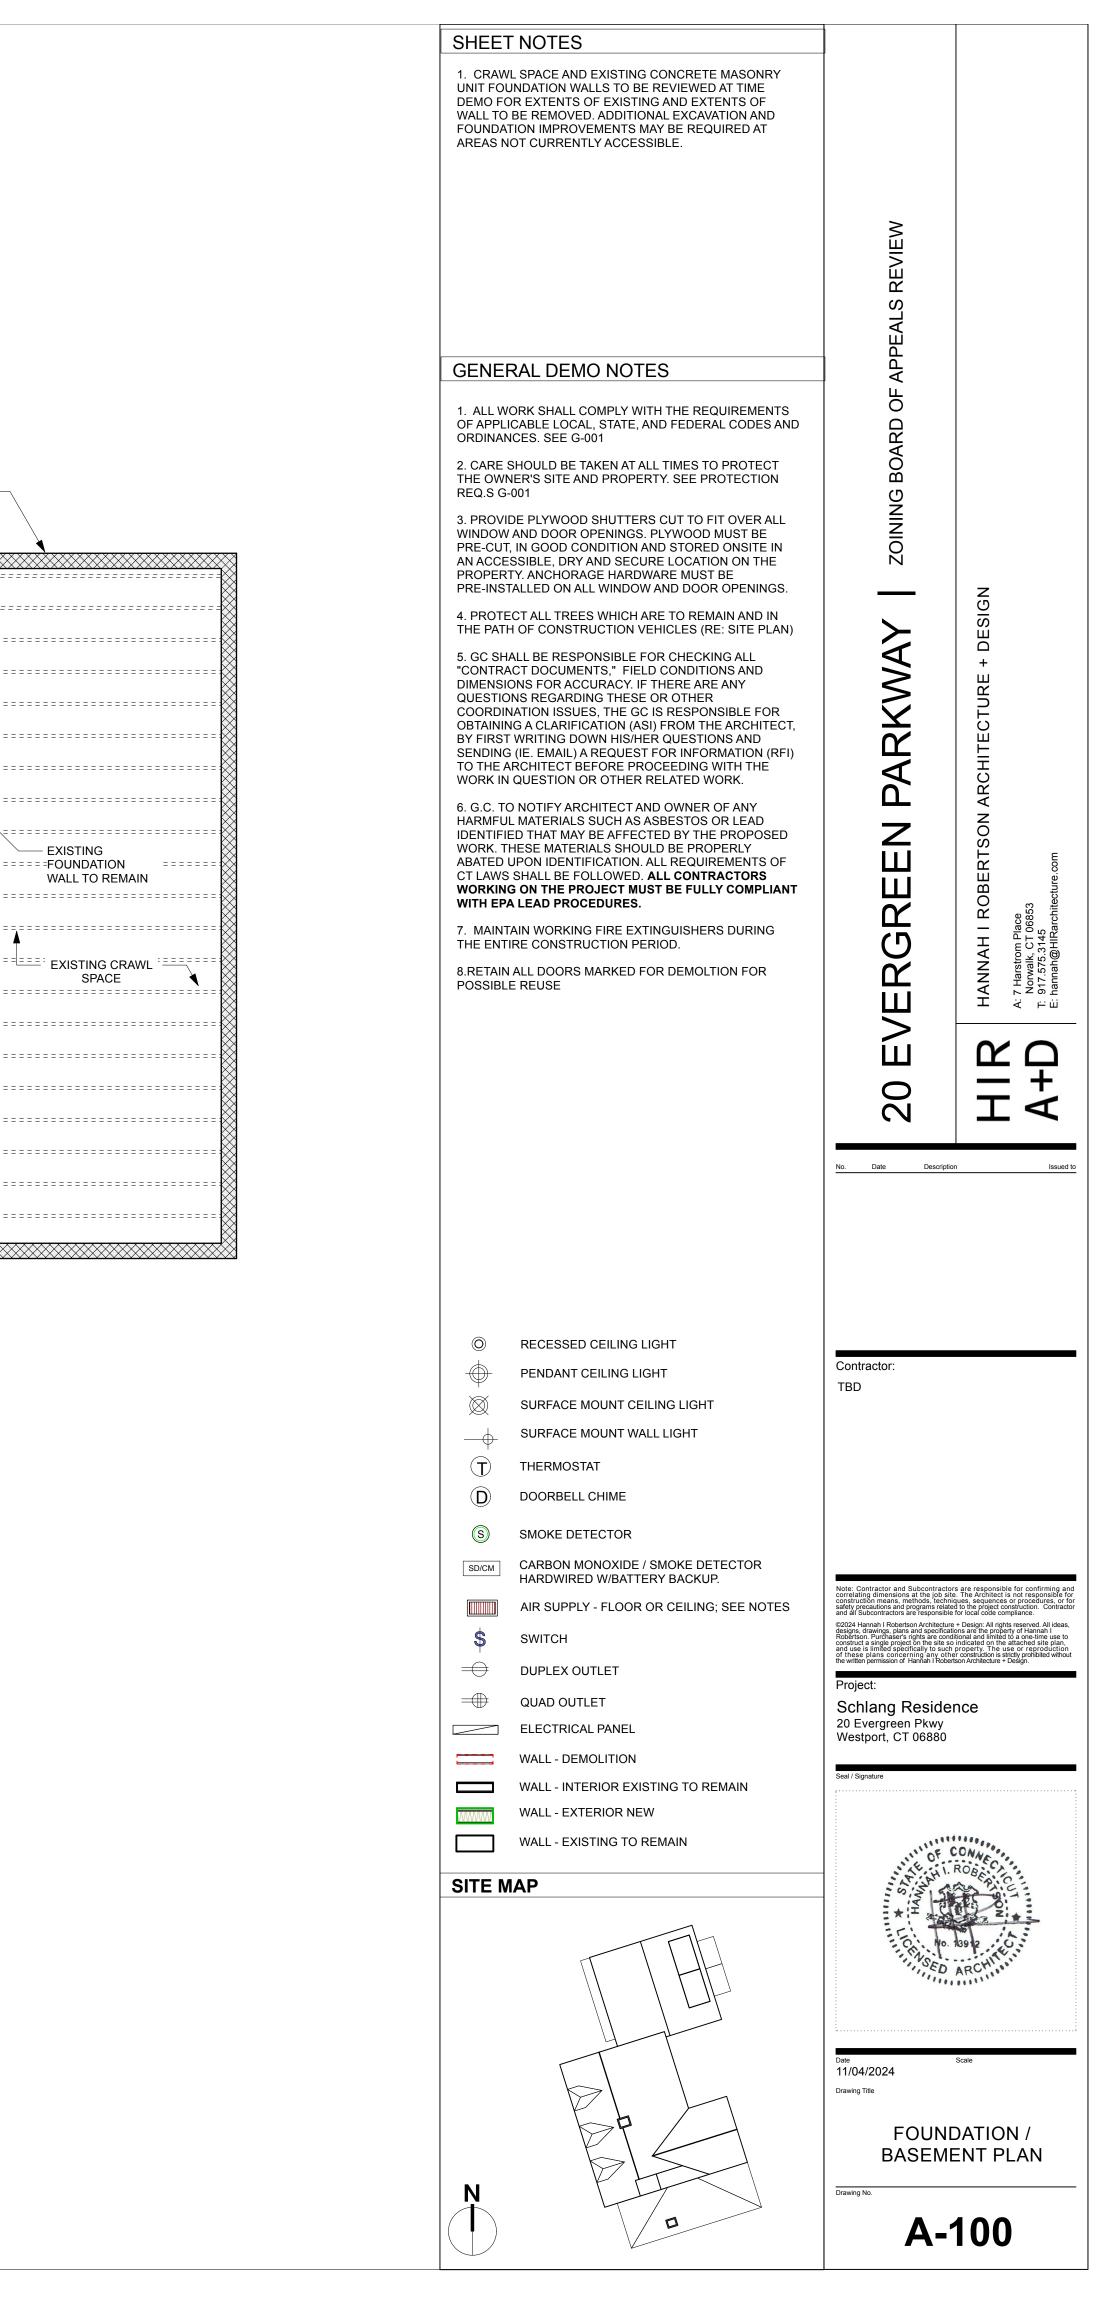


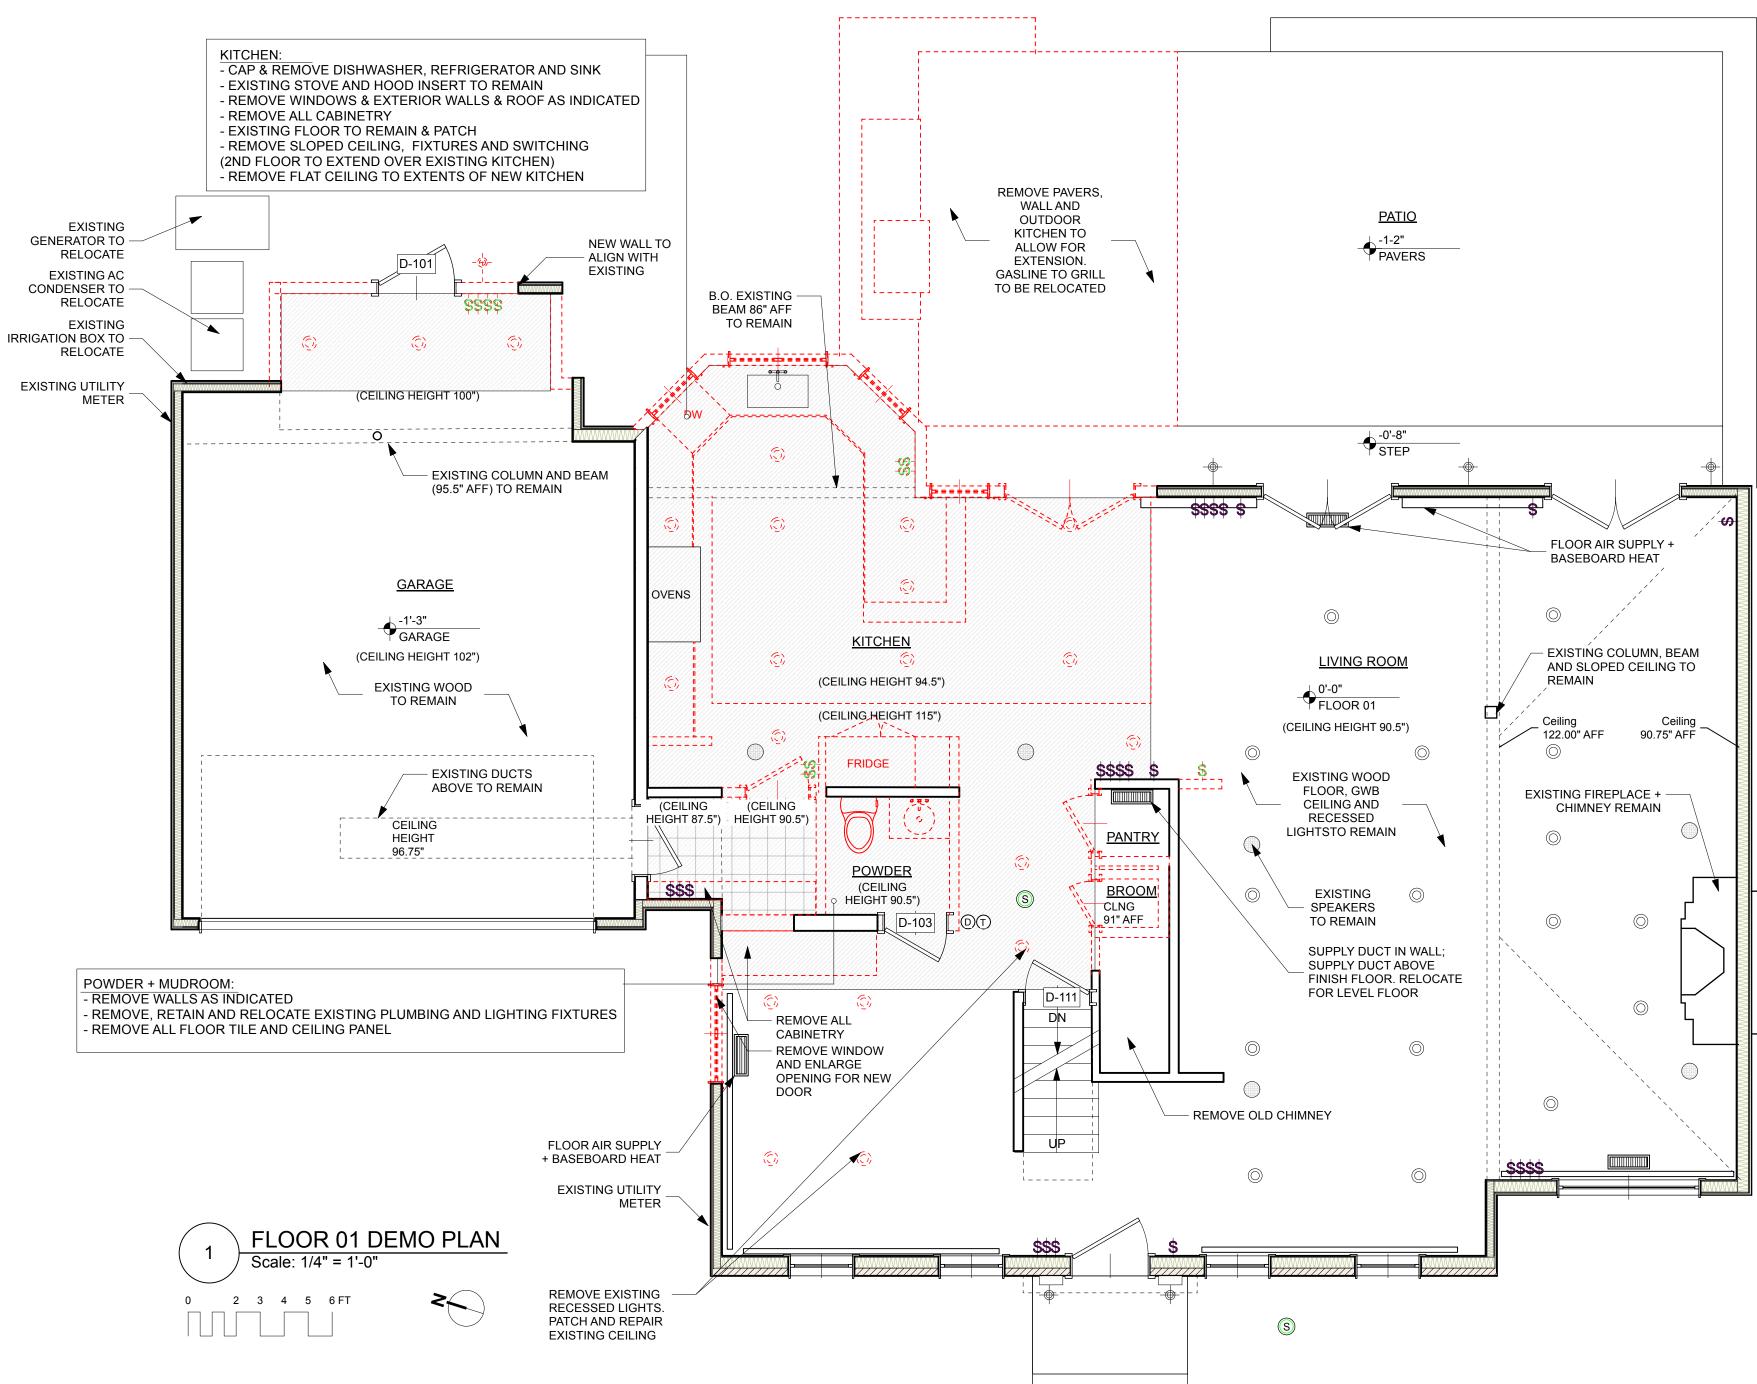

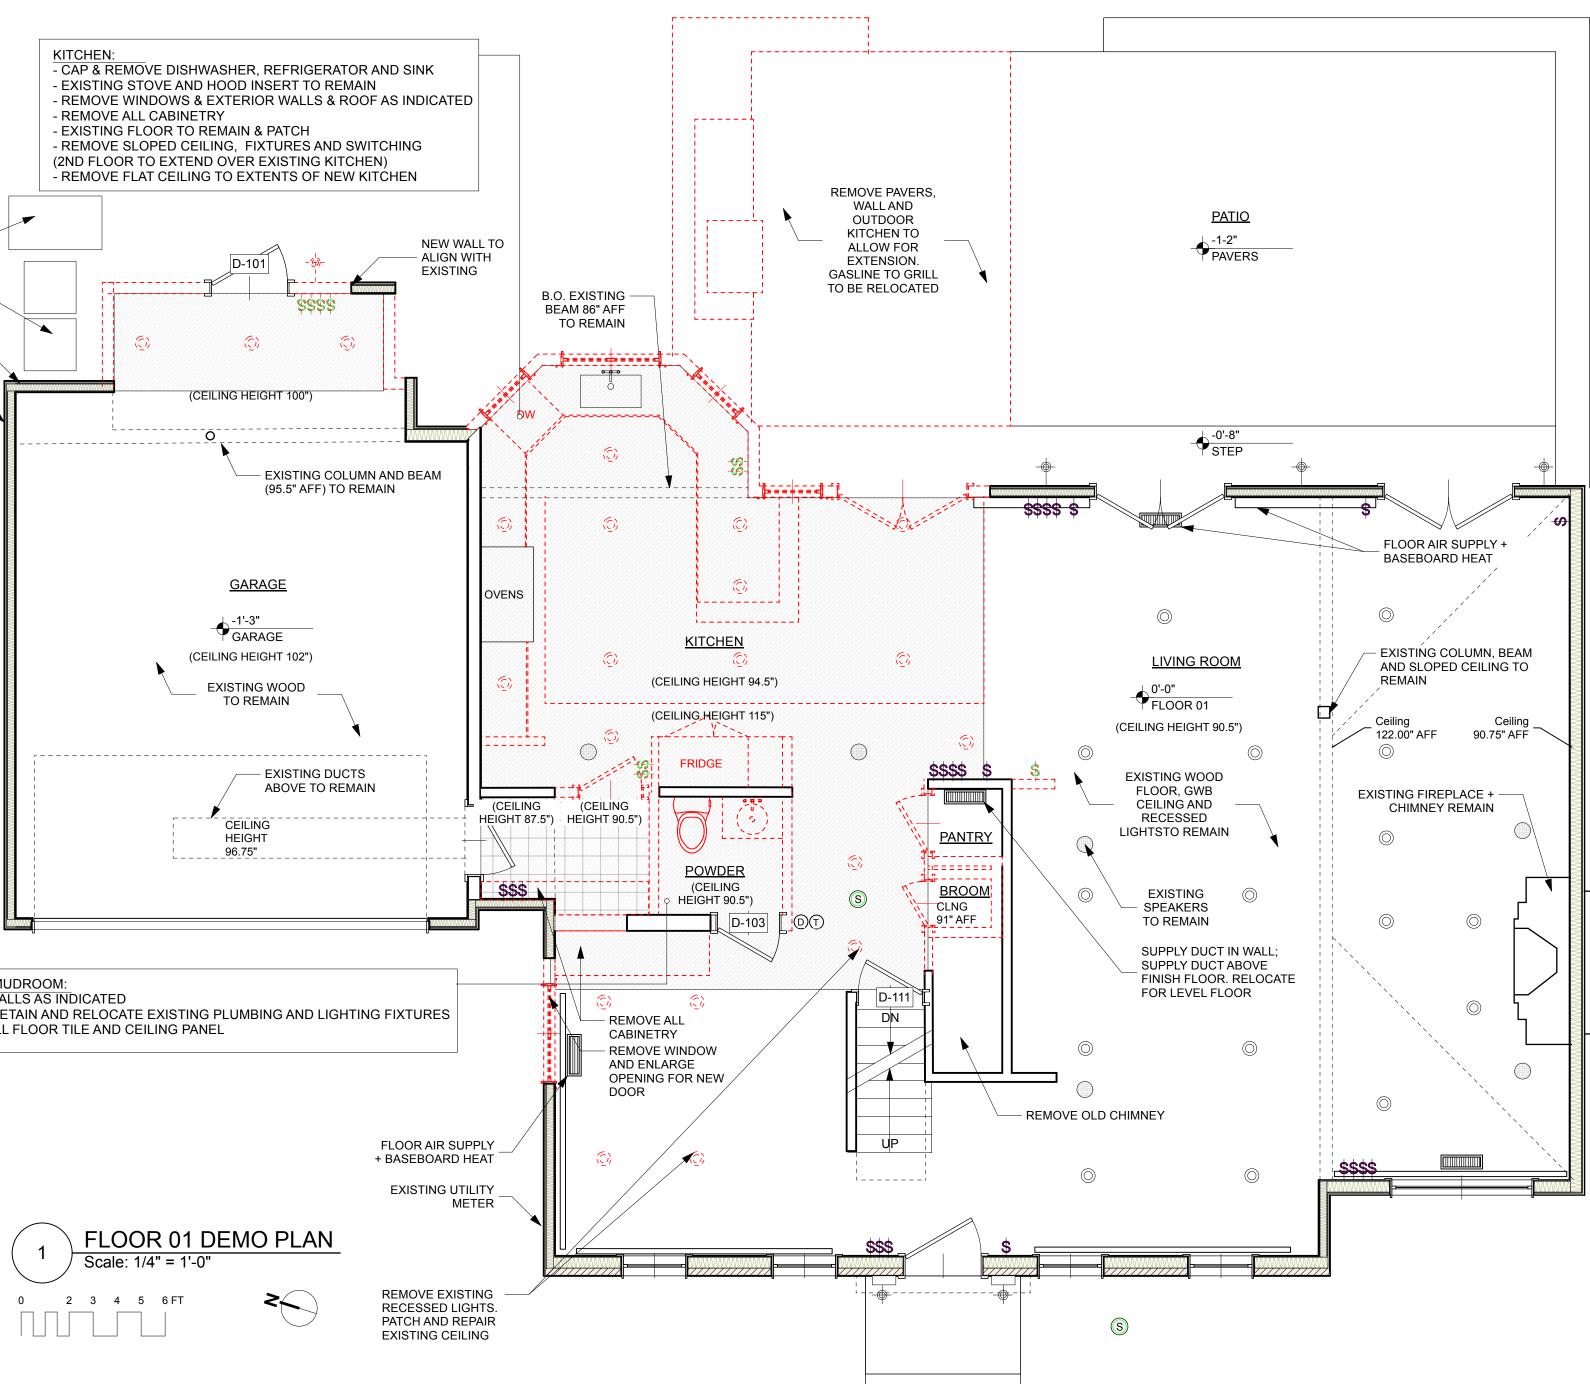

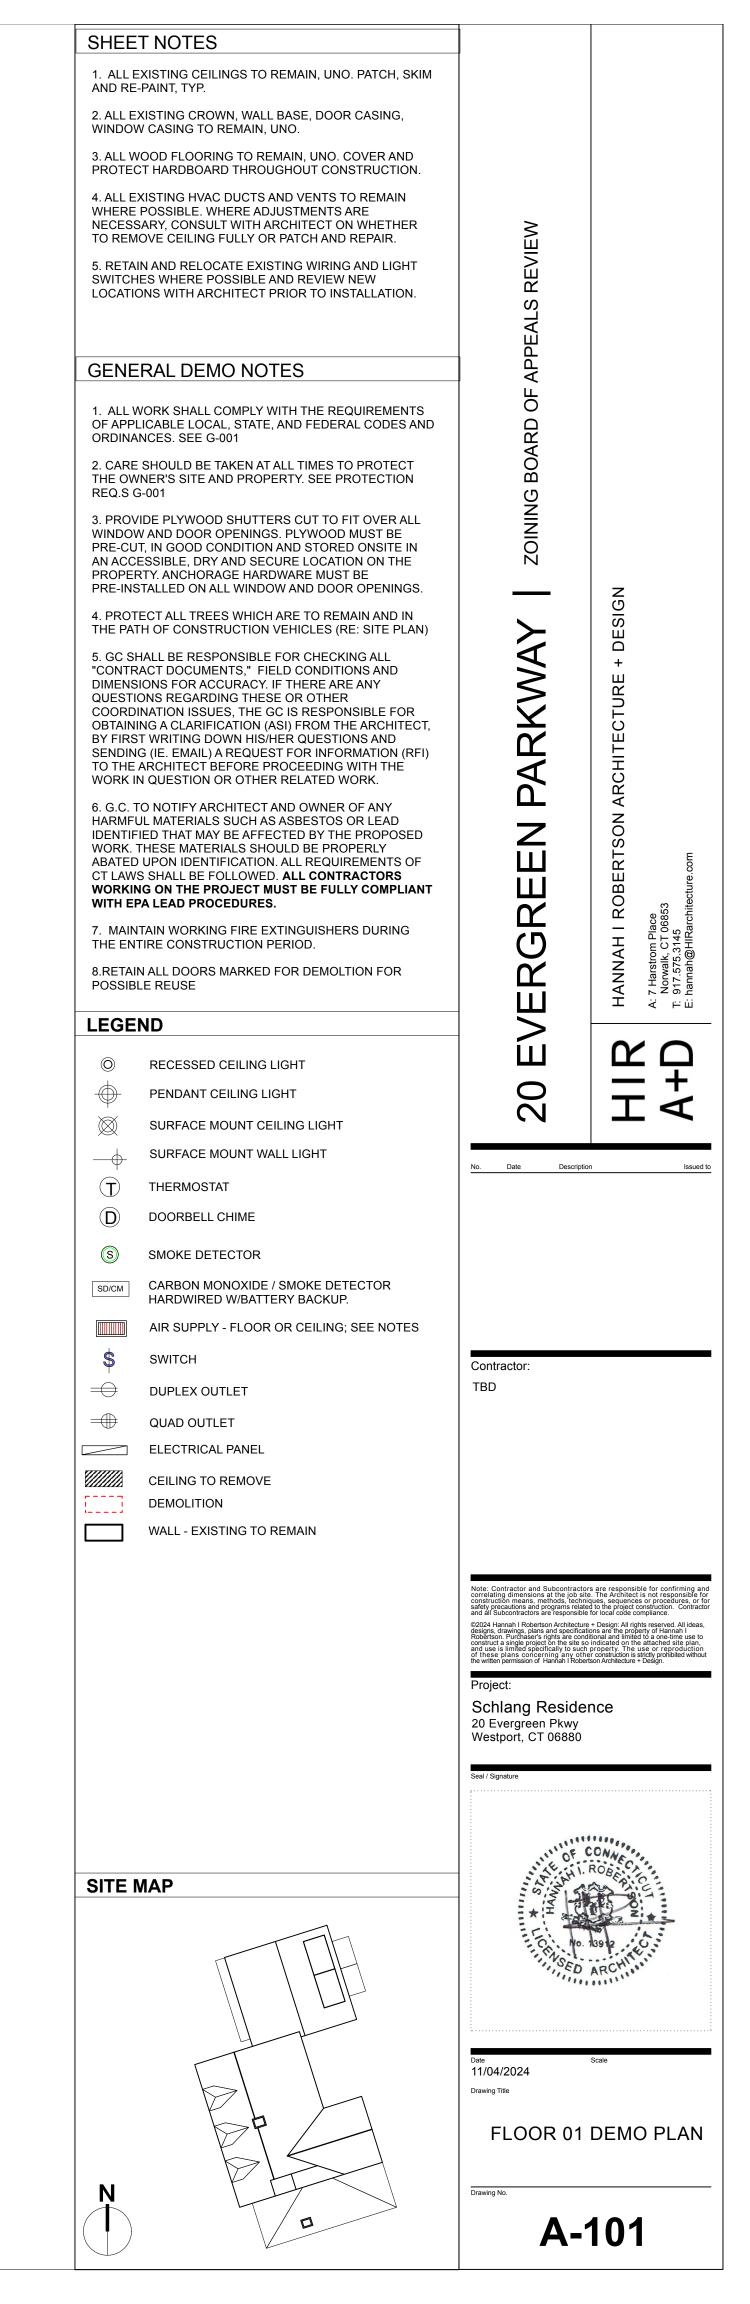




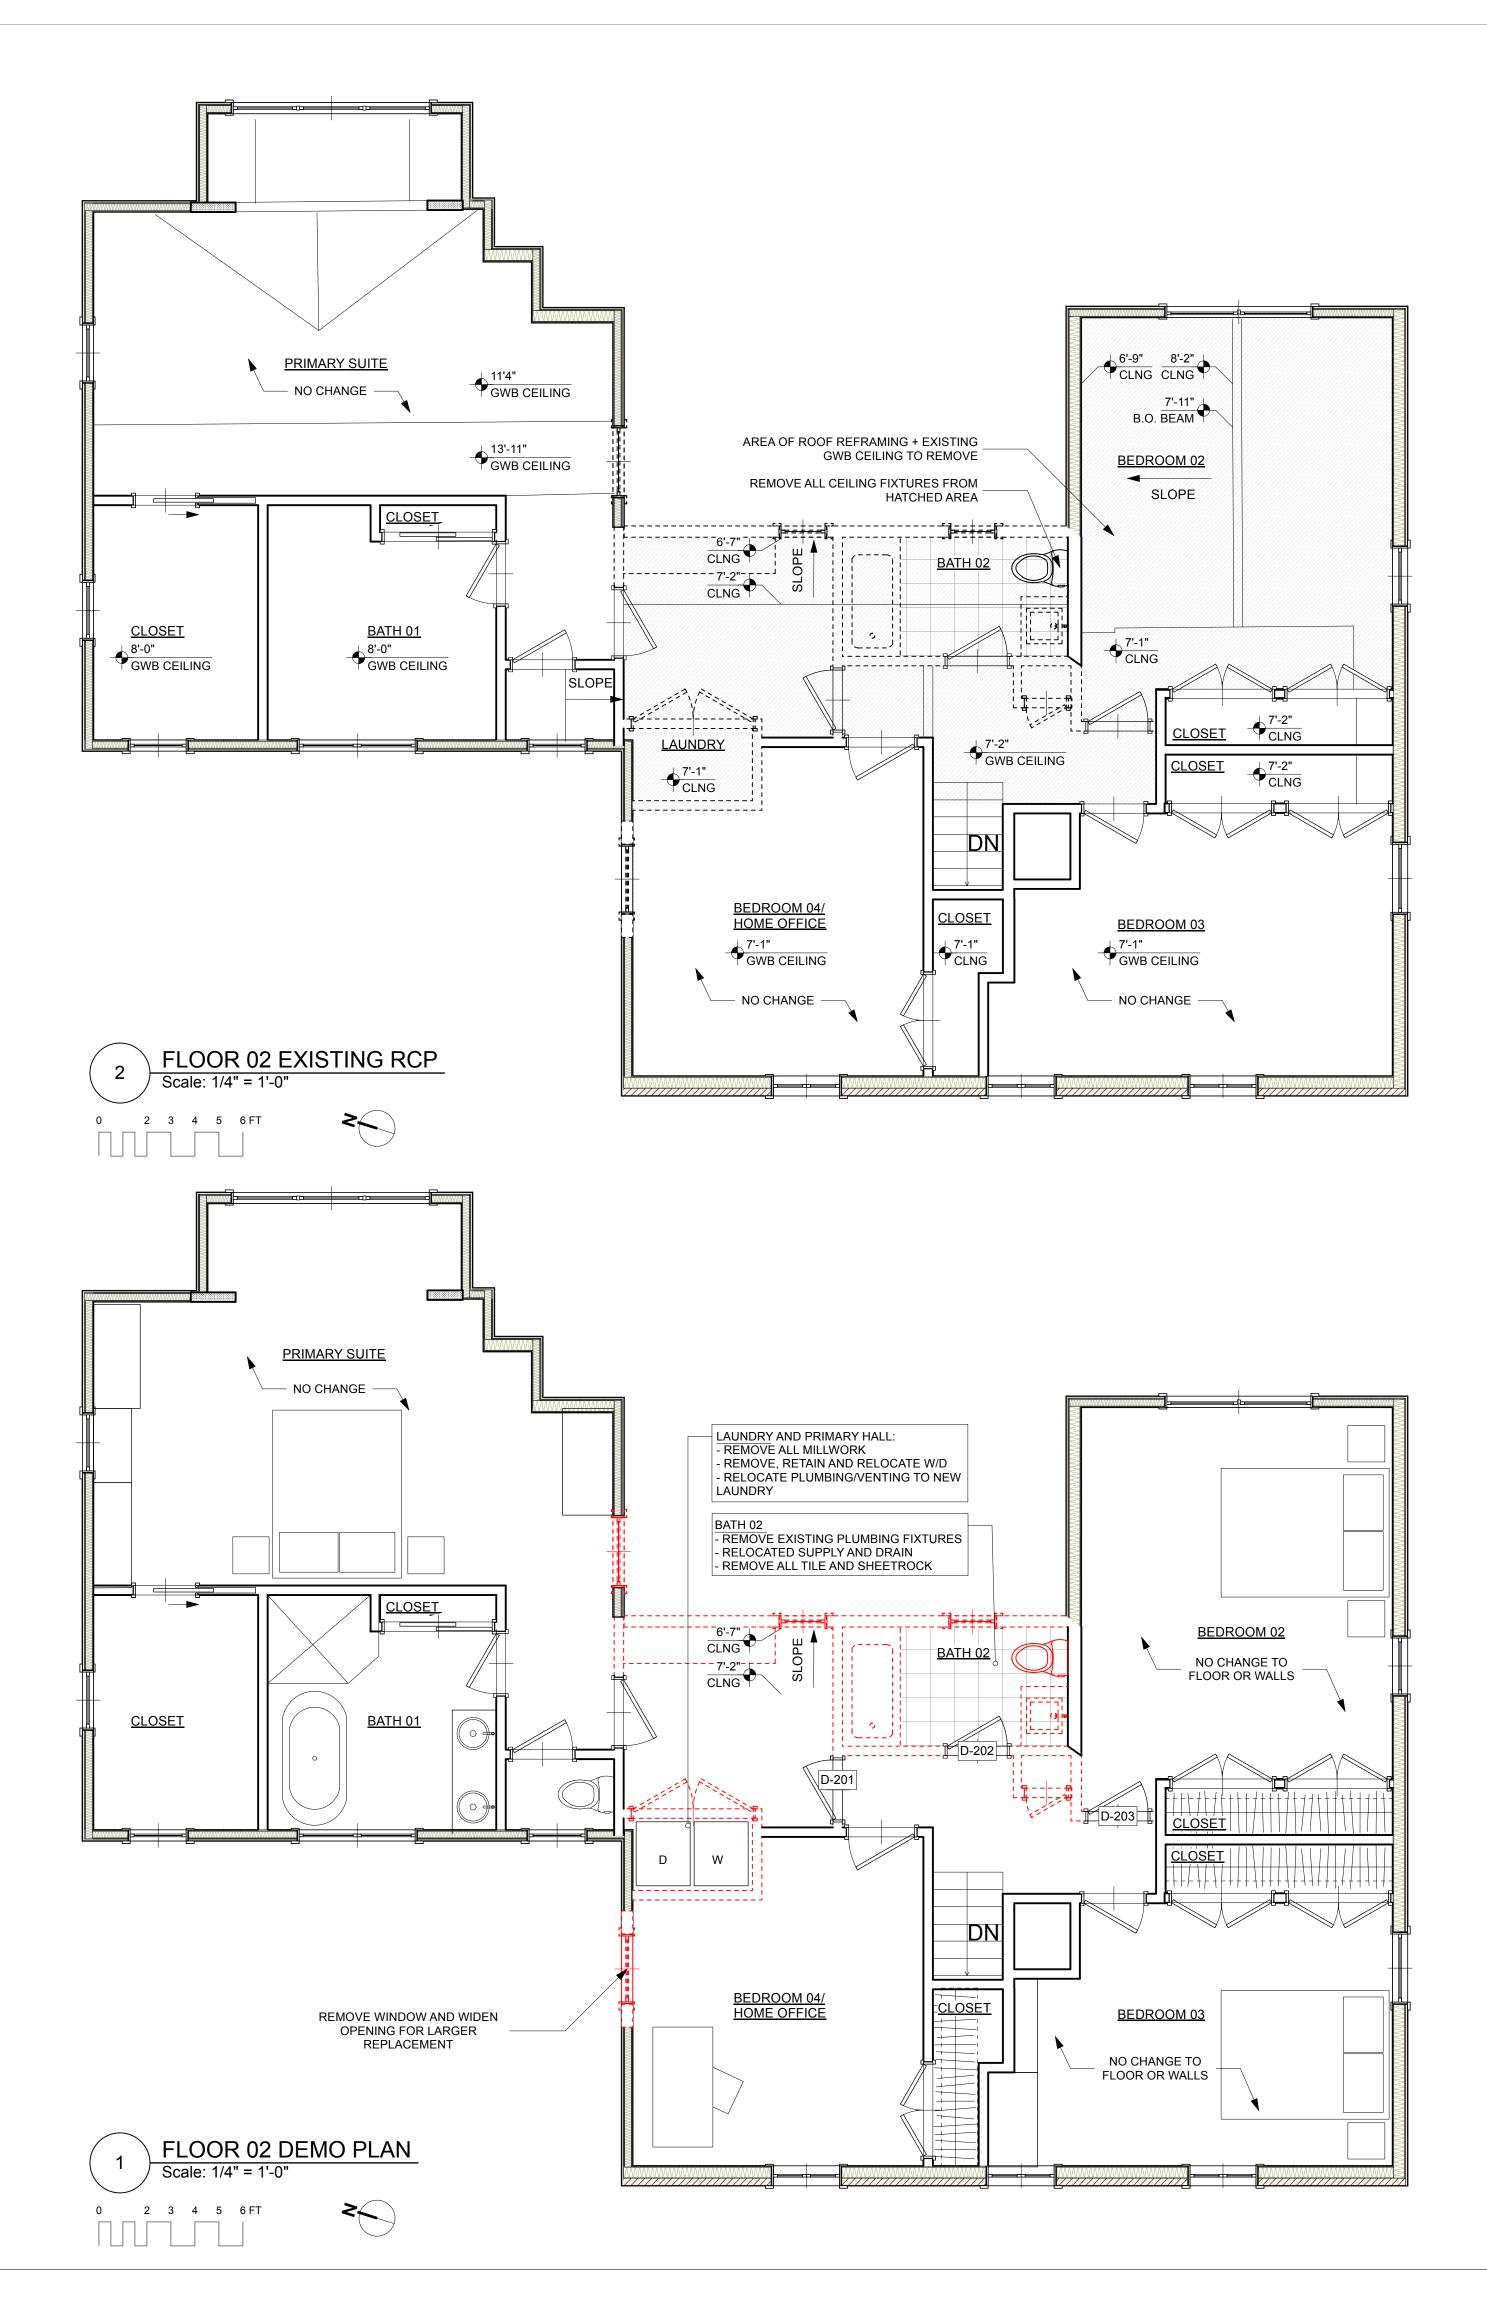


| SHEE | TNOTES | | |
|--|--|--|--|
| 1. ALL E | EXISTING CEILINGS TO REMAIN, UNO. PATCH, SKIM | | |
| | -PAINT, TYP. XISTING CROWN, WALL BASE, DOOR CASING, | | |
| | N CASING TO REMAIN, UNO. | | |
| PROTEC | CT HARDBOARD THROUGHOUT CONSTRUCTION. | | |
| WHERE | POSSIBLE. WHERE ADJUSTMENTS TO REMAIN POSSIBLE. WHERE ADJUSTMENTS ARE SARY, CONSULT WITH ARCHITECT ON WHETHER IOVE CEILING FULLY OR PATCH AND REPAIR. | IEW | |
| SWITCH | IN AND RELOCATE EXISTING WIRING AND LIGHT IES WHERE POSSIBLE AND REVIEW NEW ONS WITH ARCHITECT PRIOR TO INSTALLATION. | -S REVIEW | |
| GENE | RAL DEMO NOTES | APPEALS | |
| OF APPI | VORK SHALL COMPLY WITH THE REQUIREMENTS LICABLE LOCAL, STATE, AND FEDERAL CODES AND NCES. SEE G-001 | RD OF , | |
| - | E SHOULD BE TAKEN AT ALL TIMES TO PROTECT /NER'S SITE AND PROPERTY. SEE PROTECTION G-001 | G BOA | |
| WINDOW PRE-CU AN ACC PROPER | VIDE PLYWOOD SHUTTERS CUT TO FIT OVER ALL W AND DOOR OPENINGS. PLYWOOD MUST BE T, IN GOOD CONDITION AND STORED ONSITE IN ESSIBLE, DRY AND SECURE LOCATION ON THE RTY. ANCHORAGE HARDWARE MUST BE STALLED ON ALL WINDOW AND DOOR OPENINGS. | ZOINING BOARD OF | z |
| | ECT ALL TREES WHICH ARE TO REMAIN AND IN TH OF CONSTRUCTION VEHICLES (RE: SITE PLAN) | → → | ESIG |
| "CONTR DIMENS QUESTI COORD OBTAIN BY FIRS SENDIN TO THE | HALL BE RESPONSIBLE FOR CHECKING ALL ACT DOCUMENTS," FIELD CONDITIONS AND HONS FOR ACCURACY. IF THERE ARE ANY ONS REGARDING THESE OR OTHER INATION ISSUES, THE GC IS RESPONSIBLE FOR ING A CLARIFICATION (ASI) FROM THE ARCHITECT, FT WRITING DOWN HIS/HER QUESTIONS AND G (IE. EMAIL) A REQUEST FOR INFORMATION (RFI) ARCHITECT BEFORE PROCEEDING WITH THE N QUESTION OR OTHER RELATED WORK. | PARKWAY | □ + |
| 6. G.C. 1 HARMFU IDENTIF WORK. ABATED CT LAW WORKIN | TO NOTIFY ARCHITECT AND OWNER OF ANY JL MATERIALS SUCH AS ASBESTOS OR LEAD TIED THAT MAY BE AFFECTED BY THE PROPOSED THESE MATERIALS SHOULD BE PROPERLY DUPON IDENTIFICATION. ALL REQUIREMENTS OF S SHALL BE FOLLOWED. ALL CONTRACTORS NG ON THE PROJECT MUST BE FULLY COMPLIANT | Z Ш | HANNAH I ROBERTSON ARCHITECTURE Norwalk, CT 06853 f: 917.575.3145 c: hannah@HIRarchitecture.com |
| 7. MAIN | PA LEAD PROCEDURES. ITAIN WORKING FIRE EXTINGUISHERS DURING | | I I RO Place r 06853 45 Rarchited |
| | TIRE CONSTRUCTION PERIOD. N ALL DOORS MARKED FOR DEMOLTION FOR | | ANNAH I F Annah I F Harstrom Place Norwalk, CT 0686 917.575.3145 hannah@HIRarch |
| POSSIB | LE REUSE | | HAN A: 7 Hs Nor E: han |
| | RECESSED CEILING LIGHT PENDANT CEILING LIGHT SURFACE MOUNT CEILING LIGHT SURFACE MOUNT WALL LIGHT | 20 EVERGRE | HIR A+D |
| $ \rightarrow$ | THERMOSTAT | No. Date Descripti | on Issued to |
| | DOORBELL CHIME | | |
| S | SMOKE DETECTOR | | |
| SD/CM | CARBON MONOXIDE / SMOKE DETECTOR HARDWIRED W/BATTERY BACKUP. | | |
| | AIR SUPPLY - FLOOR OR CEILING; SEE NOTES | | |
| \$ | SWITCH | Contractor: | |
| | | TBD | |
| | QUAD OUTLET ELECTRICAL PANEL | | |
| | CEILING TO REMOVE DEMOLITION | | |
| | WALL - EXISTING TO REMAIN | | |
| | | Note: Contractor and Subcontractor correlating dimensions at the job si | ors are responsible for confirming and te. The Architect is not responsible for |
| | | construction means, methods, techn safety precautions and programs relat and all Subcontractors are responsibl ©2024 Hannah I Robertson Architectur designs, drawings, plans and specifica | ors are responsible for confirming and the. The Architect is not responsible for inques, sequences or procedures, or for et to the project construction. Contractor e for local code compliance. e + Design: All rights reserved. All ideas, figns are the property of Hannah I |
| | | Robertson. Purchaser's rights are con construct a single project on the site s and use is limited specifically to such of these plans concerning any oth the written permission of Hannah I Robe | e + Design: All rights reserved. All ideas, tions are the property of Harmah I ditional and limited to a one-time use to o indicated on the attached site plan, n property. The use or reproduction rer construction is strictly prohibited without rtson Architecture + Design. |
| | | Project: Schlang Reside | ence |
| | | 20 Evergreen Pkwy Westport, CT 06880 | |
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| 1 | | . – • | OR 02 NG PLAN |

Drawing No.

A-102

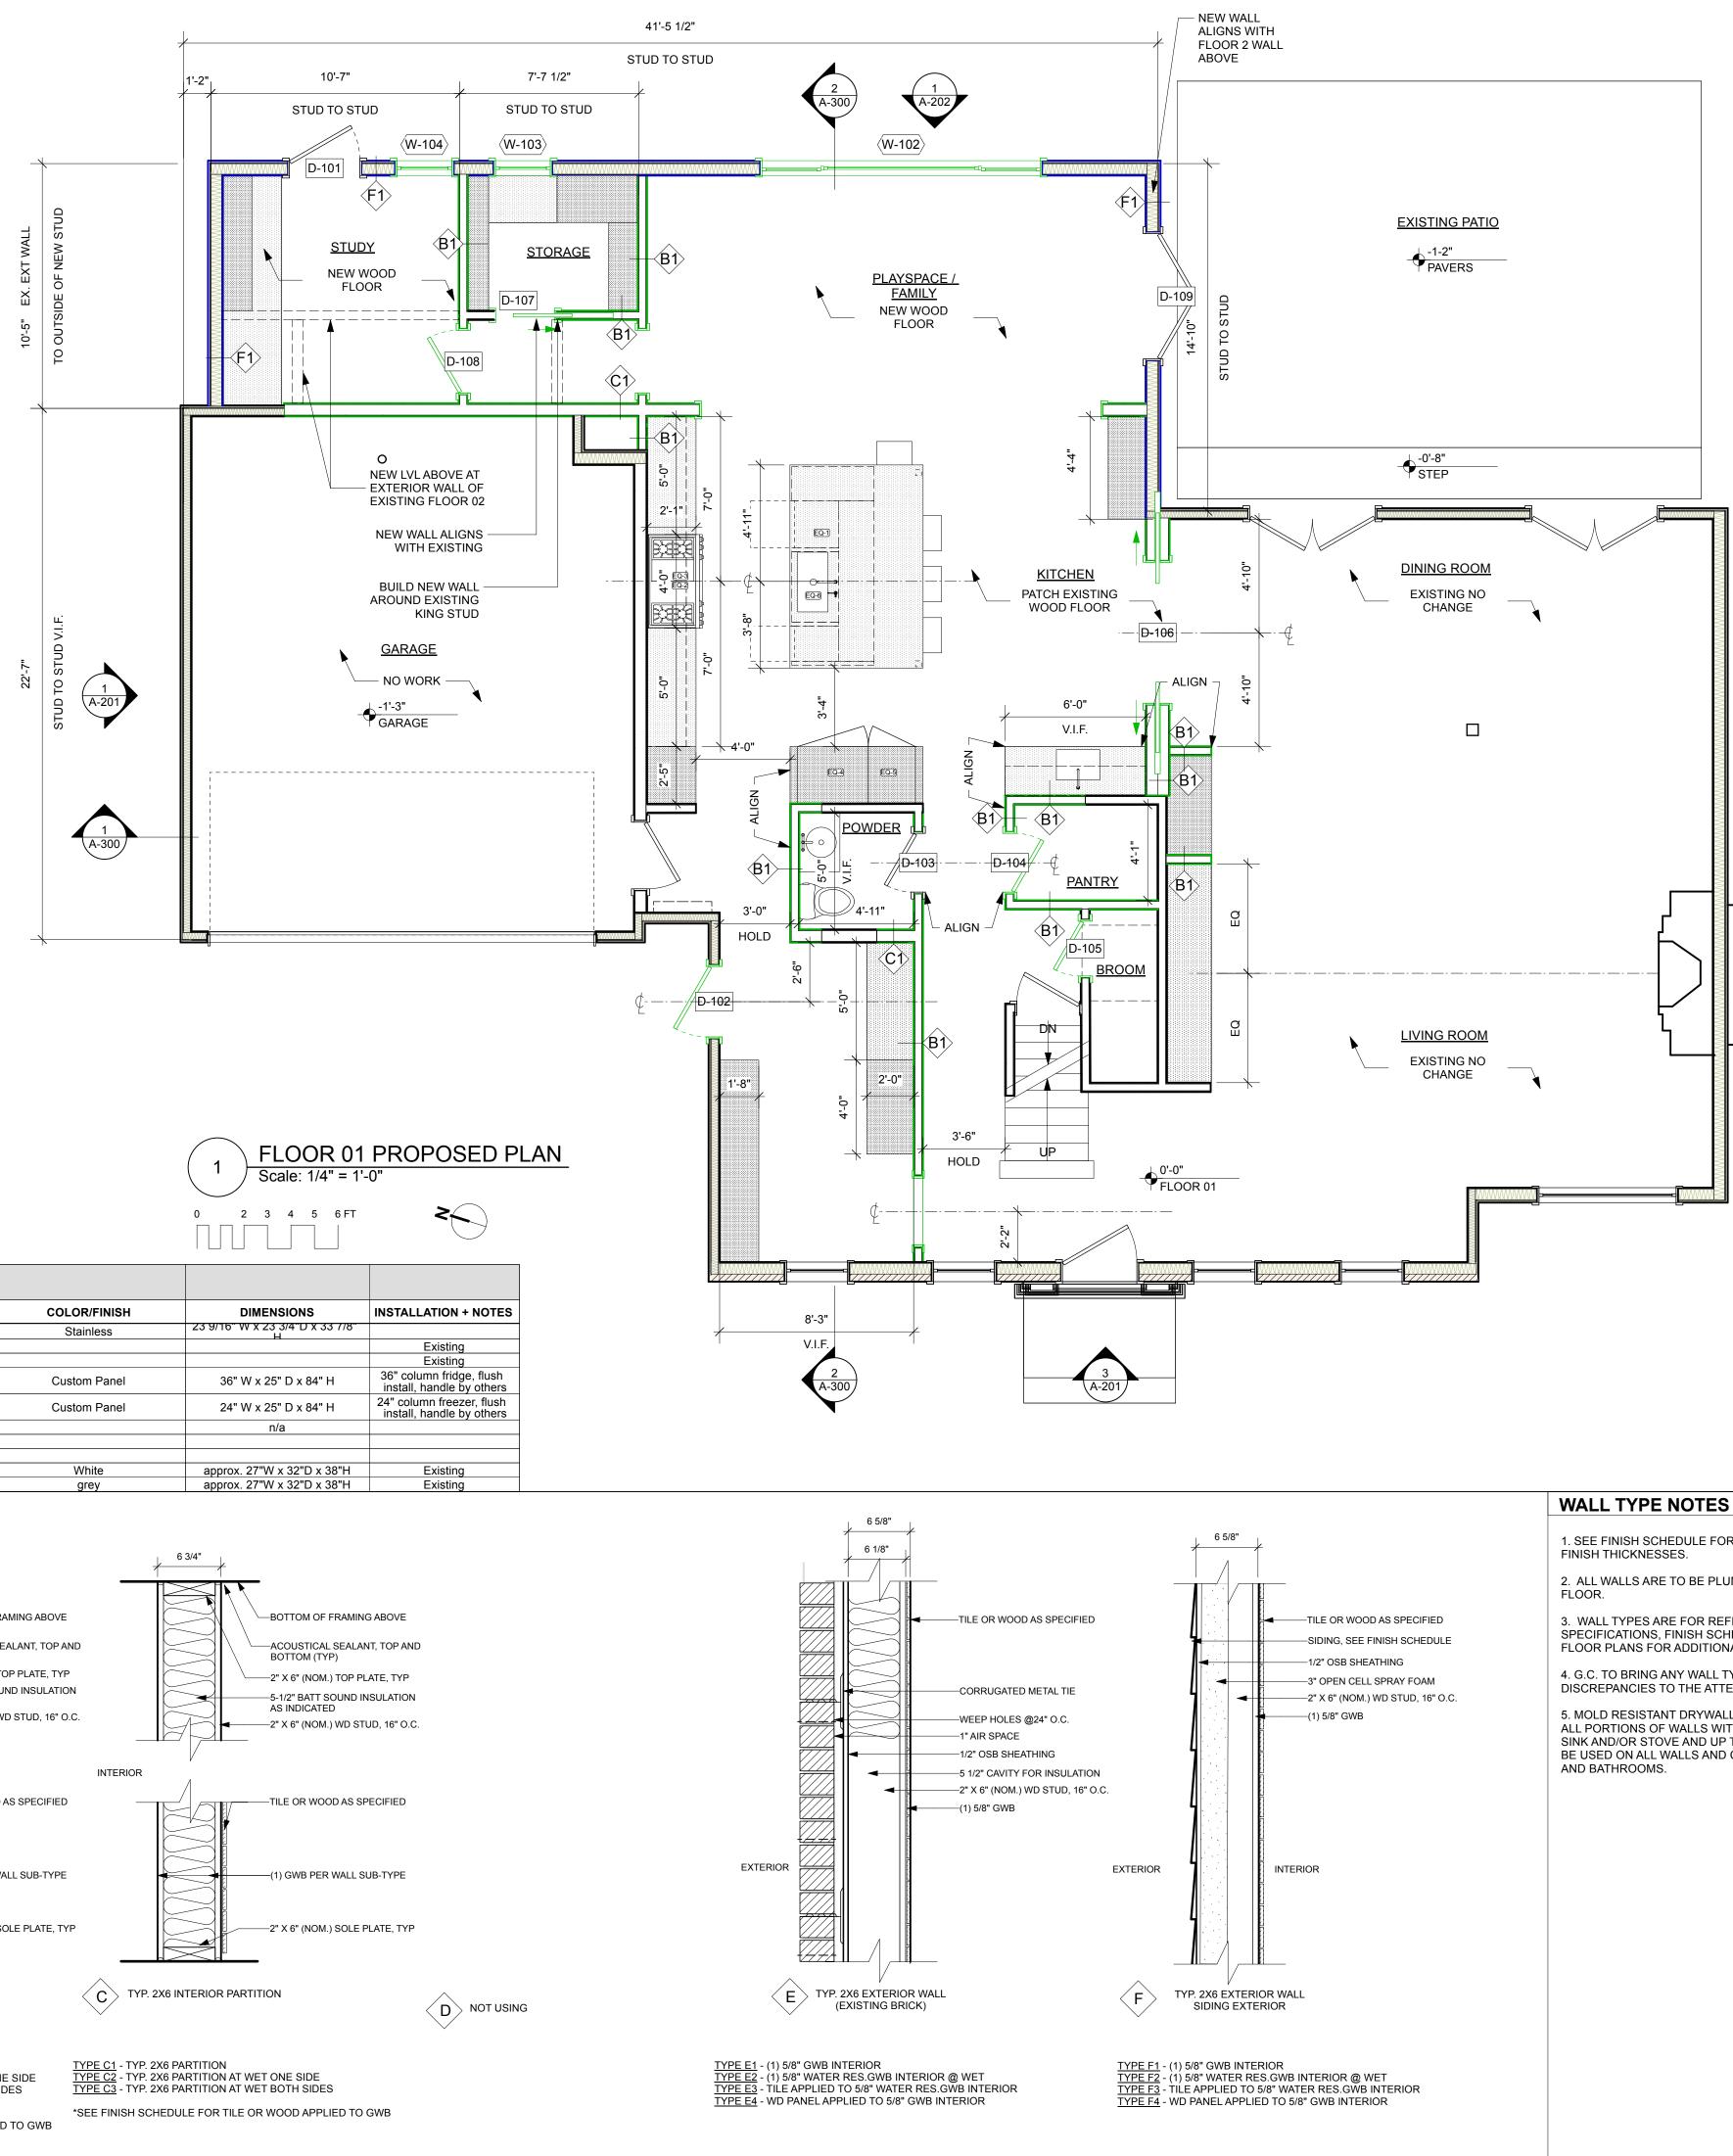

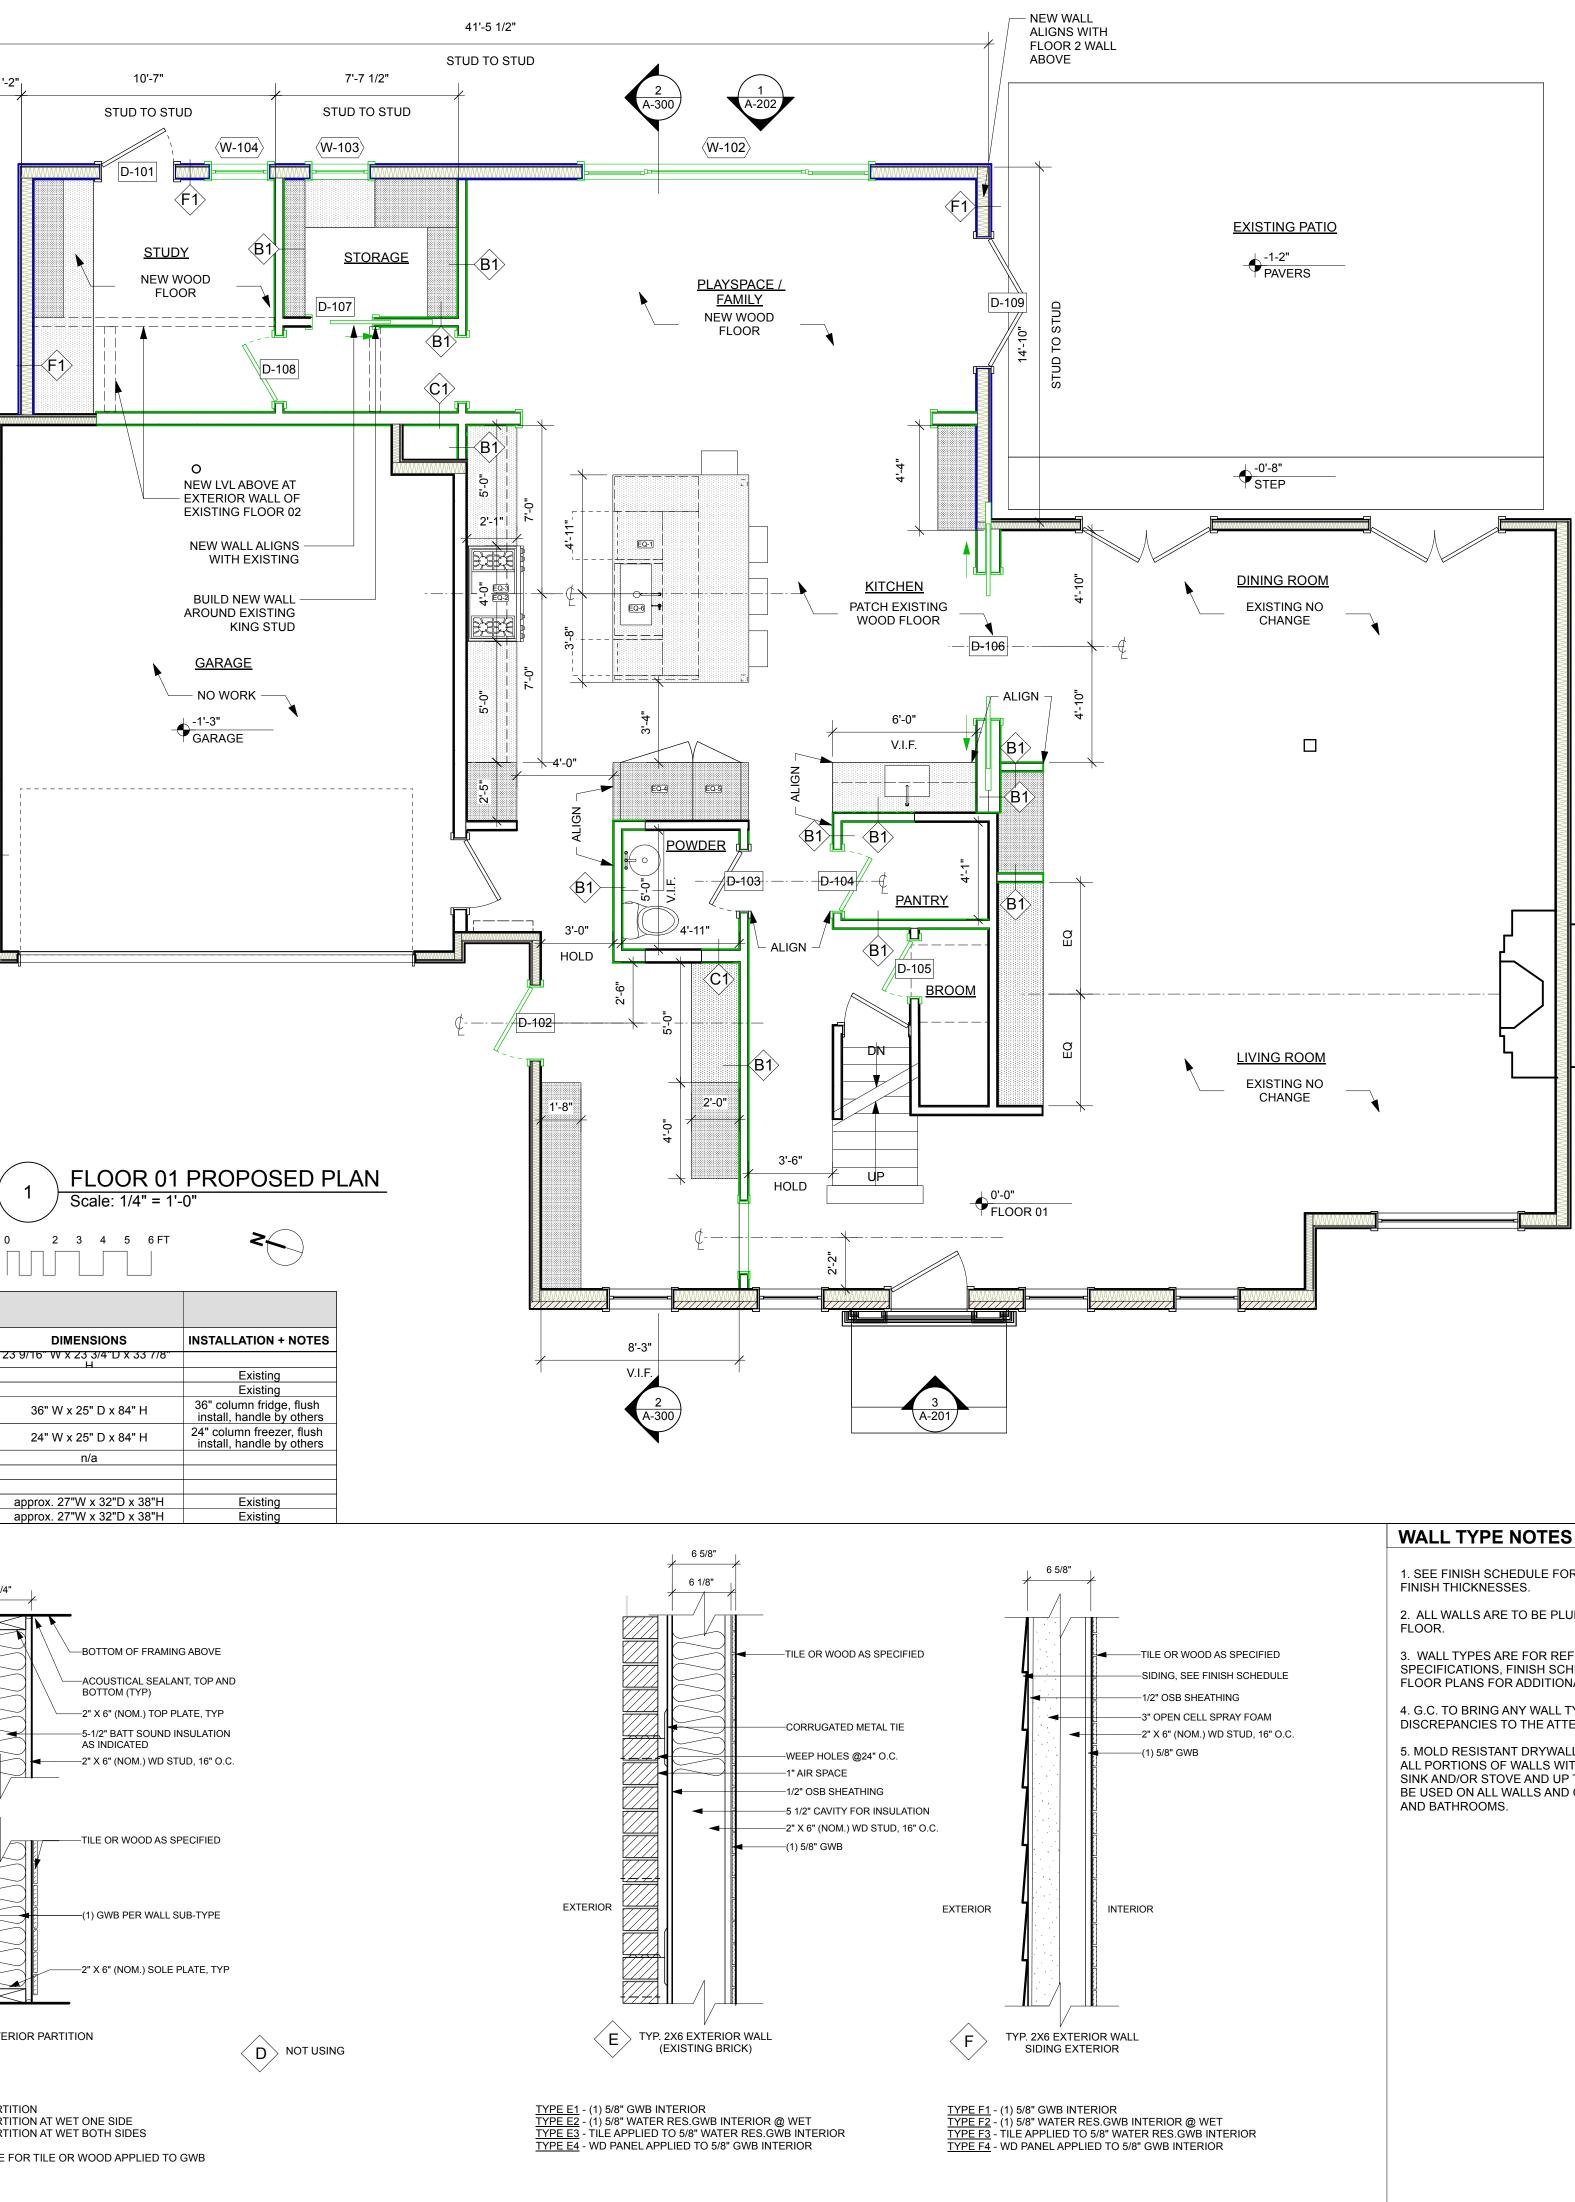

| EQUIF | MENT SC | HEDUL | E | | | | |
|--------------|---|---|--|---|---|---|---|
| TAG | LOCATION | QTY | APPLIANCE | MANUF. | MODEL | COLOR/FINISH | DIMENSIONS INS [®] |
| EQ-1 | KITCHEN | 1 | Dishwasher | Bosch | SHE53C85N | Stainless | 23 9/16" W X 23 3/4"D X 33 7/8" H |
| EQ-2 | KITCHEN | 1 | 48" Range | Wolf | | | |
| EQ-3 | KITCHEN | 1 | 48" Hood insert | | | | |
| EQ-4 | KITCHEN | 1 | Refrigerator | Subzero | DEC3650RID/L | Custom Panel | 36" W x 25" D x 84" H |
| EQ-5 | KITCHEN | 1 | Freezer | Subzero | DEC2450FI/L | Custom Panel | 24" W x 25" D x 84" H 24" ins |
| EQ-6 | KITCHEN | 1 | Garbage Disposal | Insinkerator | Evolution | | n/a |
| EQ-7 EQ-8 | | | Microwave Drawer? Wine fridge? | | | | |
| EQ-9 | LAUNDRY | 1 | Wine mage: Washer | Electrolux | | White | approx. 27"W x 32"D x 38"H |
| EQ-01 | LAUNDRY | 1 | Dryer | Maytag | MED6630HC | grey | approx. 27"W x 32"D x 38"H |
| | | | A1: +3/4" STUCCO APPLIEI EXPOSED SIDE OF CONC WALL, SEE ELEVATIONS A2: +THIN VENEER APPLIE EXPOSED SIDE OF CONC WALL, SEE ELEVATIONS 10" CONCRETE WALL, SEE STRUCTURAL DRAWINGS | RETE | ACOUSTICAL BOTTOM (TYF -2" X 4" (NOM.) -3-1/2" BATT SC AS INDICATED |) TOP PLATE, TYP OUND INSULATION | BOTTOM OF FRAMING ABOY ACOUSTICAL SEALANT, TOF BOTTOM (TYP) -2" X 6" (NOM.) TOP PLATE, T -5-1/2" BATT SOUND INSULAT AS INDICATED -2" X 6" (NOM.) WD STUD, 16" |
| | EXTERIOR FROSTLINE | · · · | COND. SPACES ONLY 5/8" MOLD RESISTANT GW 2" X 4" (NOM.) FURRING | /В | | INTERIOR | TILE OR WOOD AS SPECIFIE |
| | • | · · | 3" OPEN CELL SPRAY FOA INSULATION W/ 3 3/4" FUR SEALANT, TOP AND BOTTO (TYP) | RRING | | WALL SUB-TYPE | (1) GWB PER WALL SUB-TYP |
| | A TYP. F | | WALL | B TYP. 2X4 | INTERIOR PARTITION | SOLE PLATE, TYP | 2" X 6" (NOM.) SOLE PLATE, |
| | 3/4" \$ <u>TYPE A2</u> - TYP. STOP <u>TYPE A3</u> - TYP. 3/4" \$ <u>TYPE A4</u> - TYP. | STUCCO FINIS FOUNDATION NE VENEER F FOUNDATION STUCCO FINIS FOUNDATION | SH EXTERIOR | <u>TYPE B3</u> - TYP. 2X4 V T <u>YPE B4</u> - TYP. 2X4 P | PARTITION PARTITION AT WET LOCATION OF VALL AT WET LOCATION BOTH PARTITION AT CHASE WALL ULE FOR TILE OR WOOD APPLI | SIDES <u>TYPE C3</u> - TYP. 23 *SEE FINISH SCH | X6 PARTITION X6 PARTITION AT WET ONE SIDE X6 PARTITION AT WET BOTH SIDES IEDULE FOR TILE OR WOOD APPLIED TO GWB |

1. SEE FINISH SCHEDULE FOR ALL WALL FINISH TYPES AND

2. ALL WALLS ARE TO BE PLUMB, LEVEL, AND SQUARE TO

3. WALL TYPES ARE FOR REFERENCE ONLY, SEE SPECIFICATIONS, FINISH SCHEDULE, WALL SECTIONS, AND FLOOR PLANS FOR ADDITIONAL DETAILS.

4. G.C. TO BRING ANY WALL TYPE OR DIMENSIONAL DISCREPANCIES TO THE ATTENTION OF THE ARCHITECT.

5. MOLD RESISTANT DRYWALL IS REQUIRED TO BE USED ON ALL PORTIONS OF WALLS WITHIN 2 FEET OF A KITCHEN SINK AND/OR STOVE AND UP TO 4 FEET HIGH. MUST ALSO BE USED ON ALL WALLS AND CEILINGS IN LAUNDRY ROOMS

SHEET NOTES

1. INTERIOR DIMENSIONS SHOWN OUTSIDE OF STUD TO OUTSIDE OF STUD. "HOLD TO" DIMENSIONS ARE TO FACE OF FINISH,

2. EXTERIOR DIMENSIONS TO EXTERIOR OF SHEATHING

3. WHERE POSSIBLE, WINDOWS ALIGN ON CENTER WITH THOSE ABOVE AND BELOW. SEE ELEVATIONS FOR ADDITIONAL ALIGNMENT

SMOKE /CO2 DETECTOR NOTES

1. SD/CO2 DETECTORS SHOWN IN PLAN FOR APPROXIMATE LOCATION ONLY AND DO NOT INDICATE CEILING OR WALL MOUNT. COORDINATE LOCATION IN FIELD WITH ARCHITECT.

2. EACH SMOKE DETECTOR/CARBON MONOXIDE DETECTOR SHALL BE INSTALLED OUTSIDE OF EACH SLEEPING ROOM IN THE IMMEDIATE VICINITY OR WITHIN 15' OF THE ENTRANCE TO A SLEEPING ROOM; IN EACH ROOM USED FOR SLEEPING PURPOSES AND ON EACH STORY WITHIN A DWELLING UNIT, INCLUDING BELOW GRADE STORIES.

3. EACH SMOKE DETECTOR/CARBON MONOXIDE DETECTOR SHALL BE OF TYPE THAT ALLOWS FOR READILY TESTING OF SUCH DEVICE.

4. CEILING MOUNTED DEVICES SHALL BE A MINIMUM DISTANCE OF 4" FROM ANY WALL.

5. WALL MOUNTED DEVICES SHALL BE A MINIMUM OF 4" AND MAXIMUM OF 12" FROM THE CEILING.

FINISH NOTES

1. VERIFY FINAL LIST OF FINISHES AND MATERIALS WITH ARCHITECT PRIOR TO PLACING ANY ORDERS.

2. INTERIOR DIMENSIONS ARE FOR GENERAL PLANNING PURPOSES ONLY AND SHOULD NOT BE USED FOR CONSTRUCTION. FOLLOW STUD TO STUD DIMESIONS PROVIDED ON FLOOR PLANS.

3. CONTRACTOR TO PROVIDE SAMPLES FOR ALL WOOD AND STONE SELECTION PRIOR TO PURCHASE. BID SHALL INCLUDE TEMPLATING, INSTALLATION, AND ANY OTHER NECESSARY WORK REQUIRED TO COMPLETE THE INSTALLATION.

4. ALL TILE/STONE TO BE INSTALLED PER MANUFACTURERS INSTRUCTIONS WHEN THEY EXIST OR PER RECOMMENDATIONS OF PRODUCT REPRESENTATIVE.

5. SUBSTRATE GROUT, WATERPROOFING MEMBRANE SEALANT, AND ANY ADDITIONAL MATERIALS NECESSARY TO COMPLETE TILE WORK SHALL BE THE CONTRACTORS RESPONSIBILITY AND SHALL BE INCLUDED IN THE PRICING.

6. GC TO PROVIDE 2' X 2' CONTROL SAMPLE OF TILE WITH GROUT AND SEALER TO BE APPROVED BY ARCHITECT PRIOR TO INSTALLATION.

7. REVIEW PROPOSED TILE LAYOUT W/ARCHITECT PRIOR TO INSTALLATION.


8. WOOD FLOORS SHALL BE TREATED WITH NON-TOXIC SEALER ONLY. ALL PLYWOOD MUST BE FORMALDEHYDE FREE.

9. GC TO PROVIDE MOCK-UP OF ALL STAINS, PAINTS, AND SEALERS FOR ARCHITECT'S REVIEW.

LEGEND

- RECESSED CEILING LIGHT \odot
- $-\bigcirc$ PENDANT CEILING LIGHT
- \bigotimes SURFACE MOUNT CEILING LIGHT SURFACE MOUNT WALL LIGHT
- \oplus (\mathbf{T}) THERMOSTAT
- DOORBELL CHIME
- SMOKE DETECTOR
- SD/CM CARBON MONOXIDE / SMOKE DETECTOR
- HARDWIRED W/BATTERY BACKUP. AIR SUPPLY - FLOOR OR CEILING; SEE NOTES
- \$ SWITCH
- QUAD OUTLET
- ELECTRICAL PANEL
- WALL INTERIOR NEW
- WALL EXTERIOR NEW 20002000
- WALL EXISTING TO REMAIN

SITE MAP

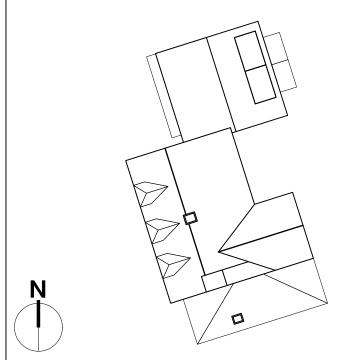


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11/04/2024 Drawing Title


Drawing No.

FLOOR 01 PLAN

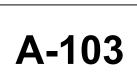

(<u>2</u> (A-201 /

\ A-30(

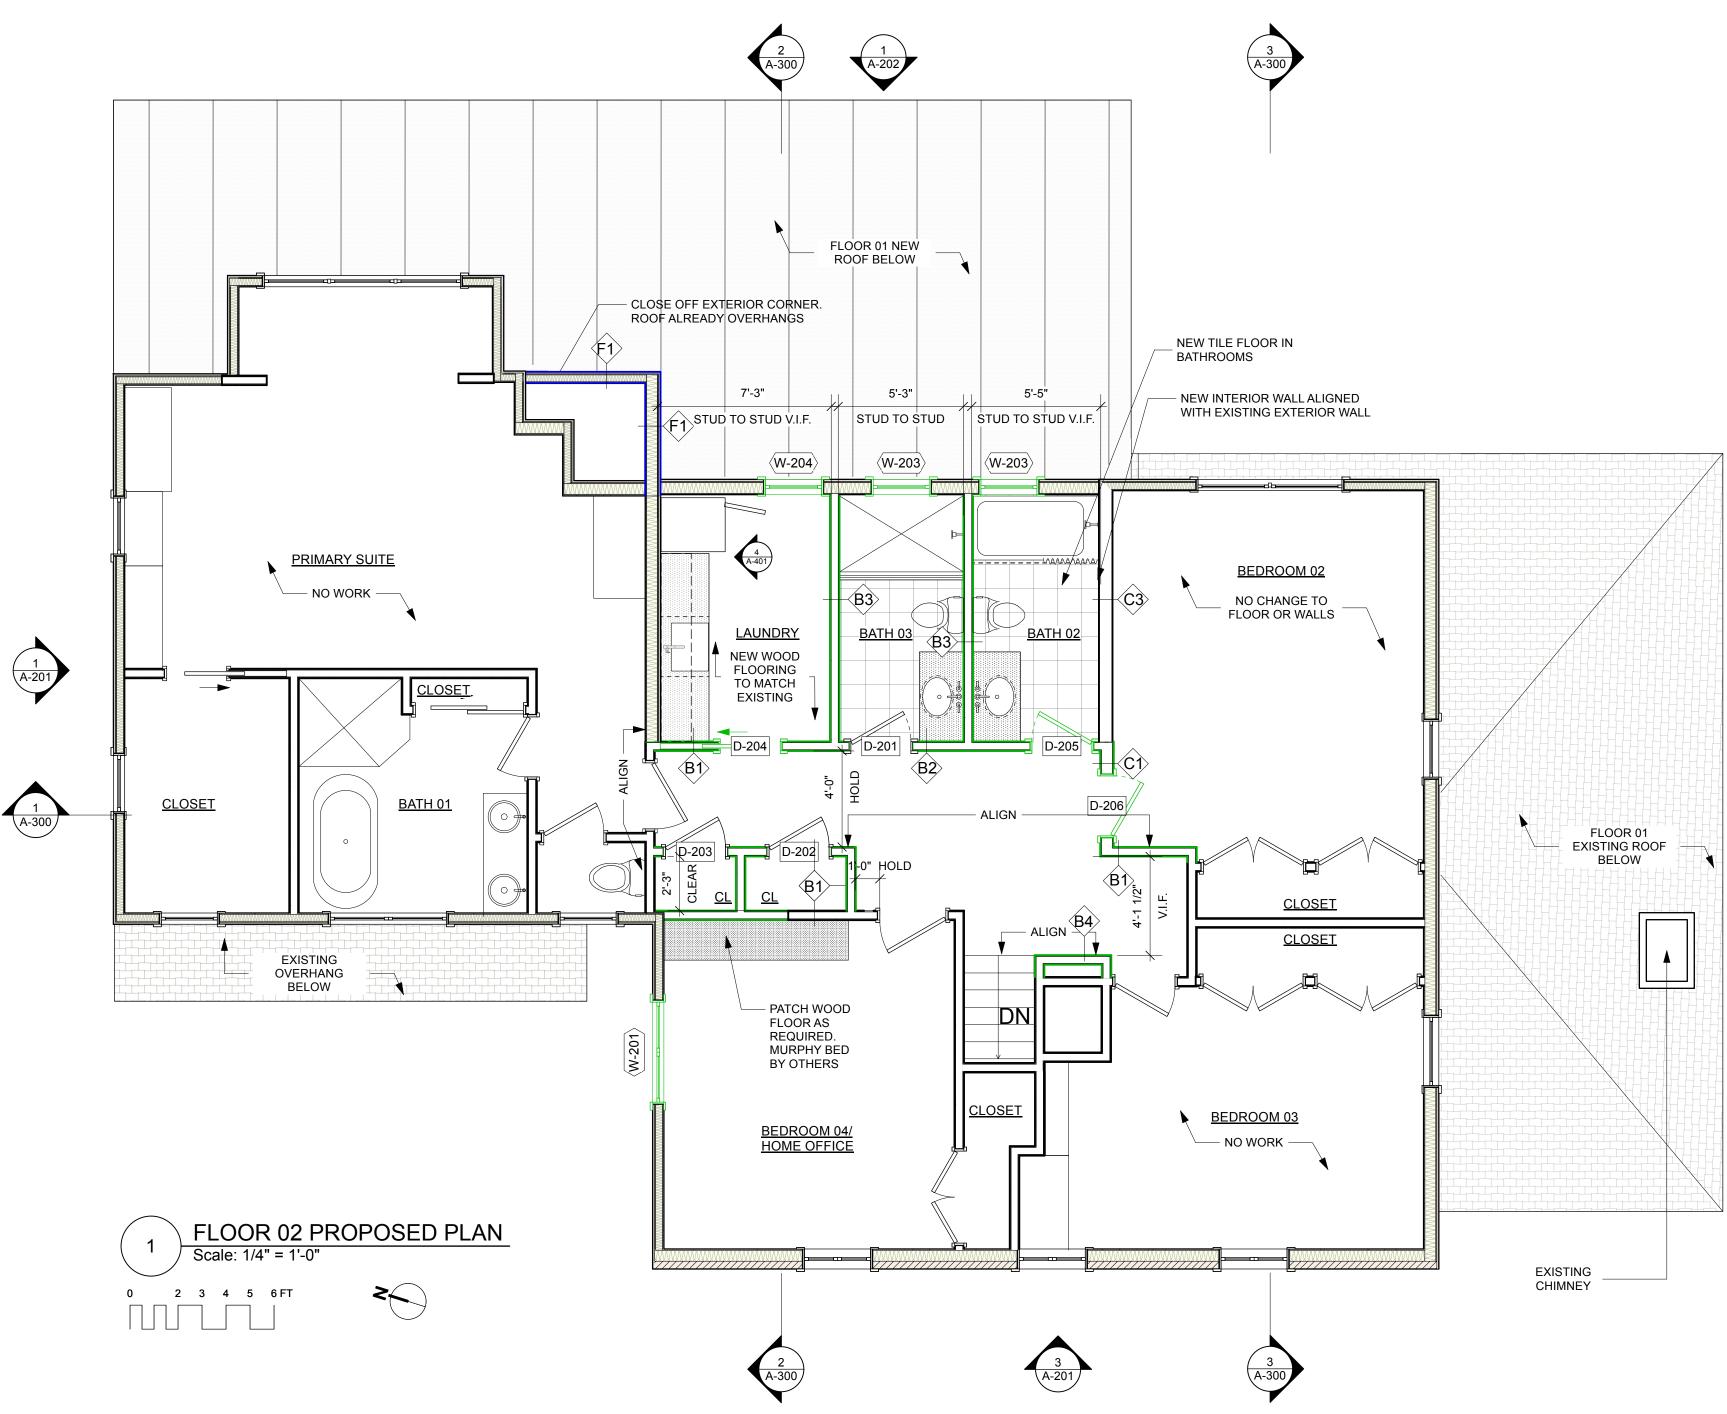

| OOR S | CHEDULE | | | | | | | | | | | | | | | |
|--------|------------------|----------|-------|-------------|-----------|----------------|-----------|------------|------------|----------|-----------|----------------------|---------------------------|---------------------------|--------------|----------------------|
| | | Location | N | Iominal Siz | e | Туре | | Dooi | r Frame | | | Manufacturer Data | | | | |
| Mark | Room Name | | Width | Height | Thickness | Configuration | Top Shape | Jamb Thick | Jamb Depth | Mfr | Model No. | Panel detail | Door Finish (Exterior) | Door Finish (Interior) | Hardware Set | Comments |
| D- 101 | Side Entry Front | Exterior | 3'0" | 6'8" | 1 3/4" | Swing Simple | Square | 3/4" | 7 5/8" | Trustile | TBD | TBD | Primed | Primed | - | Existing (Relocated) |
| D- 102 | Side Entry Front | Exterior | 3'0" | 6'11" | 1 3/4" | Swing Simple | Square | 3/4" | 5 5/8" | Trustile | TBD | TBD | Primed | Primed | - | New |
| D- 103 | Powder Room | Interior | 2'6" | 6'8" | 1 3/4" | Swing Simple | Square | 3/4" | 4 3/4" | Trustile | TS1000 | step (OS) flat panel | Primed | Primed | - | Existing (Relocated) |
| D- 104 | Pantry | Interior | 2'6" | 6'8" | 1 3/4" | Swing Simple | Square | 3/4" | 4 3/4" | Trustile | TS1000 | step (OS) flat panel | Primed | Primed | - | New |
| D- 105 | Broom | Interior | 2'4" | 6'8" | 1 3/4" | Swing Simple | Square | 3/4" | 4 3/4" | Trustile | TS1000 | step (OS) flat panel | Primed | Primed | - | New |
| D- 106 | Kitchen/Dining | Interior | 6'0" | 6'8" | 1 3/4" | Pocket Bi-part | Square | 3/4" | 1'0 1/4" | Trustile | TS1000 | step (OS) flat panel | Primed | Primed | - | New |
| D- 107 | Storage | Interior | 2'6" | 6'8" | 1 3/4" | Pocket Simple | Square | 3/4" | 4 3/4" | Trustile | TS1000 | step (OS) flat panel | Primed | Primed | - | New |
| D- 108 | Office | Interior | 2'8" | 6'8" | | Swing Simple | Square | 3/4" | 4 3/4" | Trustile | TS1000 | step (OS) flat panel | Primed | Primed | - | New |
| D- 109 | Patio | Exterior | 5'4" | 6'8" | | Swing Bi-part | Square | 3/4" | 7 5/8" | Trustile | TS1000 | step (OS) flat panel | Primed | Primed | - | Existing to Remain |
| D- 201 | Bath 03 | Interior | 2'6" | 6'6" | | Swing Simple | Square | 3/4" | 4 3/4" | Trustile | TS1000 | step (OS) flat panel | Primed | Primed | - | Existing (Relocated) |
| D- 202 | Hall Closet | Interior | 2'6" | 6'6" | | Swing Simple | Square | 1" | 4 3/4" | Trustile | TS1000 | step (OS) flat panel | Primed | Primed | - | Existing (Relocated) |
| D- 203 | Hall Closet | Interior | 2'6" | 6'6" | 1 3/4" | Swing Simple | Square | 1" | 4 3/4" | Trustile | TS1000 | step (OS) flat panel | Primed | Primed | - | Existing (Relocated) |
| D- 204 | Laundry | Interior | 2'6" | 6'6" | 1 3/4" | Pocket Simple | Square | 3/4" | 4 3/4" | Trustile | TS1000 | step (OS) flat panel | Primed | Primed | - | New |
| D- 205 | Bath 02 | Interior | 2'6" | 6'6" | 1 3/4" | Swing Simple | Square | 3/4" | 4 3/4" | Trustile | TS1000 | step (OS) flat panel | Primed | Primed | - | New |
| D- 206 | Bedroom 02 | Exterior | 2'6" | 6'6" | 1 3/4" | Swing Simple | Square | 3/4" | 6 3/4" | | | | | | - | Existing (Relocated) |

| | WINDC | OW SCHEDULE | E | | | | | | | | | | | | | |
|----|---------------|-------------|------------|-------------------------|------------------|-----------|---------------------|-----------------|---------------------------|-------------------|-------|-----------|-----------------------|---------------------|----------|--|
| | Rough Opening | | | Rough Opening Operation | | | | | | Manufacturer Data | | | | | | |
| | Mark | Room Name | R.O. Width | R.O. Height | Elevation Set At | Elevation | Sash Operation | Exterior Finish | Interior Window Finish | Mfr | Model | Model No. | Horizontal Muntins | Vertical Muntins | Comments | |
| W- | 102 | Family | 12'0" | 5'0" | Sill of Window | 1'7" | Custom | White | White | TBD | TBD | TBD | 0 | 1 | | |
| W- | 103 | Storage | 2'6" | 3'4" | Sill of Window | 3'0" | Casement | White | White | TBD | TBD | TBD | 2 | 1 | | |
| W- | 104 | Office | 2'6" | 3'4" | Sill of Window | 3'0" | Casement | White | White | TBD | TBD | TBD | 2 | 1 | | |
| W- | 201 | Bedroom 04 | 4'4" | 4'0" | Sill of Window | 2'7" | Bi-parting Casement | White | White | TBD | TBD | TBD | 1 | 1 | | |
| W- | 203 | Bath 03 | 2'6" | 3'4" | Sill of Window | 3'4" | Casement | White | White | TBD | TBD | TBD | 2 | 1 | | |
| W- | 203 | Bath 03 | 2'6" | 3'4" | Sill of Window | 3'4" | Casement | White | White | TBD | TBD | TBD | 2 | 1 | | |
| W- | 204 | Laundry | 2'6" | 3'4" | Sill of Window | 3'4" | Casement | White | White | TBD | TBD | TBD | 2 | 1 | | |

SHEET NOTES

1. INTERIOR DIMENSIONS SHOWN OUTSIDE OF STUD TO OUTSIDE OF STUD. "HOLD TO" DIMENSIONS ARE TO FACE OF FINISH,

2. EXTERIOR DIMENSIONS TO EXTERIOR OF SHEATHING

3. WHERE POSSIBLE, WINDOWS ALIGN ON CENTER WITH THOSE ABOVE AND BELOW. SEE ELEVATIONS FOR ADDITIONAL ALIGNMENT

SMOKE /CO2 DETECTOR NOTES

1. SD/CO2 DETECTORS SHOWN IN PLAN FOR APPROXIMATE LOCATION ONLY AND DO NOT INDICATE CEILING OR WALL MOUNT. COORDINATE LOCATION IN FIELD WITH ARCHITECT.

2. EACH SMOKE DETECTOR/CARBON MONOXIDE DETECTOR SHALL BE INSTALLED OUTSIDE OF EACH SLEEPING ROOM IN THE IMMEDIATE VICINITY OR WITHIN 15' OF THE ENTRANCE TO A SLEEPING ROOM; IN EACH ROOM USED FOR SLEEPING PURPOSES AND ON EACH STORY WITHIN A DWELLING UNIT, INCLUDING BELOW GRADE STORIES.

3. EACH SMOKE DETECTOR/CARBON MONOXIDE DETECTOR SHALL BE OF TYPE THAT ALLOWS FOR READILY TESTING OF SUCH DEVICE.

4. CEILING MOUNTED DEVICES SHALL BE A MINIMUM DISTANCE OF 4" FROM ANY WALL.

5. WALL MOUNTED DEVICES SHALL BE A MINIMUM OF 4" AND MAXIMUM OF 12" FROM THE CEILING.

FINISH NOTES

2 A-201 /

(1) (A-300)

1. VERIFY FINAL LIST OF FINISHES AND MATERIALS WITH ARCHITECT PRIOR TO PLACING ANY ORDERS.

2. INTERIOR DIMENSIONS ARE FOR GENERAL PLANNING PURPOSES ONLY AND SHOULD NOT BE USED FOR CONSTRUCTION. FOLLOW STUD TO STUD DIMESIONS PROVIDED ON FLOOR PLANS.

3. CONTRACTOR TO PROVIDE SAMPLES FOR ALL WOOD AND STONE SELECTION PRIOR TO PURCHASE. BID SHALL INCLUDE TEMPLATING, INSTALLATION, AND ANY OTHER NECESSARY WORK REQUIRED TO COMPLETE THE INSTALLATION.

4. ALL TILE/STONE TO BE INSTALLED PER MANUFACTURERS INSTRUCTIONS WHEN THEY EXIST OR PER RECOMMENDATIONS OF PRODUCT REPRESENTATIVE.

5. SUBSTRATE GROUT, WATERPROOFING MEMBRANE SEALANT, AND ANY ADDITIONAL MATERIALS NECESSARY TO COMPLETE TILE WORK SHALL BE THE CONTRACTORS RESPONSIBILITY AND SHALL BE INCLUDED IN THE PRICING.

6. GC TO PROVIDE 2' X 2' CONTROL SAMPLE OF TILE WITH GROUT AND SEALER TO BE APPROVED BY ARCHITECT PRIOR TO INSTALLATION.

7. REVIEW PROPOSED TILE LAYOUT W/ARCHITECT PRIOR TO INSTALLATION.


8. WOOD FLOORS SHALL BE TREATED WITH NON-TOXIC SEALER ONLY. ALL PLYWOOD MUST BE FORMALDEHYDE FREE.

9. GC TO PROVIDE MOCK-UP OF ALL STAINS, PAINTS, AND SEALERS FOR ARCHITECT'S REVIEW.

LEGEND

O RECESSED CEILING LIGHT

- PENDANT CEILING LIGHT
- SURFACE MOUNT CEILING LIGHT
- T THERMOSTAT
- D DOORBELL CHIME
- S SMOKE DETECTOR
- SD/CM CARBON MONOXIDE / SMOKE DETECTOR HARDWIRED W/BATTERY BACKUP.
- AIR SUPPLY FLOOR OR CEILING; SEE NOTES
- SWITCH
- QUAD OUTLET
- ELECTRICAL PANEL
 - WALL INTERIOR NEW
 - WALL EXTERIOR NEW
- WALL EXISTING TO REMAIN

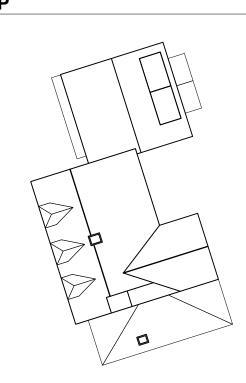



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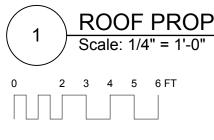
FLOOR 02 PLAN

Drawing No.






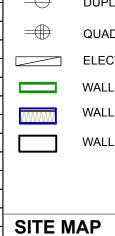

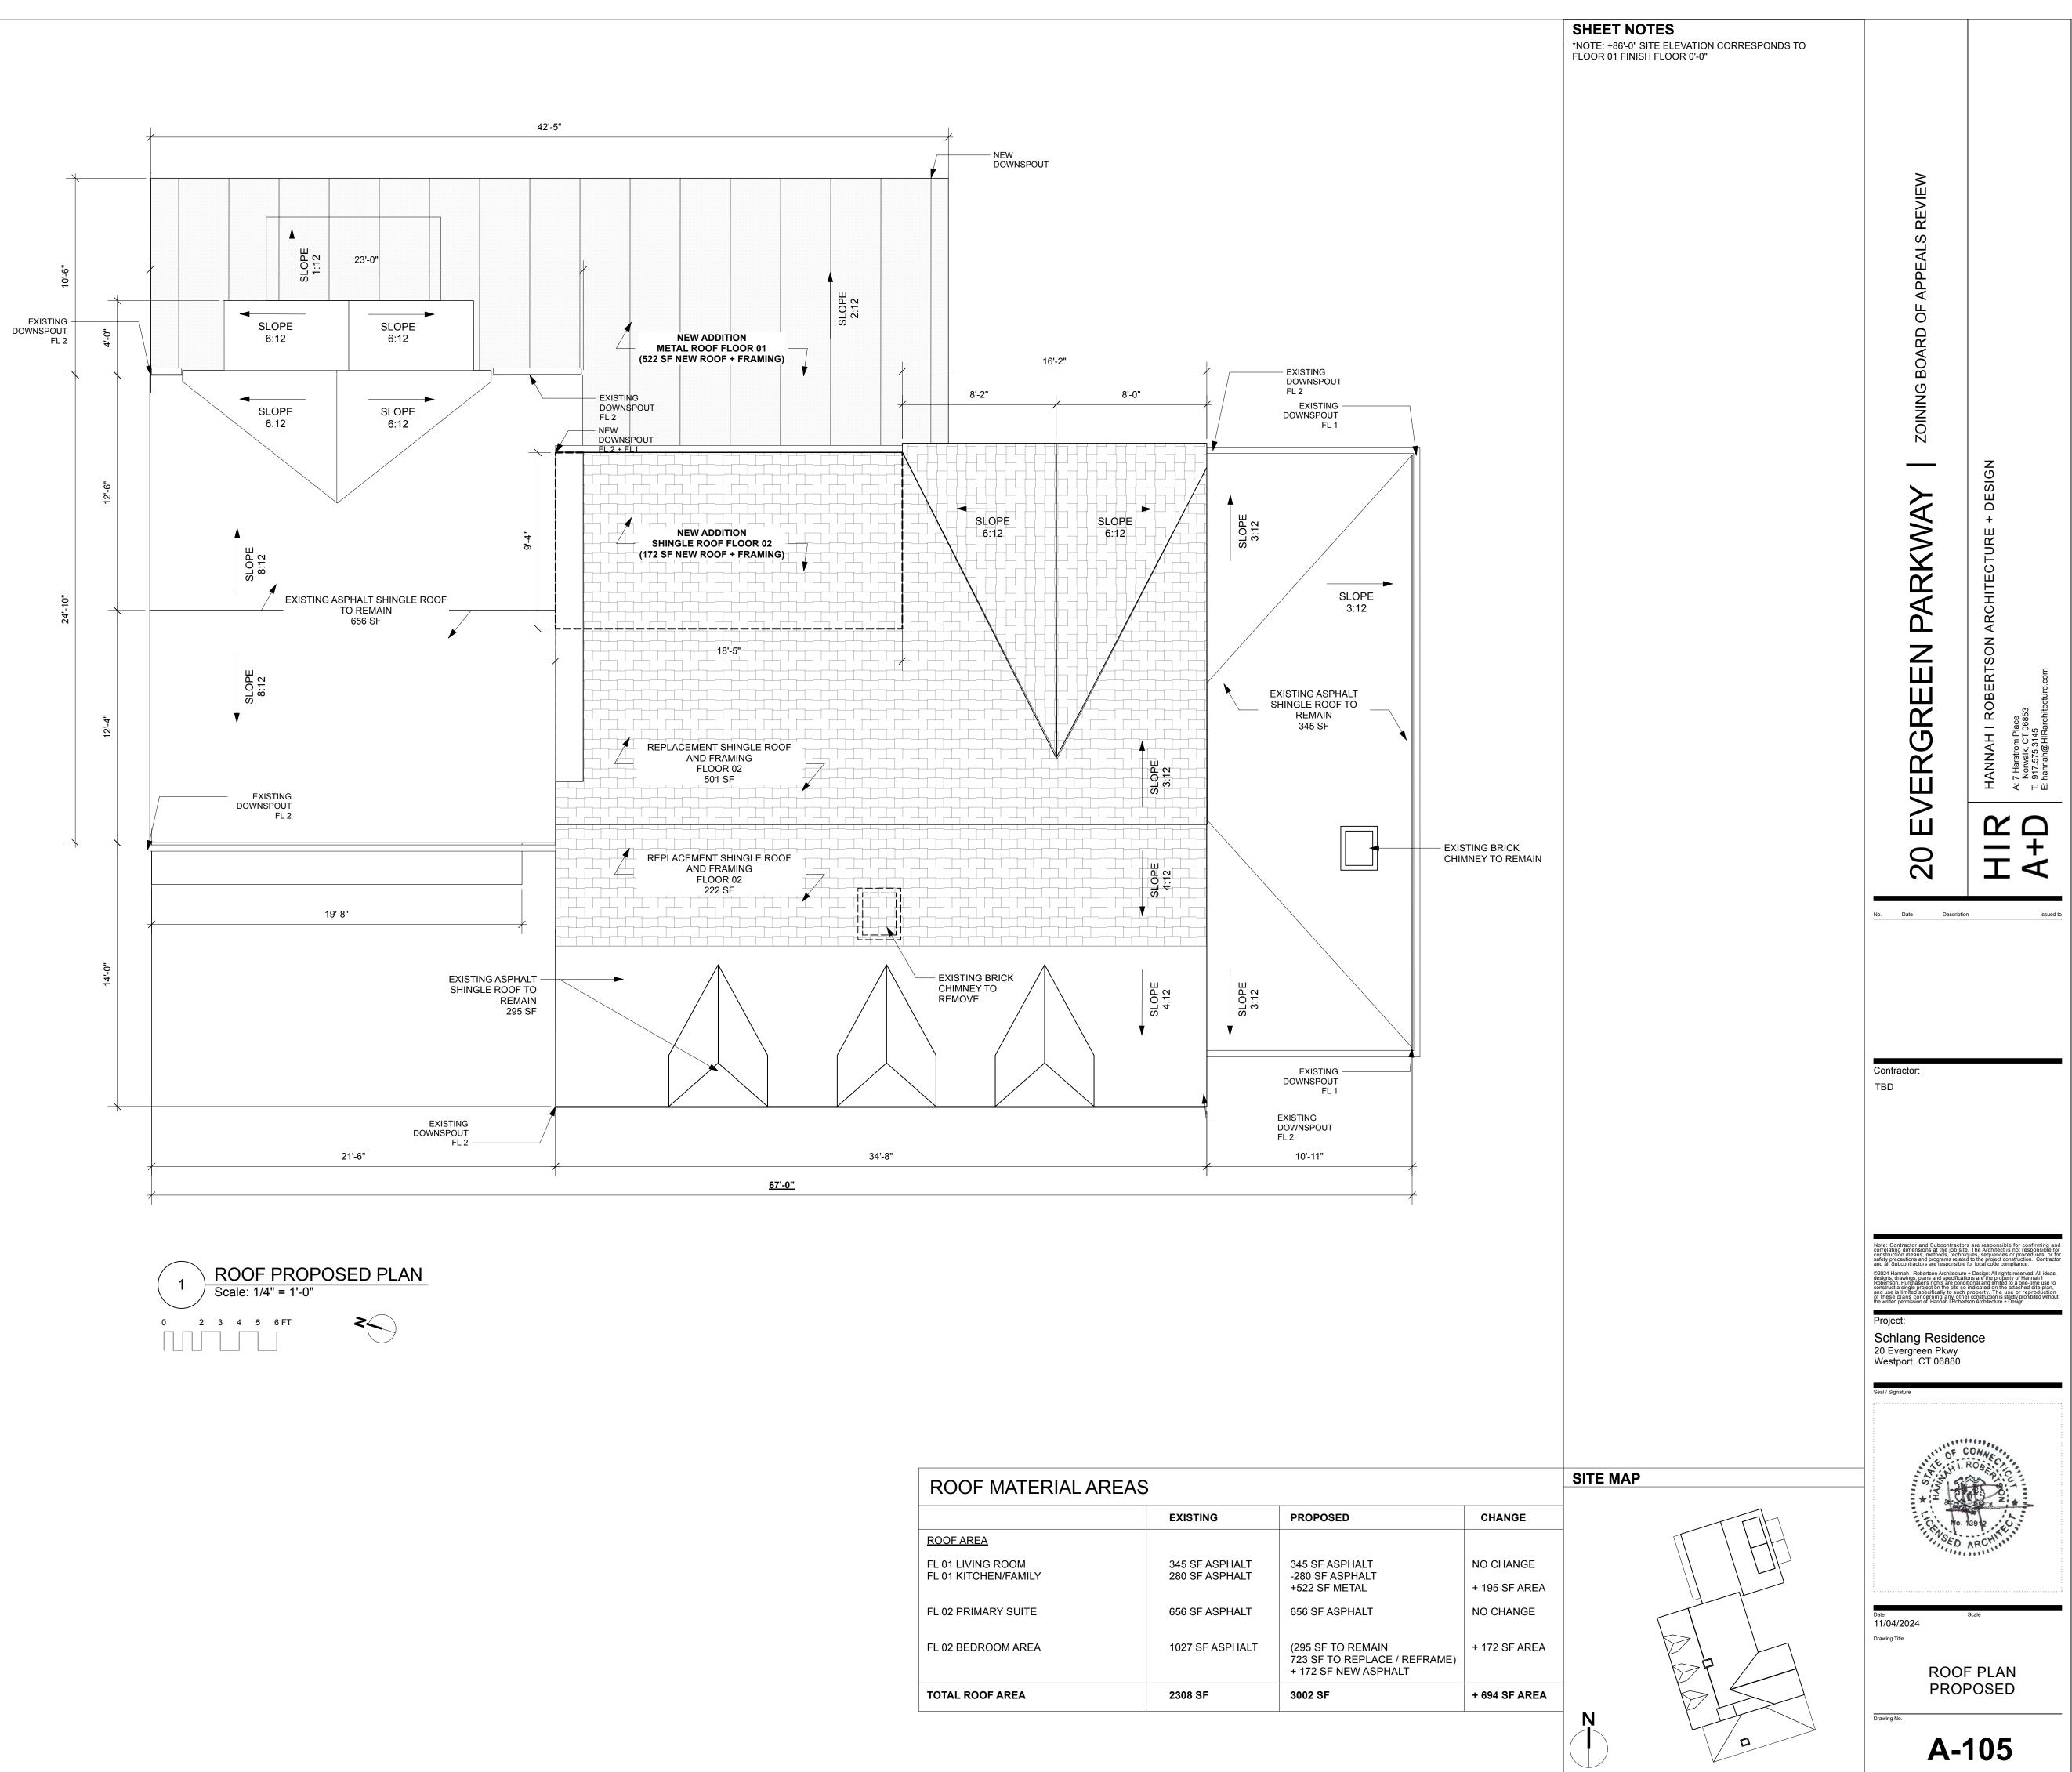





| ROOF MATERIAL AREAS | | | | | | | |
|---|----------------------------------|--|--|--|--|--|--|
| | EXISTING | | | | | | |
| ROOF AREA | | | | | | | |
| FL 01 LIVING ROOM FL 01 KITCHEN/FAMILY | 345 SF ASPHALT 280 SF ASPHALT | | | | | | |
| FL 02 PRIMARY SUITE | 656 SF ASPHALT | | | | | | |
| FL 02 BEDROOM AREA | 1027 SF ASPHALT | | | | | | |
| TOTAL ROOF AREA | 2308 SF | | | | | | |

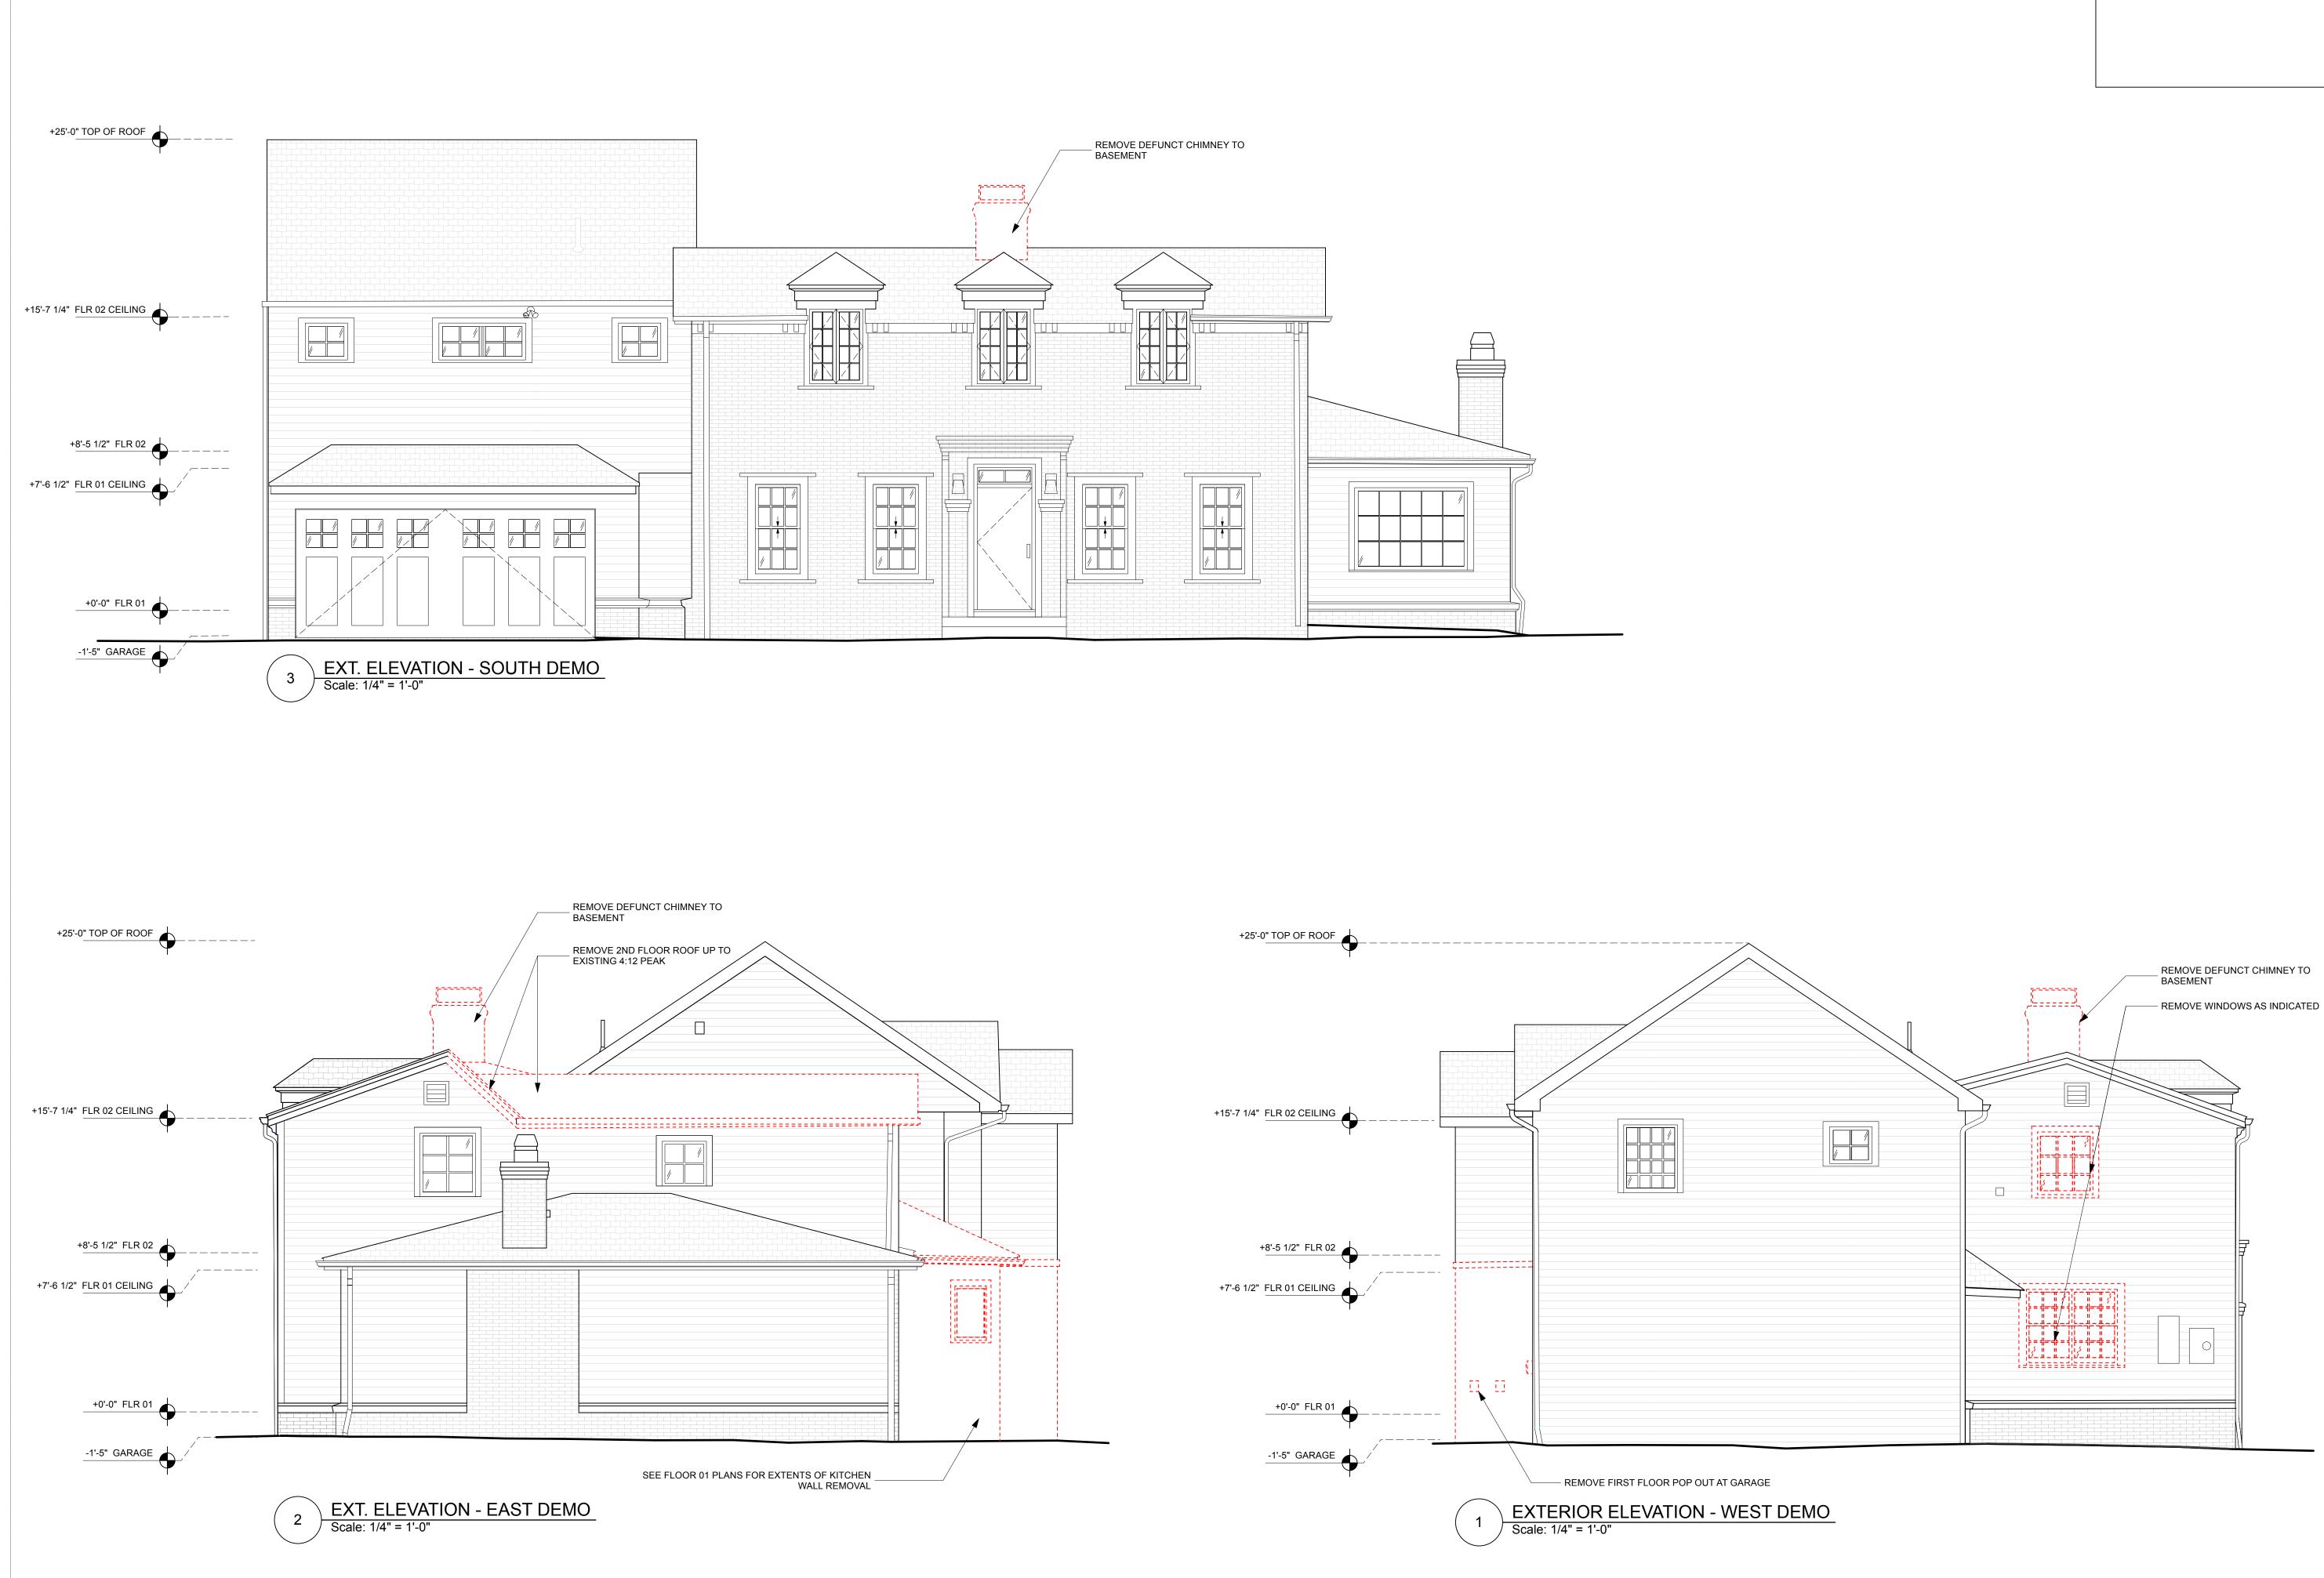

LEGEND

DEMOLITION BRICK WALL ASPHALT SHINGLE CLAPBOARD SIDING

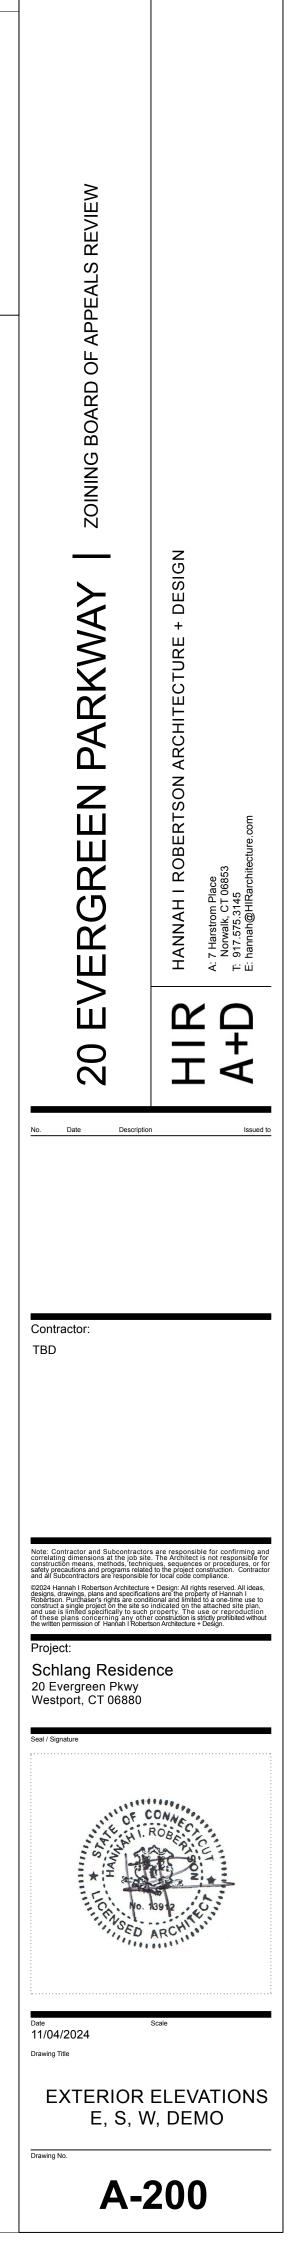

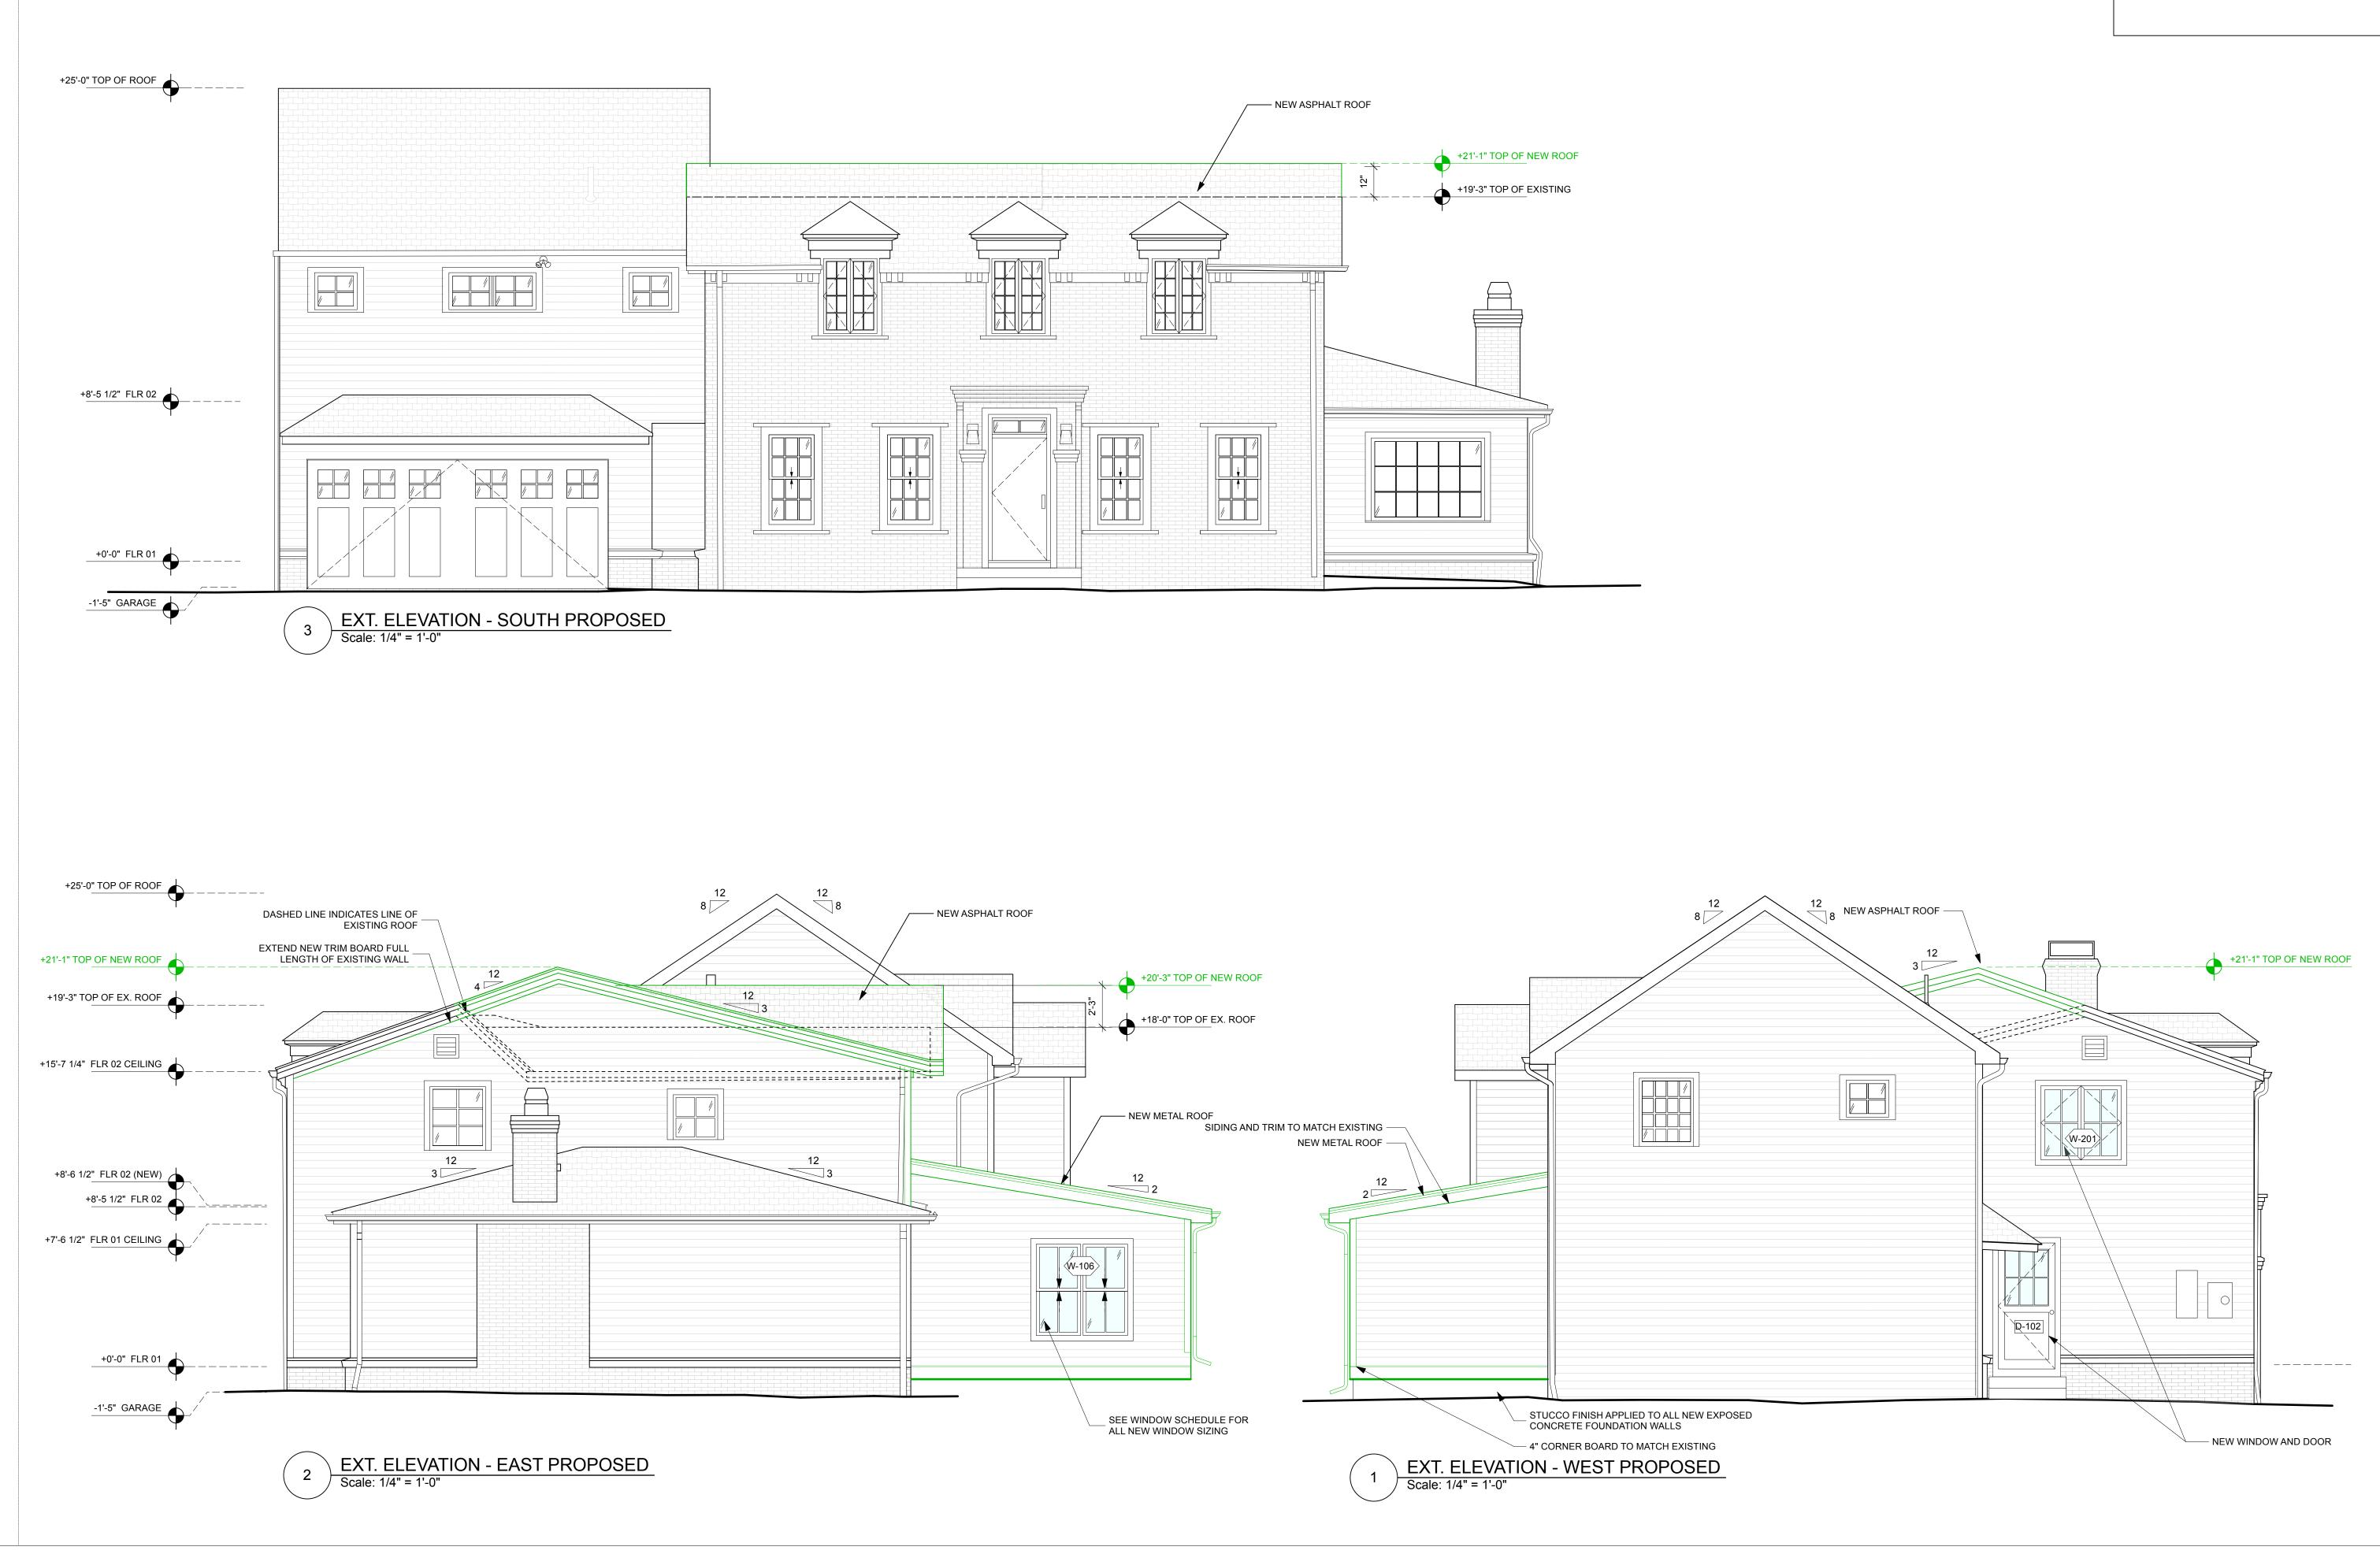


LEGEND

 NEW ADDITION


 BRICK WALL

 ASPHALT SHINGLE

 CLAPBOARD SIDING

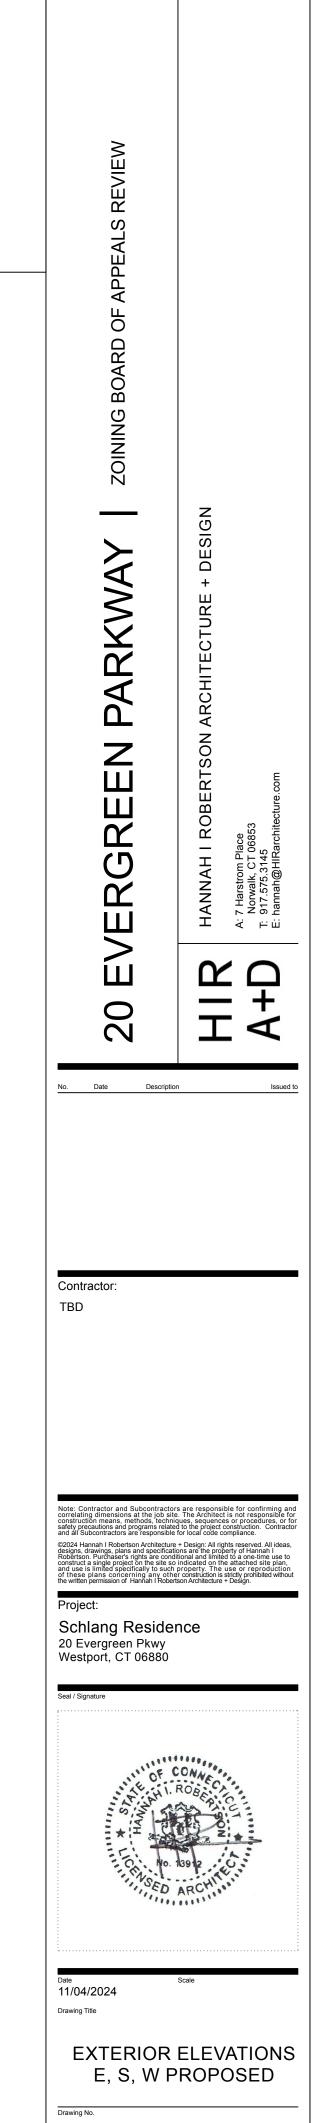

A-201

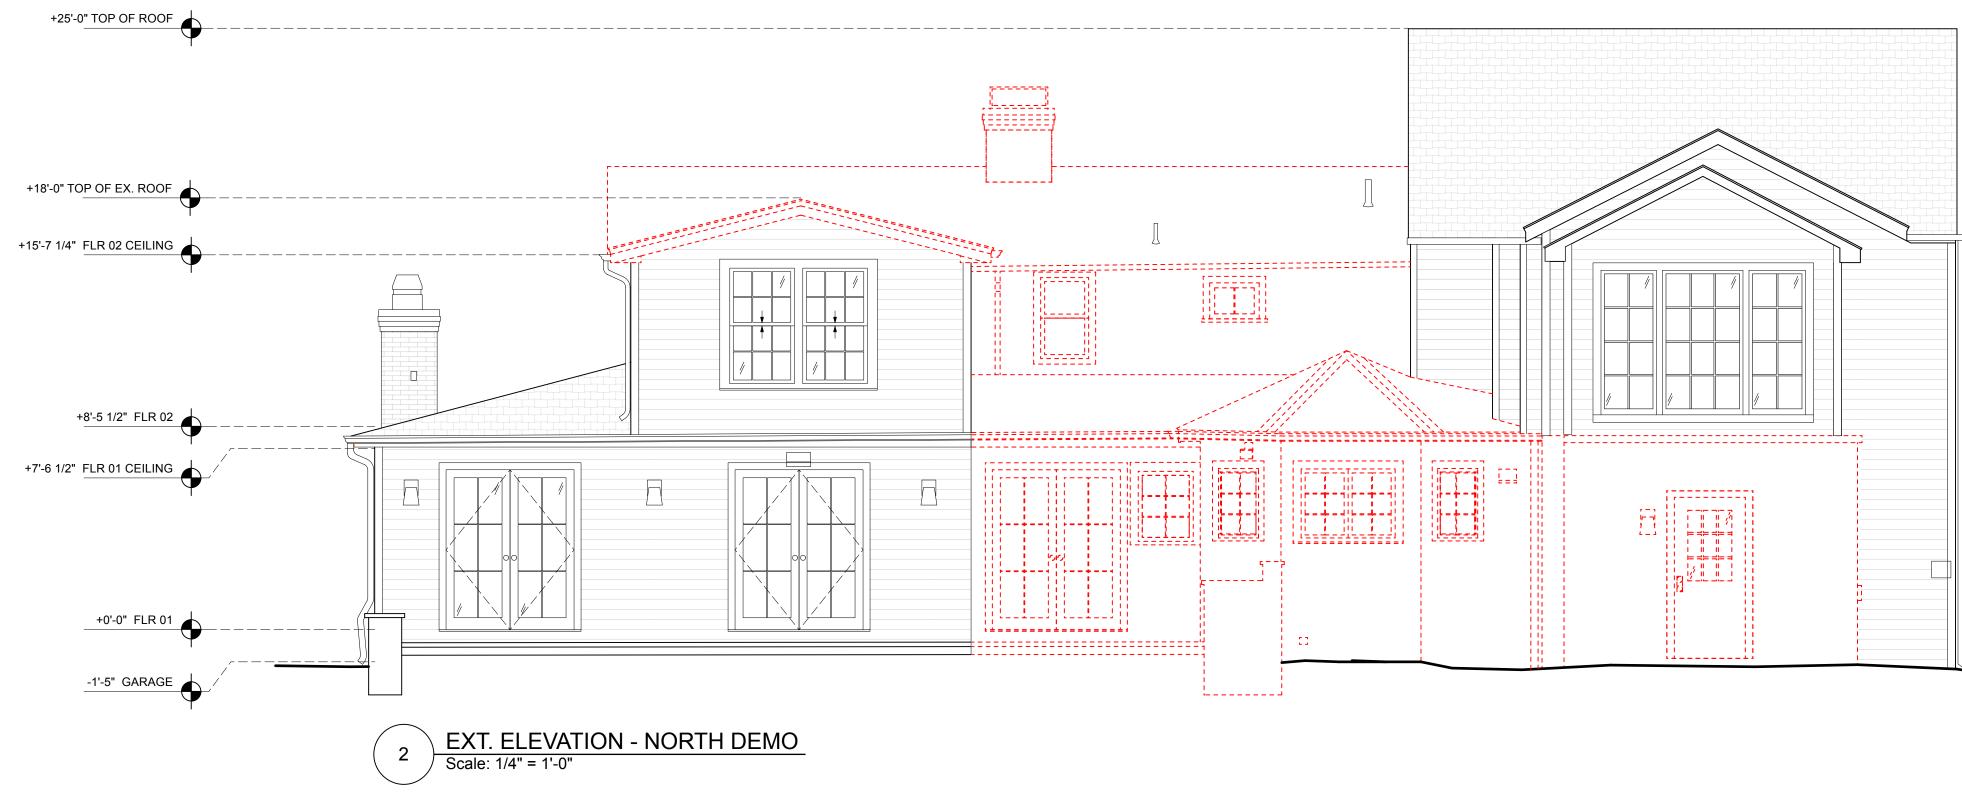



1

) EXT. ELEVATION - NORTH PROPOSED Scale: 1/4" = 1'-0"

LEGEND

DEMOLITION NEW ADDITION BRICK WALL ASPHALT SHINGLE CLAPBOARD SIDING _____

EXISTNG FACADE, — WINDOWS AND ROOF TO REMAIN

20 EVERGREEN PARKWAY HIR A+D No. Date Description Issued to Contractor: TBD Project Schlang Residence 20 Evergreen Pkwy Westport, CT 06880 11/04/2024 Drawing Title EXTERIOR ELEVATIONS NORTH Drawing No. A-202

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