
DRAWING	LIST							
SHEET	DESCRIPTION	SCALE						
Plans								
A-001 A-100	PLOT PLAN FOUNDATION / BASEMENT PLAN	1:100 1/4" = 1'-0"						
A-100 A-101	FOUNDATION / BASEMENT PLAN FLOOR 01 DEMO PLAN	1/4" = 1'-0" 1/4" = 1'-0"						
A-102		1/4" = 1'-0"						
A-103 A-104 A-105	FLOOR 01 PROPOSED PLAN + WALL TYPES + EQUIP. SCHEDULE1/4" = 1'-0"FLOOR 02 PROPOSED PLAN + DOOR AND WINDOW SCHEDULES1/4" = 1'-0"ROOF PLAN1/4" = 1'-0"							
Exterior Elevations		1/4" - 1' 0"						
۹-200 ۹-201	EXTERIOR ELEVATIONS - EAST, WEST, SOUTH EXISTING EXTERIOR ELEVATIONS - EAST, WEST, SOUTH PROPOSED	1/4" = 1'-0" 1/4" = 1'-0"						
	EXTERIOR ELEVATIONS - NORTH EXISTING + PROPOSED	1/4" = 1'-0"						
Building + Wall Sec -300	BUILDING SECTIONS	1/4" = 1'-0"						
-500	TYPICAL EXTERIOR DTLS	1 1/2" = 1'-0"						
1. GC SHALL BE RES AND DIMENSIONS F COORDINATION ISS	SPONSIBLE FOR CHECKING ALL "CONTRACT DOCUMENTS," FIELD C OR ACCURACY. IF THERE ARE ANY QUESTIONS REGARDING THESE UES, THE GC IS RESPONSIBLE FOR OBTAINING A CLARIFICATION (A ST WRITING DOWN HIS/HER QUESTIONS AND SENDING (IE. EMAIL) A	OR OTHER SI) FROM THE						
INFORMATION (RFI) OTHER RELATED W	TO THE ARCHITECT BEFORE PROCEEDING WITH THE WORK IN QUE ORK.	ESTION OR						
THAN THE GC Or HI	D "BY OTHERS" OR "N.I.C." IS TO BE ACCOMPLISHED BY A CONTRAC S/HER SUBCONTRACTORS, AND IS NOT TO BE PART OF THE CONTR . COMPLY WITH THE REQUIREMENTS OF APPLICABLE LOCAL, STATE	ACT SUM.						
CODES, ORDINANC	ES AND REGULATIONS. CONNECTICUT BUILDING CODE i. 2021 INTERNATIONAL RESIDENTIAL BUILDING CODE OF THE IC ii. 2021 INTERNATIONAL PLUMBING CODE iii. 2021 INTERNATIONAL PLUMBING CODE iv. 2021 INTERNATIONAL MECHANICAL CODE iv. 2021 INTERNATIONALENERGY CONSERVATION CODE v. 2020 NFPA 70, NATIONAL ELECTRICAL CODE, OF THE NFPA							
COMPLY WITH SECT	WITH 2021 IRC REQUIREMENTS, ADDITIONS, ALTERATIONS AND REF FION N1109 AND ANY UNCONDITIONED SPACE OR LOW-ENERGY SPA ME CONDITIONED SPACE SHALL COMPLY WITH SECTION N1108.							
COMPLY WITH THE i.N1100 ALTERA CONFOI THE ALT REQUIR UNALTE	E WITH 2021 IRC REQUIREMENTS FOR ADDITIONS AND ALTERATION FOLLOWING SECTIONS: (R502) ADDITIONS AND SECTIONS N1111 (R503) ALTERATIONS SO TH TIONS AND ADDITIONS TO THE EXISTING BUILDING ARE NOT LESS RMING WITH THE PROVISION OF THE EXISTING BUILDING PRIOR TO TERATION AND WHERE THE ADDITION SHALL CONFORM TO THE EMENTS OF NEW CONSTRUCTION WITHOUT REQUIRING THE RED PORTION OF THE EXISTING BUILDING TO COMPLY. ADDITIONS AN UNSAFE OR HAZARDOUS CONDITION OR OVERLOAD THE EXIST A.	AT SHALL NOT						
ii. N113. ALTERE	1.1 (R505.1.1): ANY UNCONDITIONED SPACE OR LOW-ENERGY SPACE D TO BECOME CONDITIONED SPACE SHALL COMPLY WITH SECTION NEWLY INSTALLED AS PART OF AN ALTERATION SHALL COMPLY WIT	N1108: HVAC						
DUST AND DEBRIS \	BLE FOR INSTALLING ADEQUATE PROTECTION FOR KEEPING ANY CONTINUES OF THE CONSTRUCTION SITE. IN THE EVENT THAT IT THE CONSTRUCTION SITE, CONTRACTOR IS RESPONSIBLE FOR	AT ANY DUST						
	ONSIBLE FOR ALL FEES AND PERMITS NECESSARY TO COMPLETE TH CONTRACT DOCUMENTS.	HE WORK						
A. IN CC	OPPING IN THE FOLLOWING LOCATIONS. ONCEALED SPACES OF STUD WALLS AND PARTITIONS, INCLUDING F 5, AT THE CEILING AND FLOOR LEVELS	URRED						
OCCUR	L INTERCONNECTIONS BETWEEN VERTICAL AND HORIZONTAL SPAC AT SOFFITS, DROP CEILINGS, COVE CEILINGS, ETC.							
D. AT OF	DNCEALED SPACES AT STAIR STRINGERS AND THE TOP AND BOTTO PENINGS AROUND VENTS, PIPES, CHIMNEYS, AND FIRE PLACES, AT LEVEL, WITH NONCOMBSTIBLE MATERIALS.							
8. PROVIDE GLASS SOFFITS FOR DRAF	FIBER INSULATION, MINERAL WOOL OR SPRAY FOAM EVERY 10' AT \ T STOP.	WALLS AND						
	D ALL FIREPROOFING WHICH HAS BEEN DISTURBED DURING DEMC	DLITION.						
11. ALL DIMENSIONS	DRAWINGS. USE WRITTEN DIMENSIONS ONLY. 5, NOTES, FINISHES AND FIXTURES SHOWN ON TYPICAL FLOOR PLA APPLY TO ALL SIMILAR, SYMMETRICAL, OR OPPOSITE HAND SECTIO							
DRAWINGS, SAMPLI	ARCHITECT FOR REVIEW (PRIOR TO CONSTRUCTION) ALL REQUIRE ES, AND PRODUCT INFORMATION AS CALLED FOR BY THE PROJECT							
	BE TAKEN AT ALL TIMES TO PROTECT THE OWNER'S SITE AND PROP	ERTY.						
	RGY COMPLIANCE DE INSULATION WITH VAPOR BARRIER AS INDICATED IN DRAWINGS MANUFACTURER'S INSTRUCTIONS TO MEET FOLLOWING MINIMUM							
	SE INDICATED ON THE DRAWINGS): LIEC R-30							
CEILING WITH ATTIC	R-60 8: R-30							
SLEEPING ROOM IN ROOM; IN EACH RO	ORS: CTOR/CARBON MONOXIDE DETECTOR SHALL BE INSTALLED OUTSI THE IMMEDIATE VICINITY OR WITHIN 15' OF THE ENTRANCE TO A S OM USED FOR SLEEPING PURPOSES AND ON EACH STORY WITHIN ELOW GRADE STORIES.	LEEPING						
IN DWELLING UNITS	TORS SHALL BE REQUIRED IN THE HALLWAY AND IN THE ROOM TO SWHERE THE CEILING HEIGHT OF A ROOM OPEN TO A HALLWAY SEF DS THAT OF THE HALLWAY BY 24 INCHES OR MORE.							
READILY TESTING C	ETECTOR/CARBON MONOXIDE DETECTOR SHALL BE OF TYPE THAT OF SUCH DEVICE. TED DEVICES SHALL BE A MINIMUM DISTANCE OF 4" FROM ANY WALL							
MOUNTED DEVICES DETECTORS SHOW	ED DEVICES SHALL BE A MINIMUM DISTANCE OF 4" FROM ANY WALL S SHALL BE A MINIMUM OF 4" AND MAXIMUM OF 12" FROM THE CEILII N IN PLAN FOR APPROXIMATE LOCATION ONLY AND DO NOT INDICA RDINATE LOCATION IN FIELD WITH ARCHITECT.	NG. SD/CO2						
	STALLATION OF BATTERY POWERED SMOKE DETECTORS AND CARE ED DURING CONSTRUCTION IN THE VICINITY OF ALTERNATIONS AN							

N 75°09'00" | 157.00'


Ш

19. CALL BEFORE YOU DIG: #1-800-922-4455

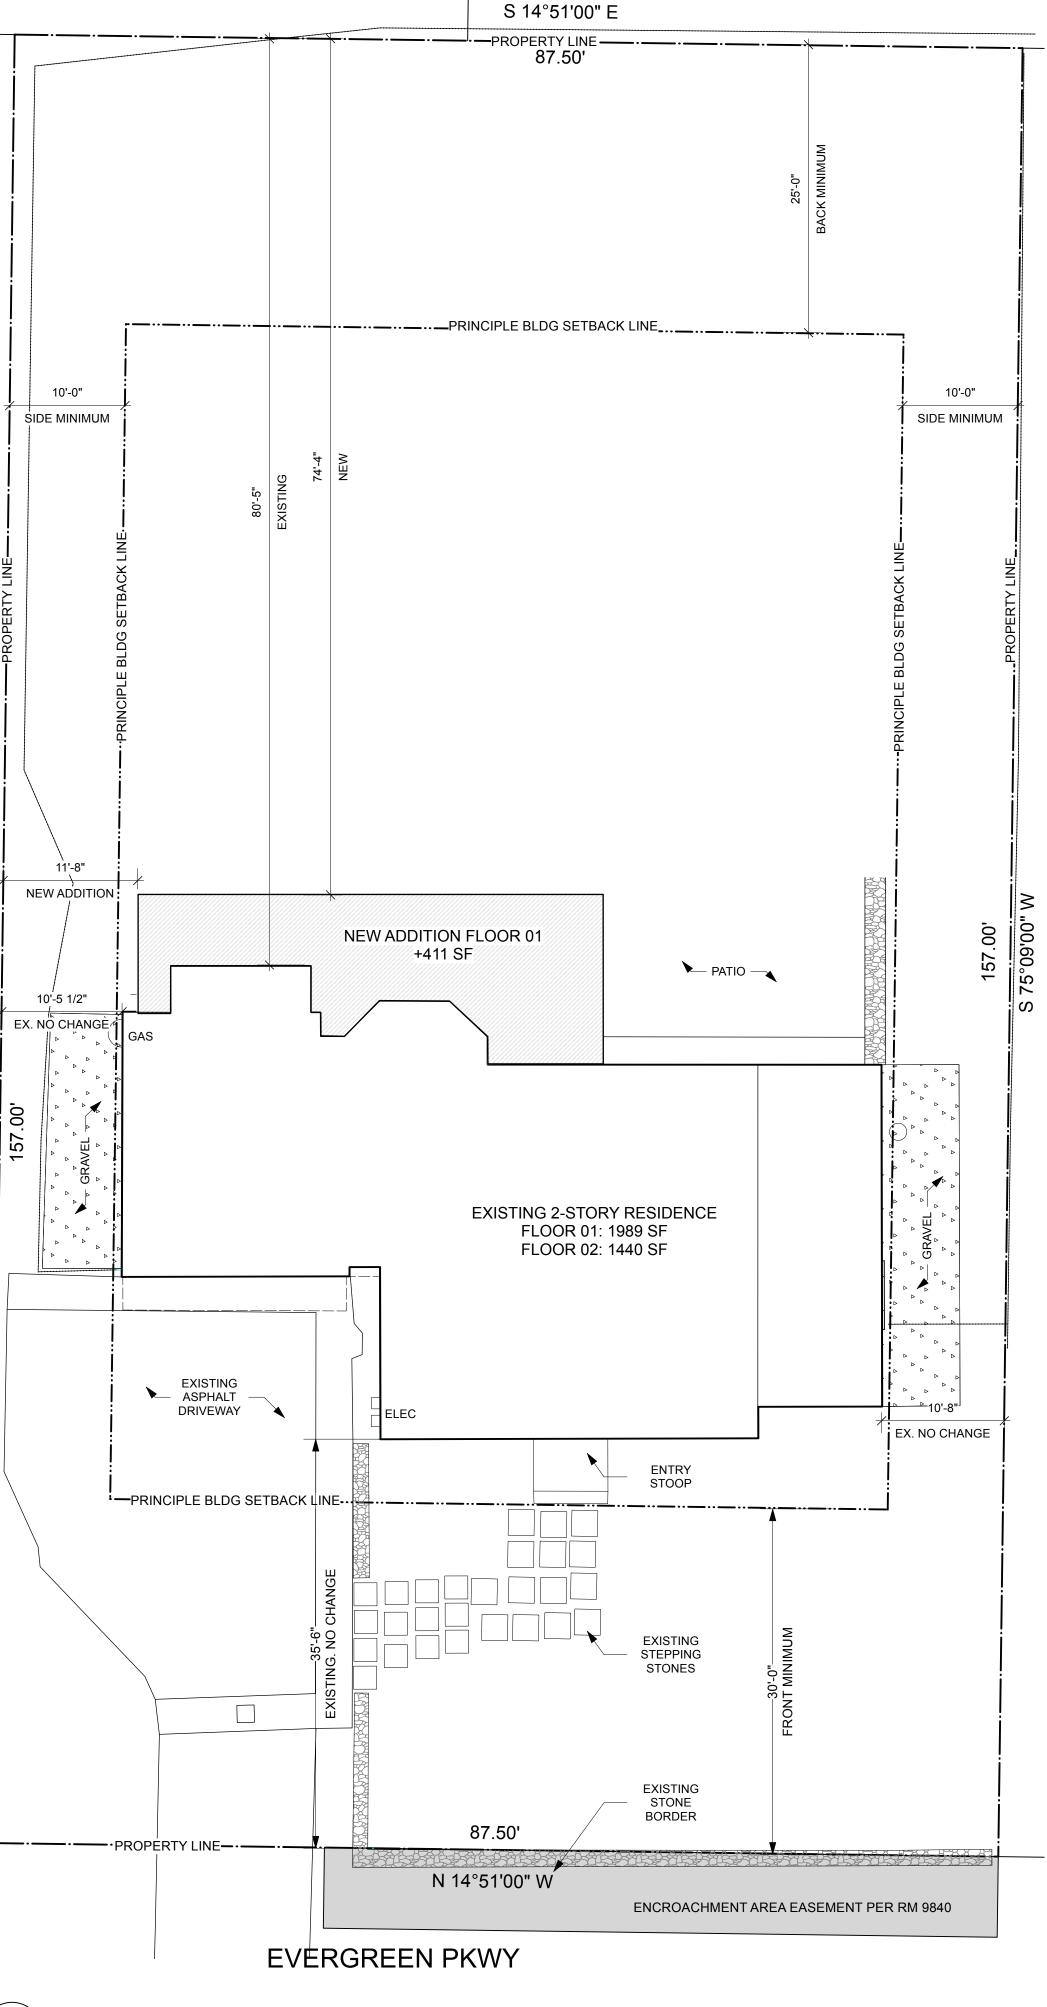



PLOT PLAN - PROPOSED Scale: 1:100



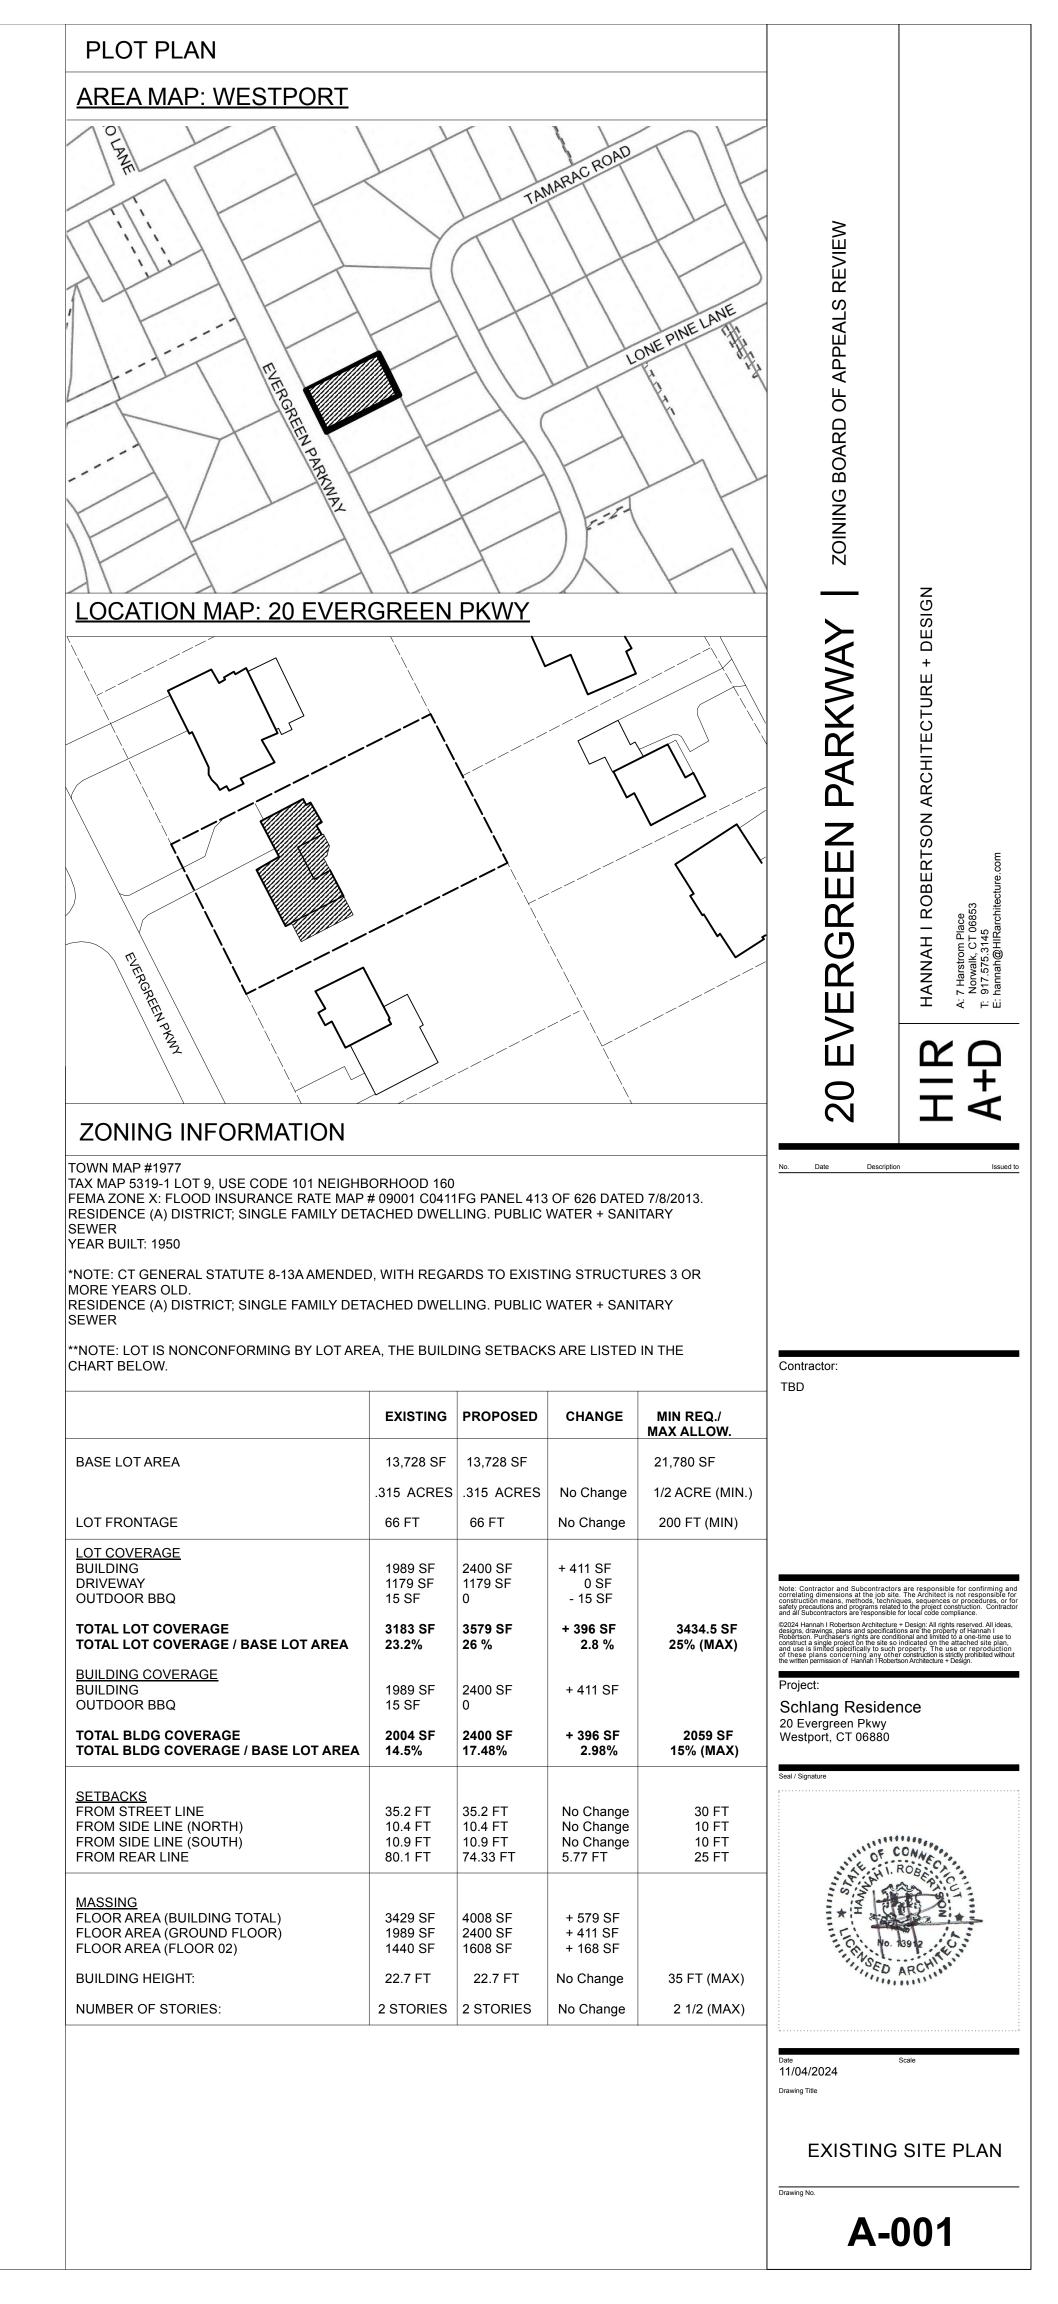


NEW 2 X 12 FLOOR

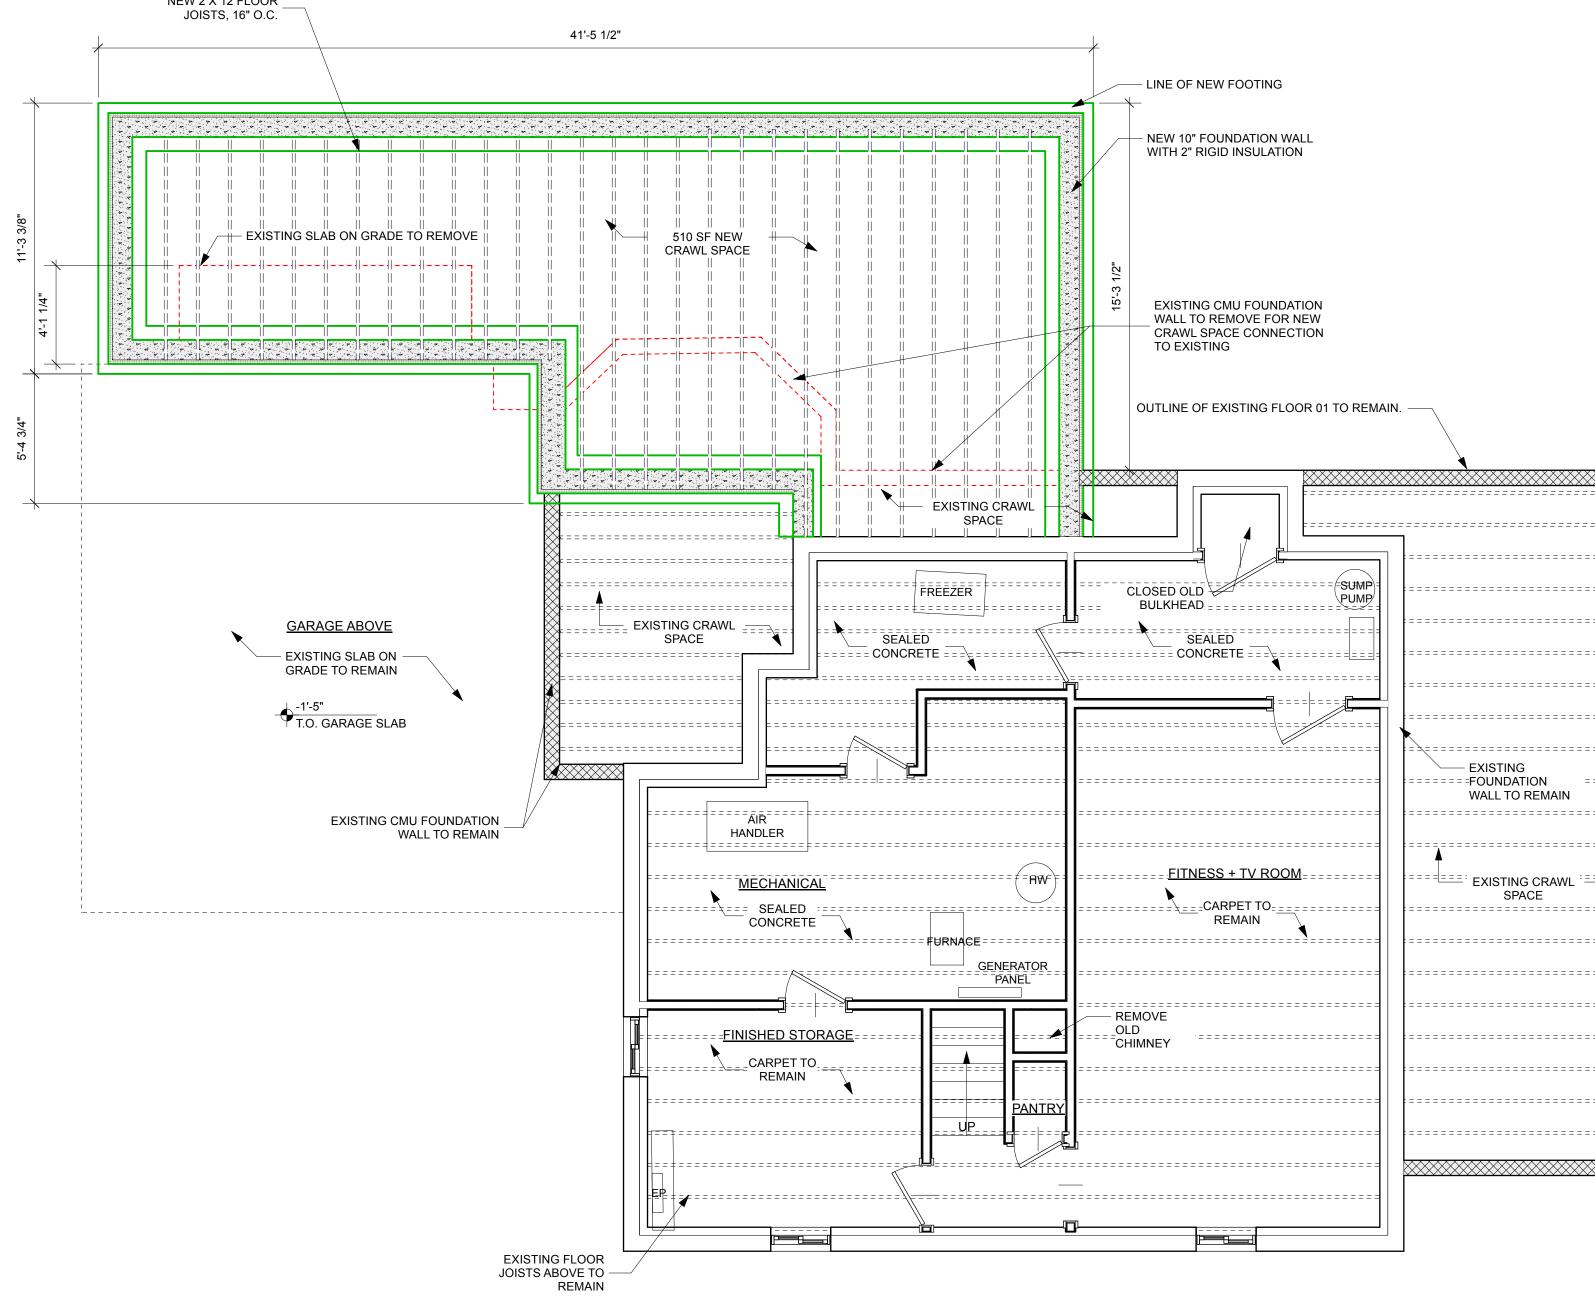


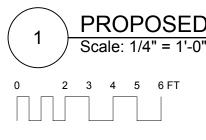



PROPOSED BASEMENT + FOUNDATION PLAN



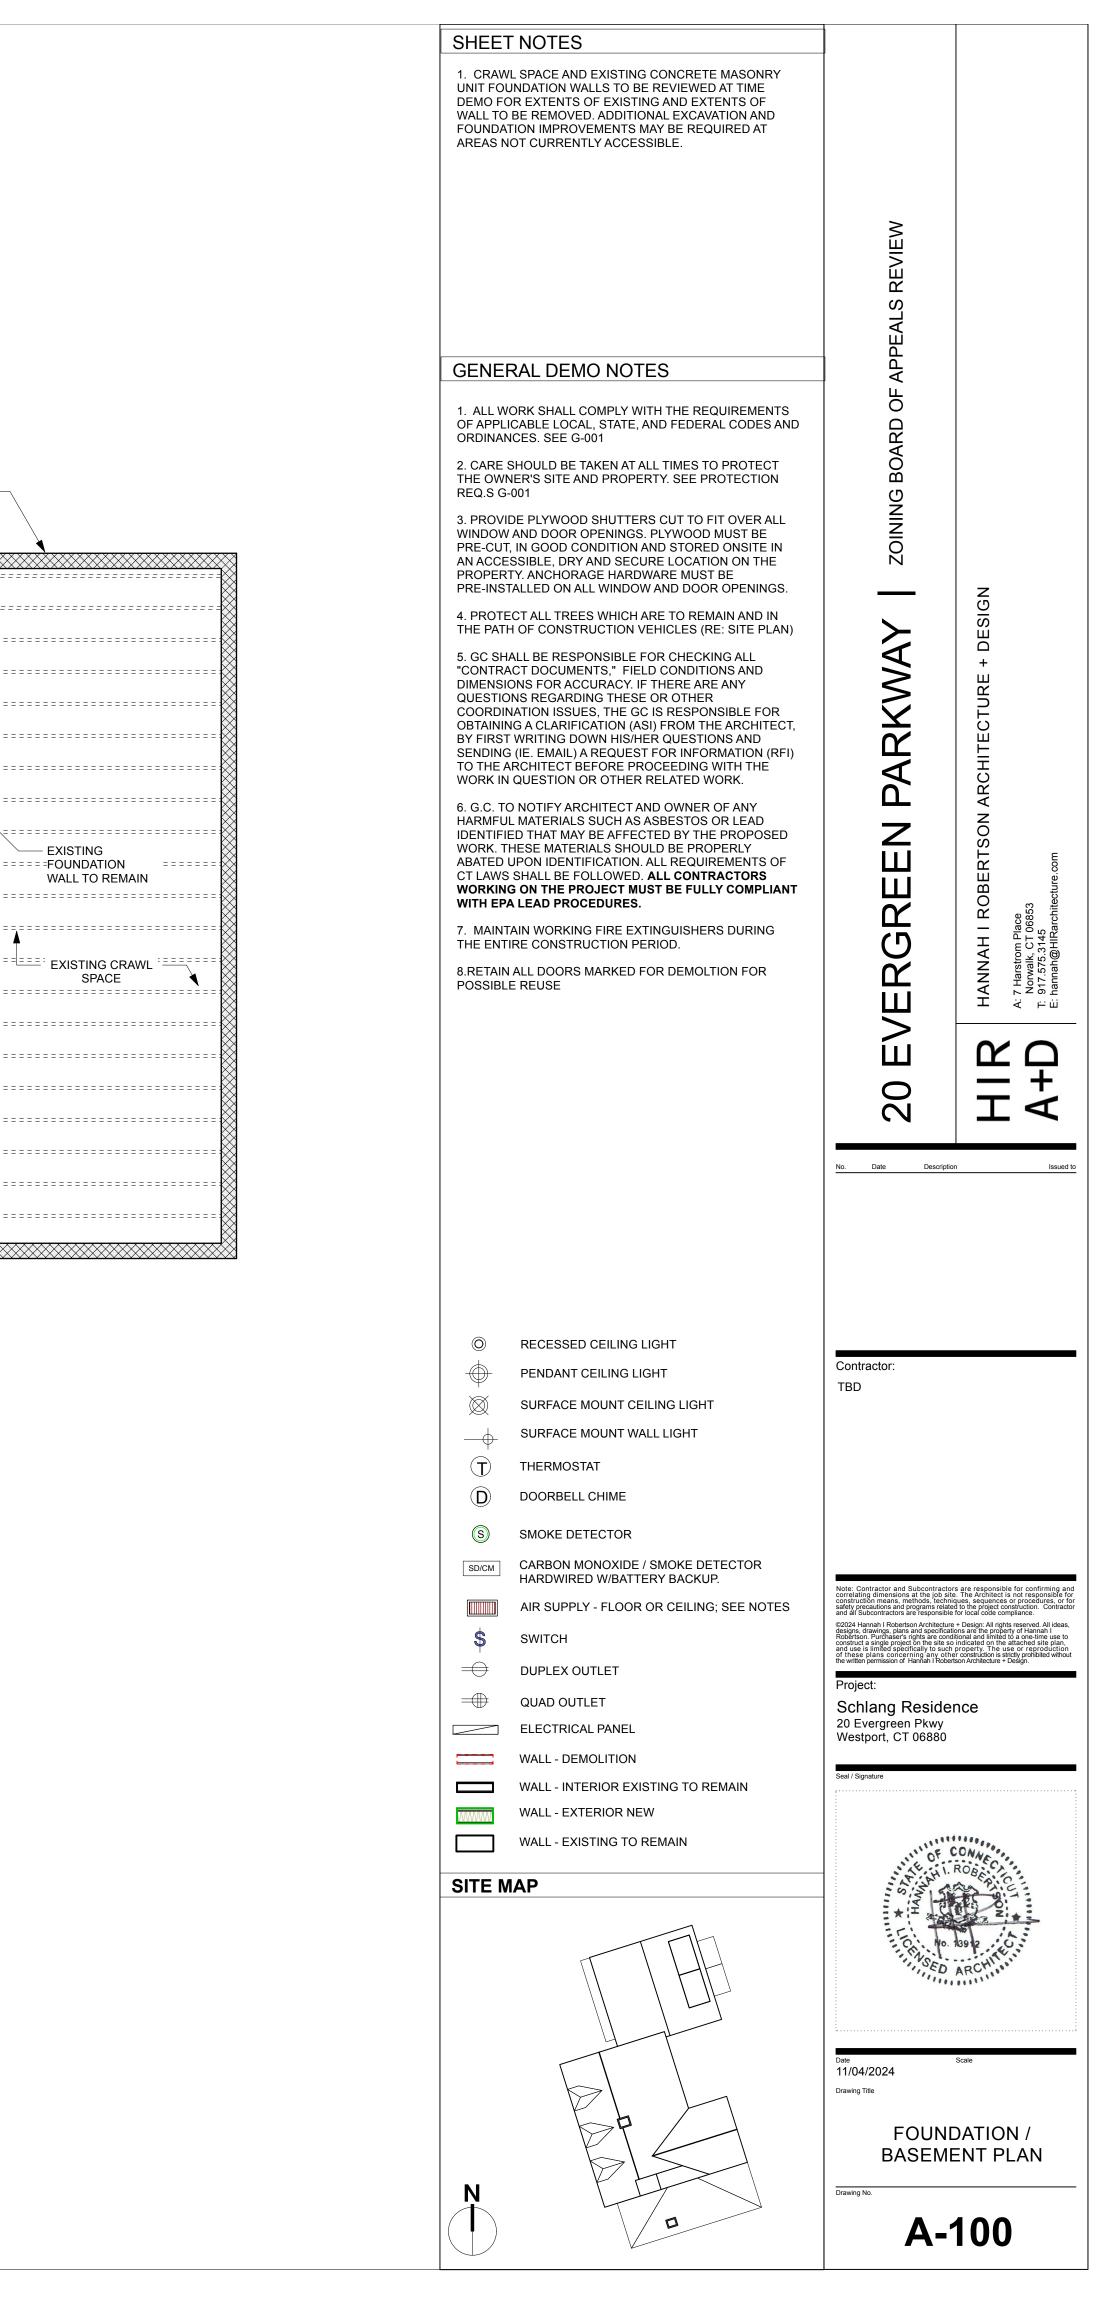


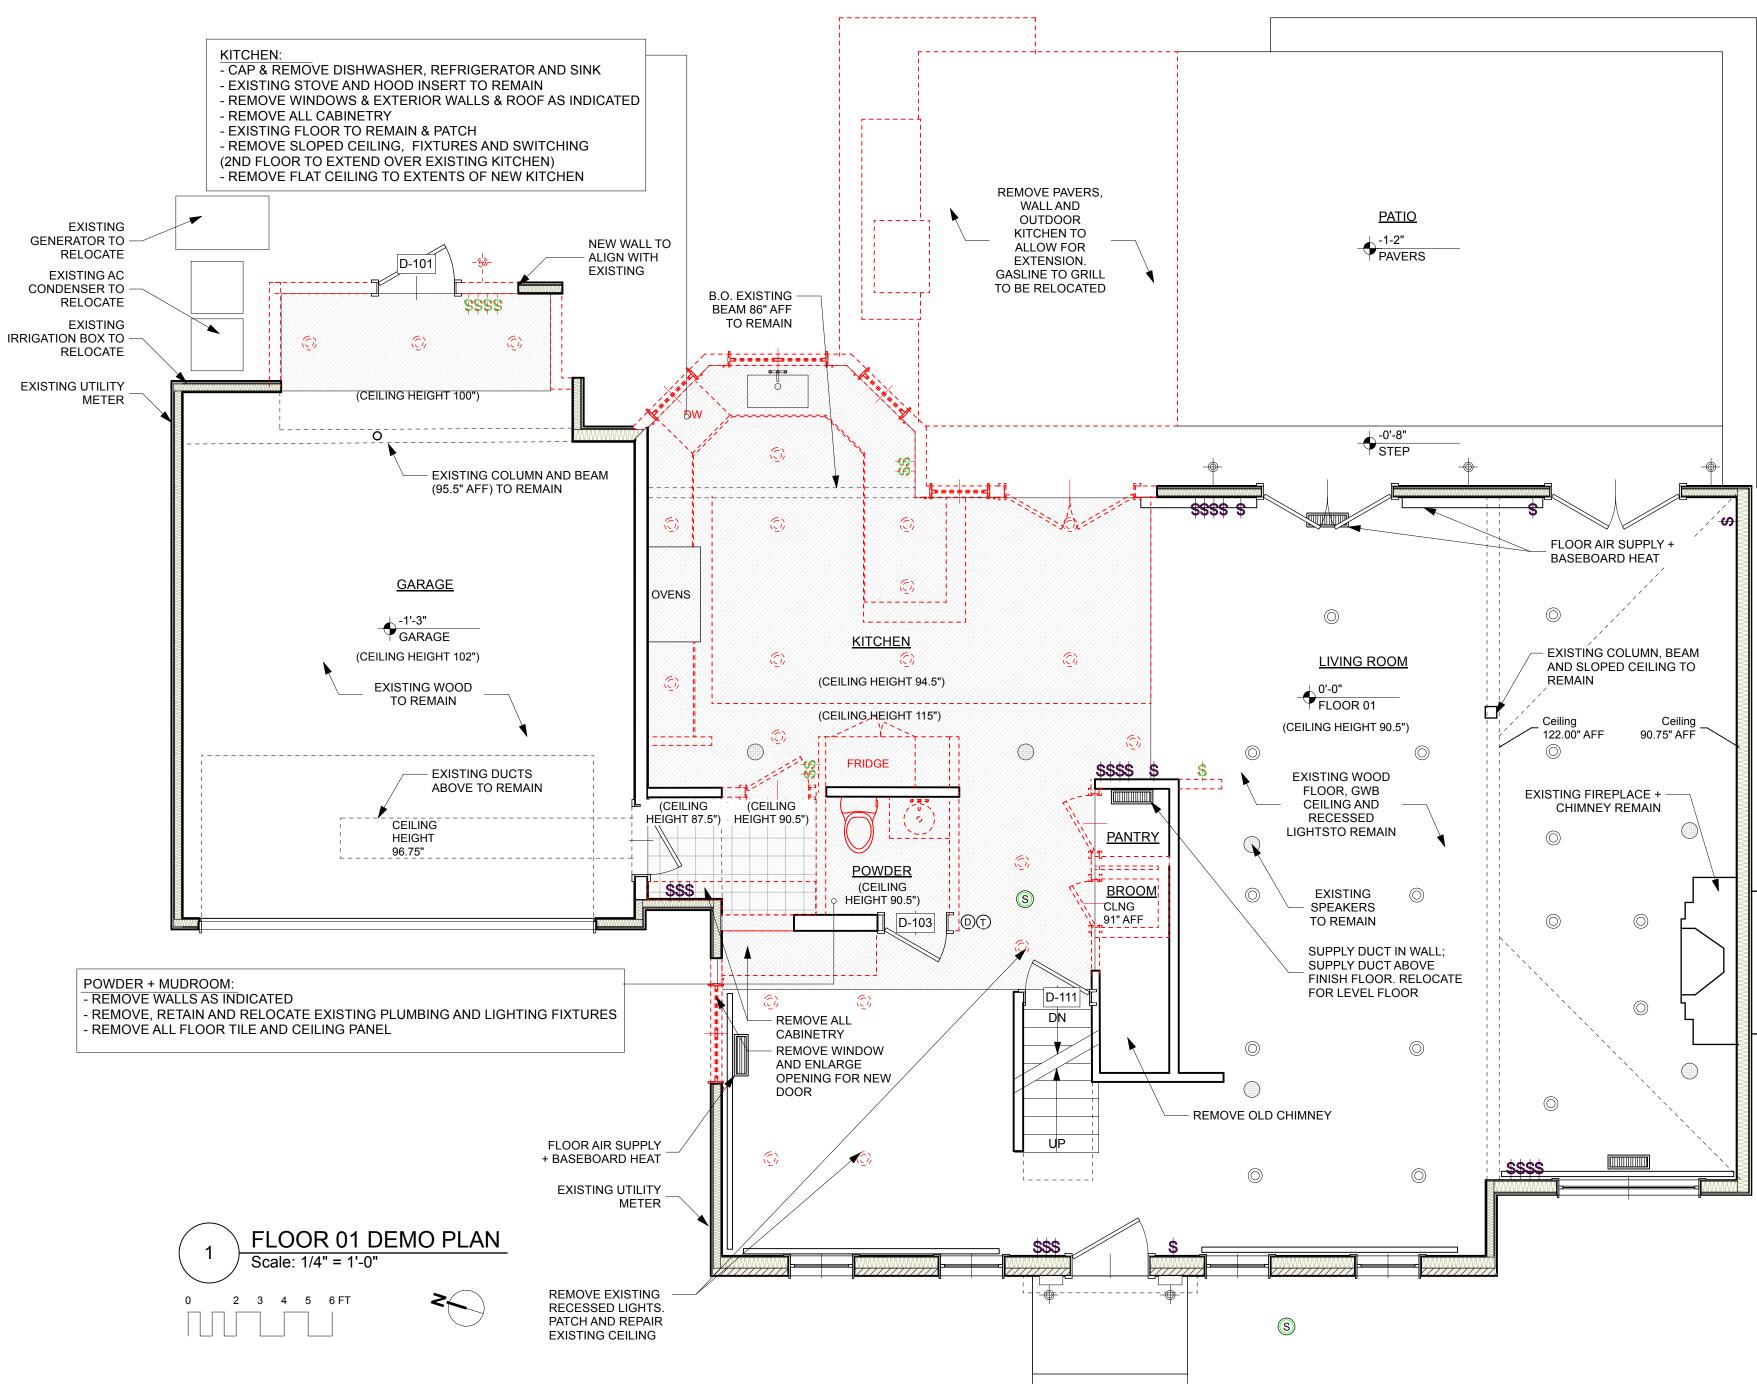

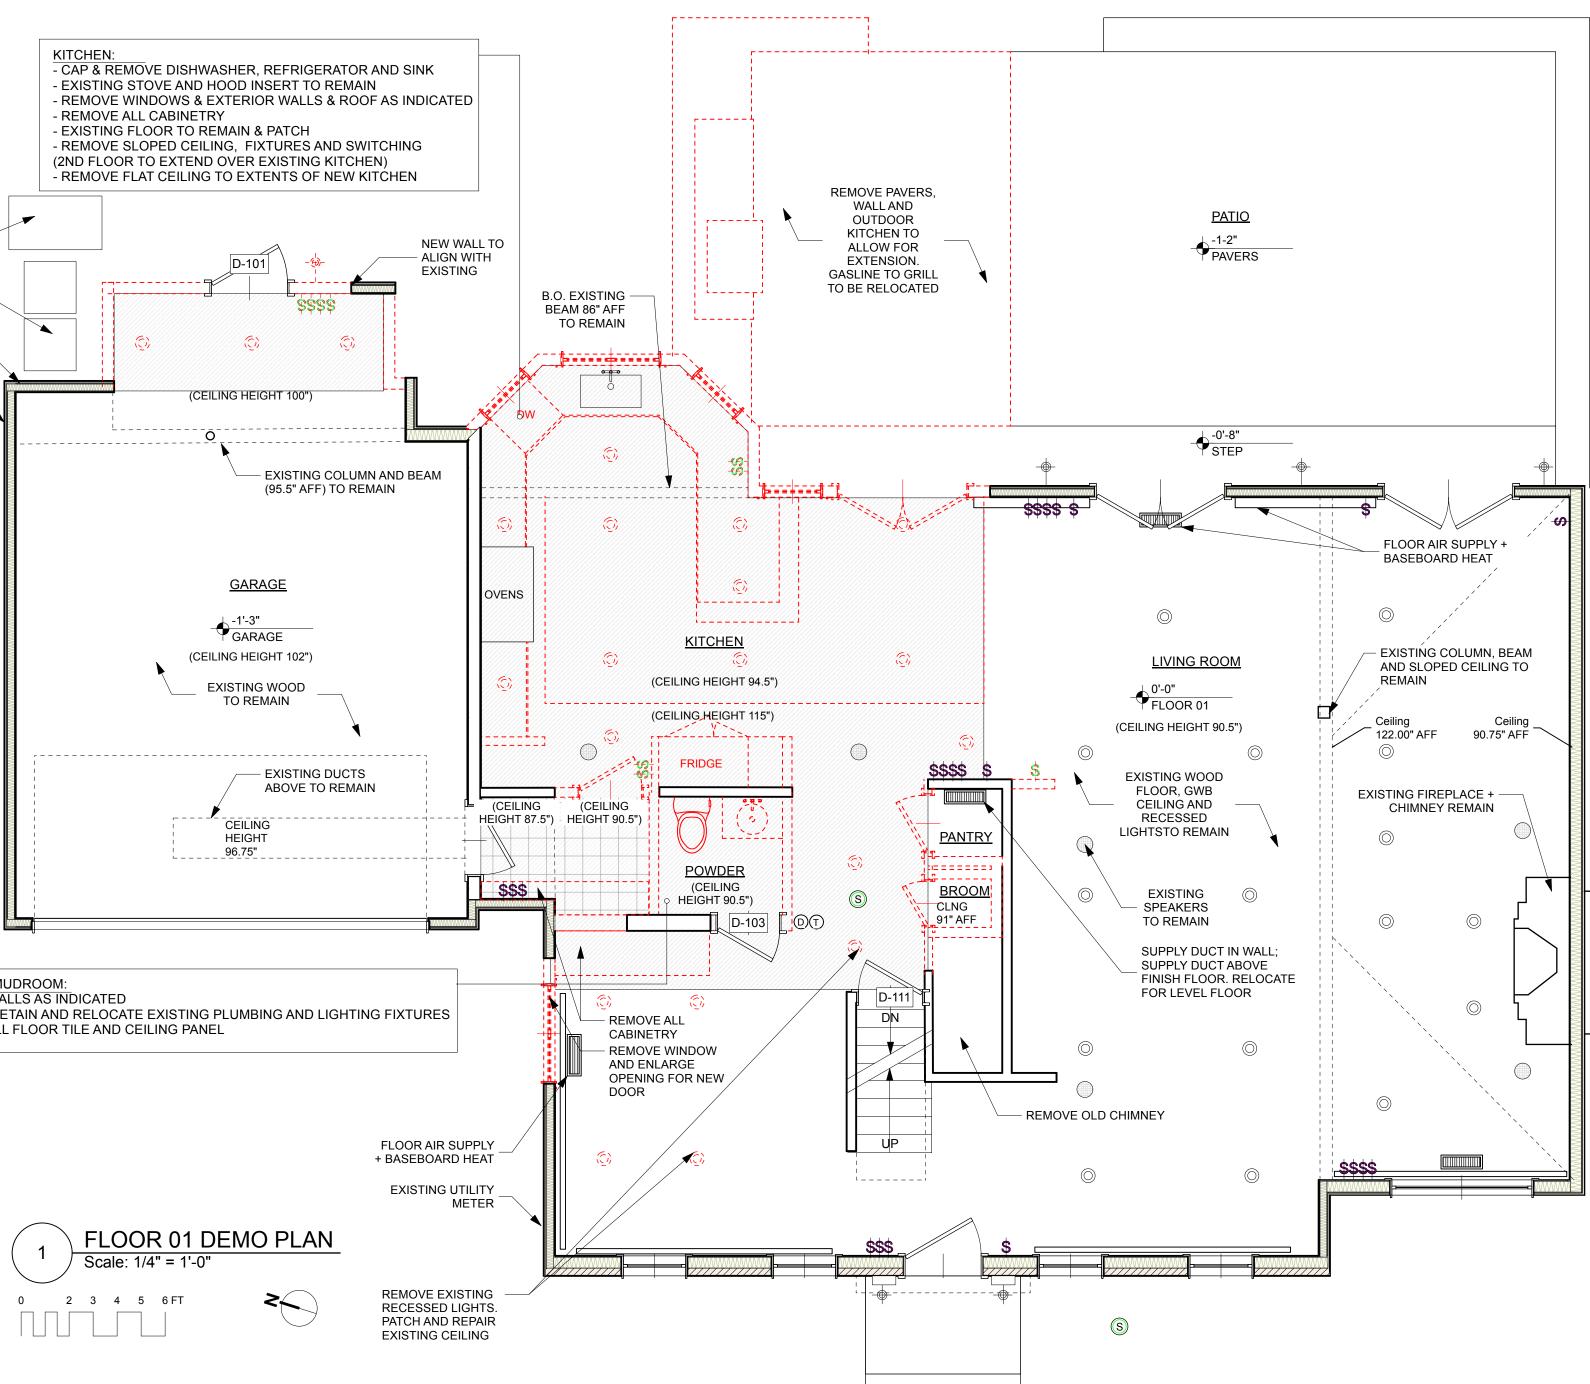

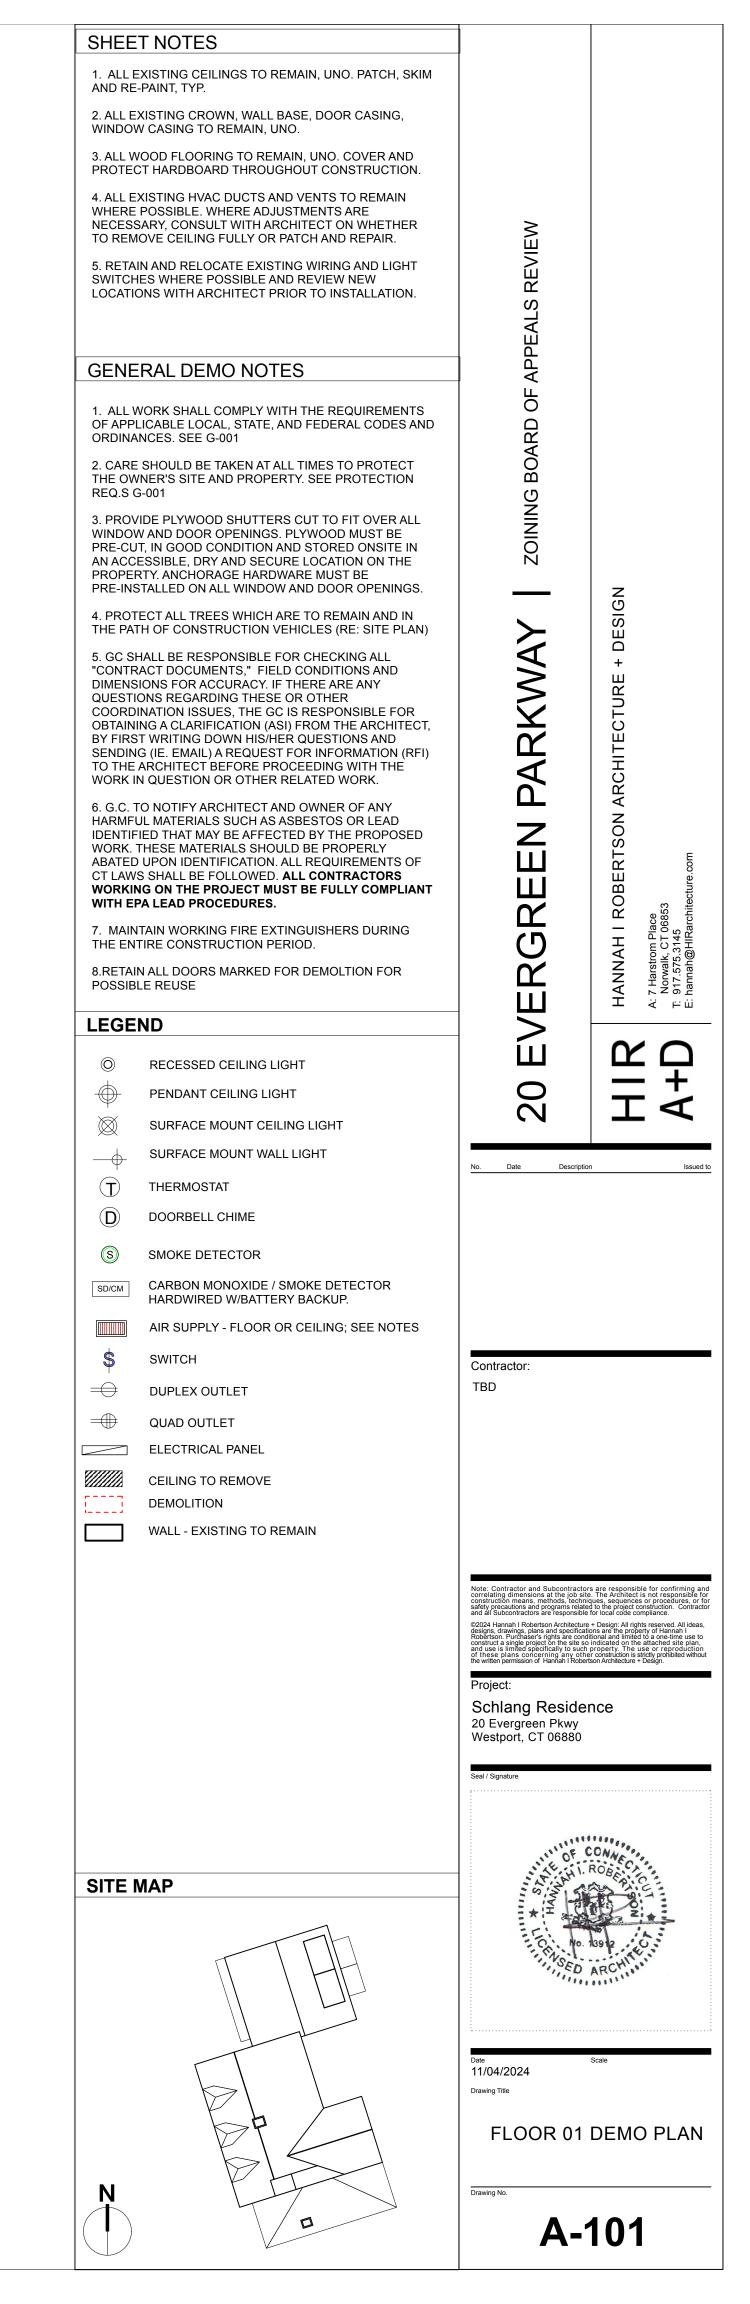




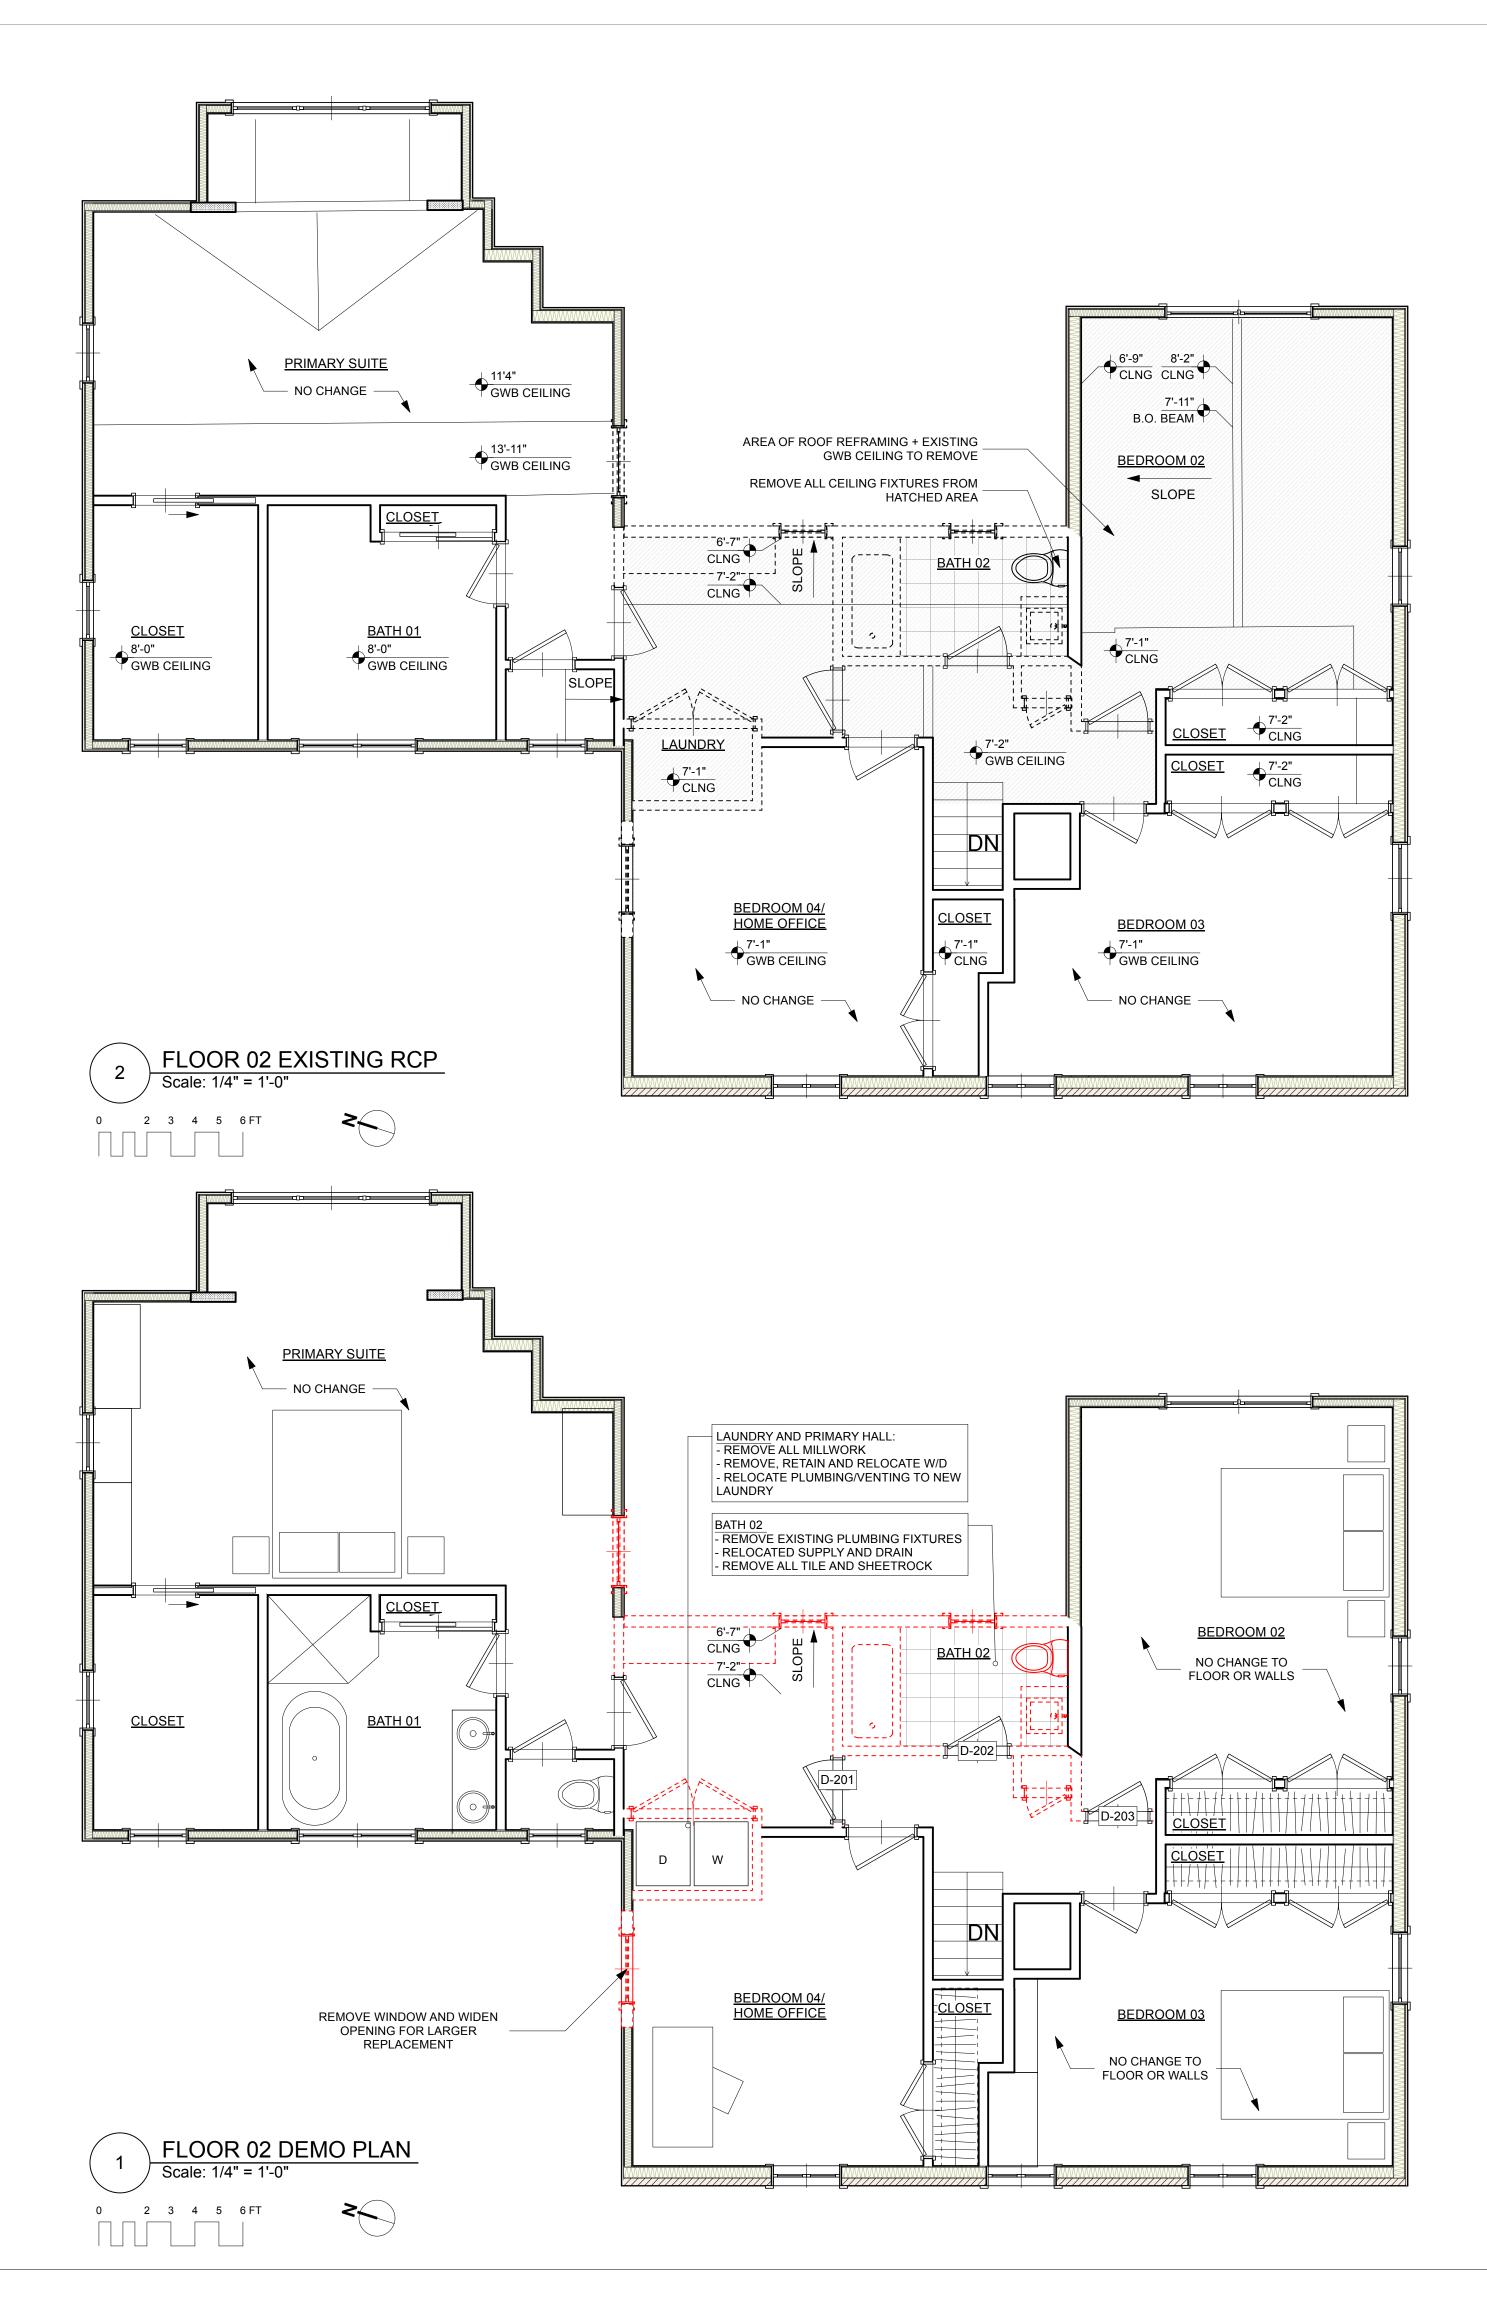


SHEE	TNOTES		
1. ALL E	EXISTING CEILINGS TO REMAIN, UNO. PATCH, SKIM		
	-PAINT, TYP. XISTING CROWN, WALL BASE, DOOR CASING,		
	N CASING TO REMAIN, UNO.		
PROTEC	CT HARDBOARD THROUGHOUT CONSTRUCTION.		
WHERE	POSSIBLE. WHERE ADJUSTMENTS TO REMAIN POSSIBLE. WHERE ADJUSTMENTS ARE SARY, CONSULT WITH ARCHITECT ON WHETHER IOVE CEILING FULLY OR PATCH AND REPAIR.	IEW	
SWITCH	IN AND RELOCATE EXISTING WIRING AND LIGHT IES WHERE POSSIBLE AND REVIEW NEW ONS WITH ARCHITECT PRIOR TO INSTALLATION.	-S REVIEW	
GENE	RAL DEMO NOTES	APPEALS	
OF APPI	VORK SHALL COMPLY WITH THE REQUIREMENTS LICABLE LOCAL, STATE, AND FEDERAL CODES AND NCES. SEE G-001	RD OF ,	
-	E SHOULD BE TAKEN AT ALL TIMES TO PROTECT /NER'S SITE AND PROPERTY. SEE PROTECTION G-001	G BOA	
WINDOW PRE-CU AN ACC PROPER	VIDE PLYWOOD SHUTTERS CUT TO FIT OVER ALL W AND DOOR OPENINGS. PLYWOOD MUST BE T, IN GOOD CONDITION AND STORED ONSITE IN ESSIBLE, DRY AND SECURE LOCATION ON THE RTY. ANCHORAGE HARDWARE MUST BE STALLED ON ALL WINDOW AND DOOR OPENINGS.	ZOINING BOARD OF	z
	ECT ALL TREES WHICH ARE TO REMAIN AND IN TH OF CONSTRUCTION VEHICLES (RE: SITE PLAN)	→ →	ESIG
"CONTR DIMENS QUESTI COORD OBTAIN BY FIRS SENDIN TO THE	HALL BE RESPONSIBLE FOR CHECKING ALL ACT DOCUMENTS," FIELD CONDITIONS AND HONS FOR ACCURACY. IF THERE ARE ANY ONS REGARDING THESE OR OTHER INATION ISSUES, THE GC IS RESPONSIBLE FOR ING A CLARIFICATION (ASI) FROM THE ARCHITECT, FT WRITING DOWN HIS/HER QUESTIONS AND G (IE. EMAIL) A REQUEST FOR INFORMATION (RFI) ARCHITECT BEFORE PROCEEDING WITH THE N QUESTION OR OTHER RELATED WORK.	PARKWAY	□ +
6. G.C. 1 HARMFU IDENTIF WORK. ABATED CT LAW WORKIN	TO NOTIFY ARCHITECT AND OWNER OF ANY JL MATERIALS SUCH AS ASBESTOS OR LEAD TIED THAT MAY BE AFFECTED BY THE PROPOSED THESE MATERIALS SHOULD BE PROPERLY DUPON IDENTIFICATION. ALL REQUIREMENTS OF S SHALL BE FOLLOWED. ALL CONTRACTORS NG ON THE PROJECT MUST BE FULLY COMPLIANT	Z Ш	HANNAH I ROBERTSON ARCHITECTURE Norwalk, CT 06853 f: 917.575.3145 c: hannah@HIRarchitecture.com
7. MAIN	PA LEAD PROCEDURES. ITAIN WORKING FIRE EXTINGUISHERS DURING		I I RO Place r 06853 45 Rarchited
	TIRE CONSTRUCTION PERIOD. N ALL DOORS MARKED FOR DEMOLTION FOR		ANNAH I F Annah I F Harstrom Place Norwalk, CT 0686 917.575.3145 hannah@HIRarch
POSSIB	LE REUSE		HAN A: 7 Hs Nor E: han
	RECESSED CEILING LIGHT PENDANT CEILING LIGHT SURFACE MOUNT CEILING LIGHT SURFACE MOUNT WALL LIGHT	20 EVERGRE	HIR A+D
$ \rightarrow$	THERMOSTAT	No. Date Descripti	on Issued to
	DOORBELL CHIME		
S	SMOKE DETECTOR		
SD/CM	CARBON MONOXIDE / SMOKE DETECTOR HARDWIRED W/BATTERY BACKUP.		
	AIR SUPPLY - FLOOR OR CEILING; SEE NOTES		
\$	SWITCH	Contractor:	
		TBD	
	QUAD OUTLET ELECTRICAL PANEL		
	CEILING TO REMOVE DEMOLITION		
	WALL - EXISTING TO REMAIN		
		Note: Contractor and Subcontractor correlating dimensions at the job si	ors are responsible for confirming and te. The Architect is not responsible for
		construction means, methods, techn safety precautions and programs relat and all Subcontractors are responsibl ©2024 Hannah I Robertson Architectur designs, drawings, plans and specifica	ors are responsible for confirming and the. The Architect is not responsible for inques, sequences or procedures, or for et to the project construction. Contractor e for local code compliance. e + Design: All rights reserved. All ideas, figns are the property of Hannah I
		Robertson. Purchaser's rights are con construct a single project on the site s and use is limited specifically to such of these plans concerning any oth the written permission of Hannah I Robe	e + Design: All rights reserved. All ideas, tions are the property of Harmah I ditional and limited to a one-time use to o indicated on the attached site plan, n property. The use or reproduction rer construction is strictly prohibited without rtson Architecture + Design.
		Project: Schlang Reside	ence
		20 Evergreen Pkwy Westport, CT 06880	
		Seal / Signature	
		INTE OF	CONNEC
SITE	MAP	A S S I	A CC
			3912
	TIL	IN SED	ARCHITE
		Date 11/04/2024 Drawing Title	Scale
1		. – •	OR 02 NG PLAN

Drawing No.

A-102

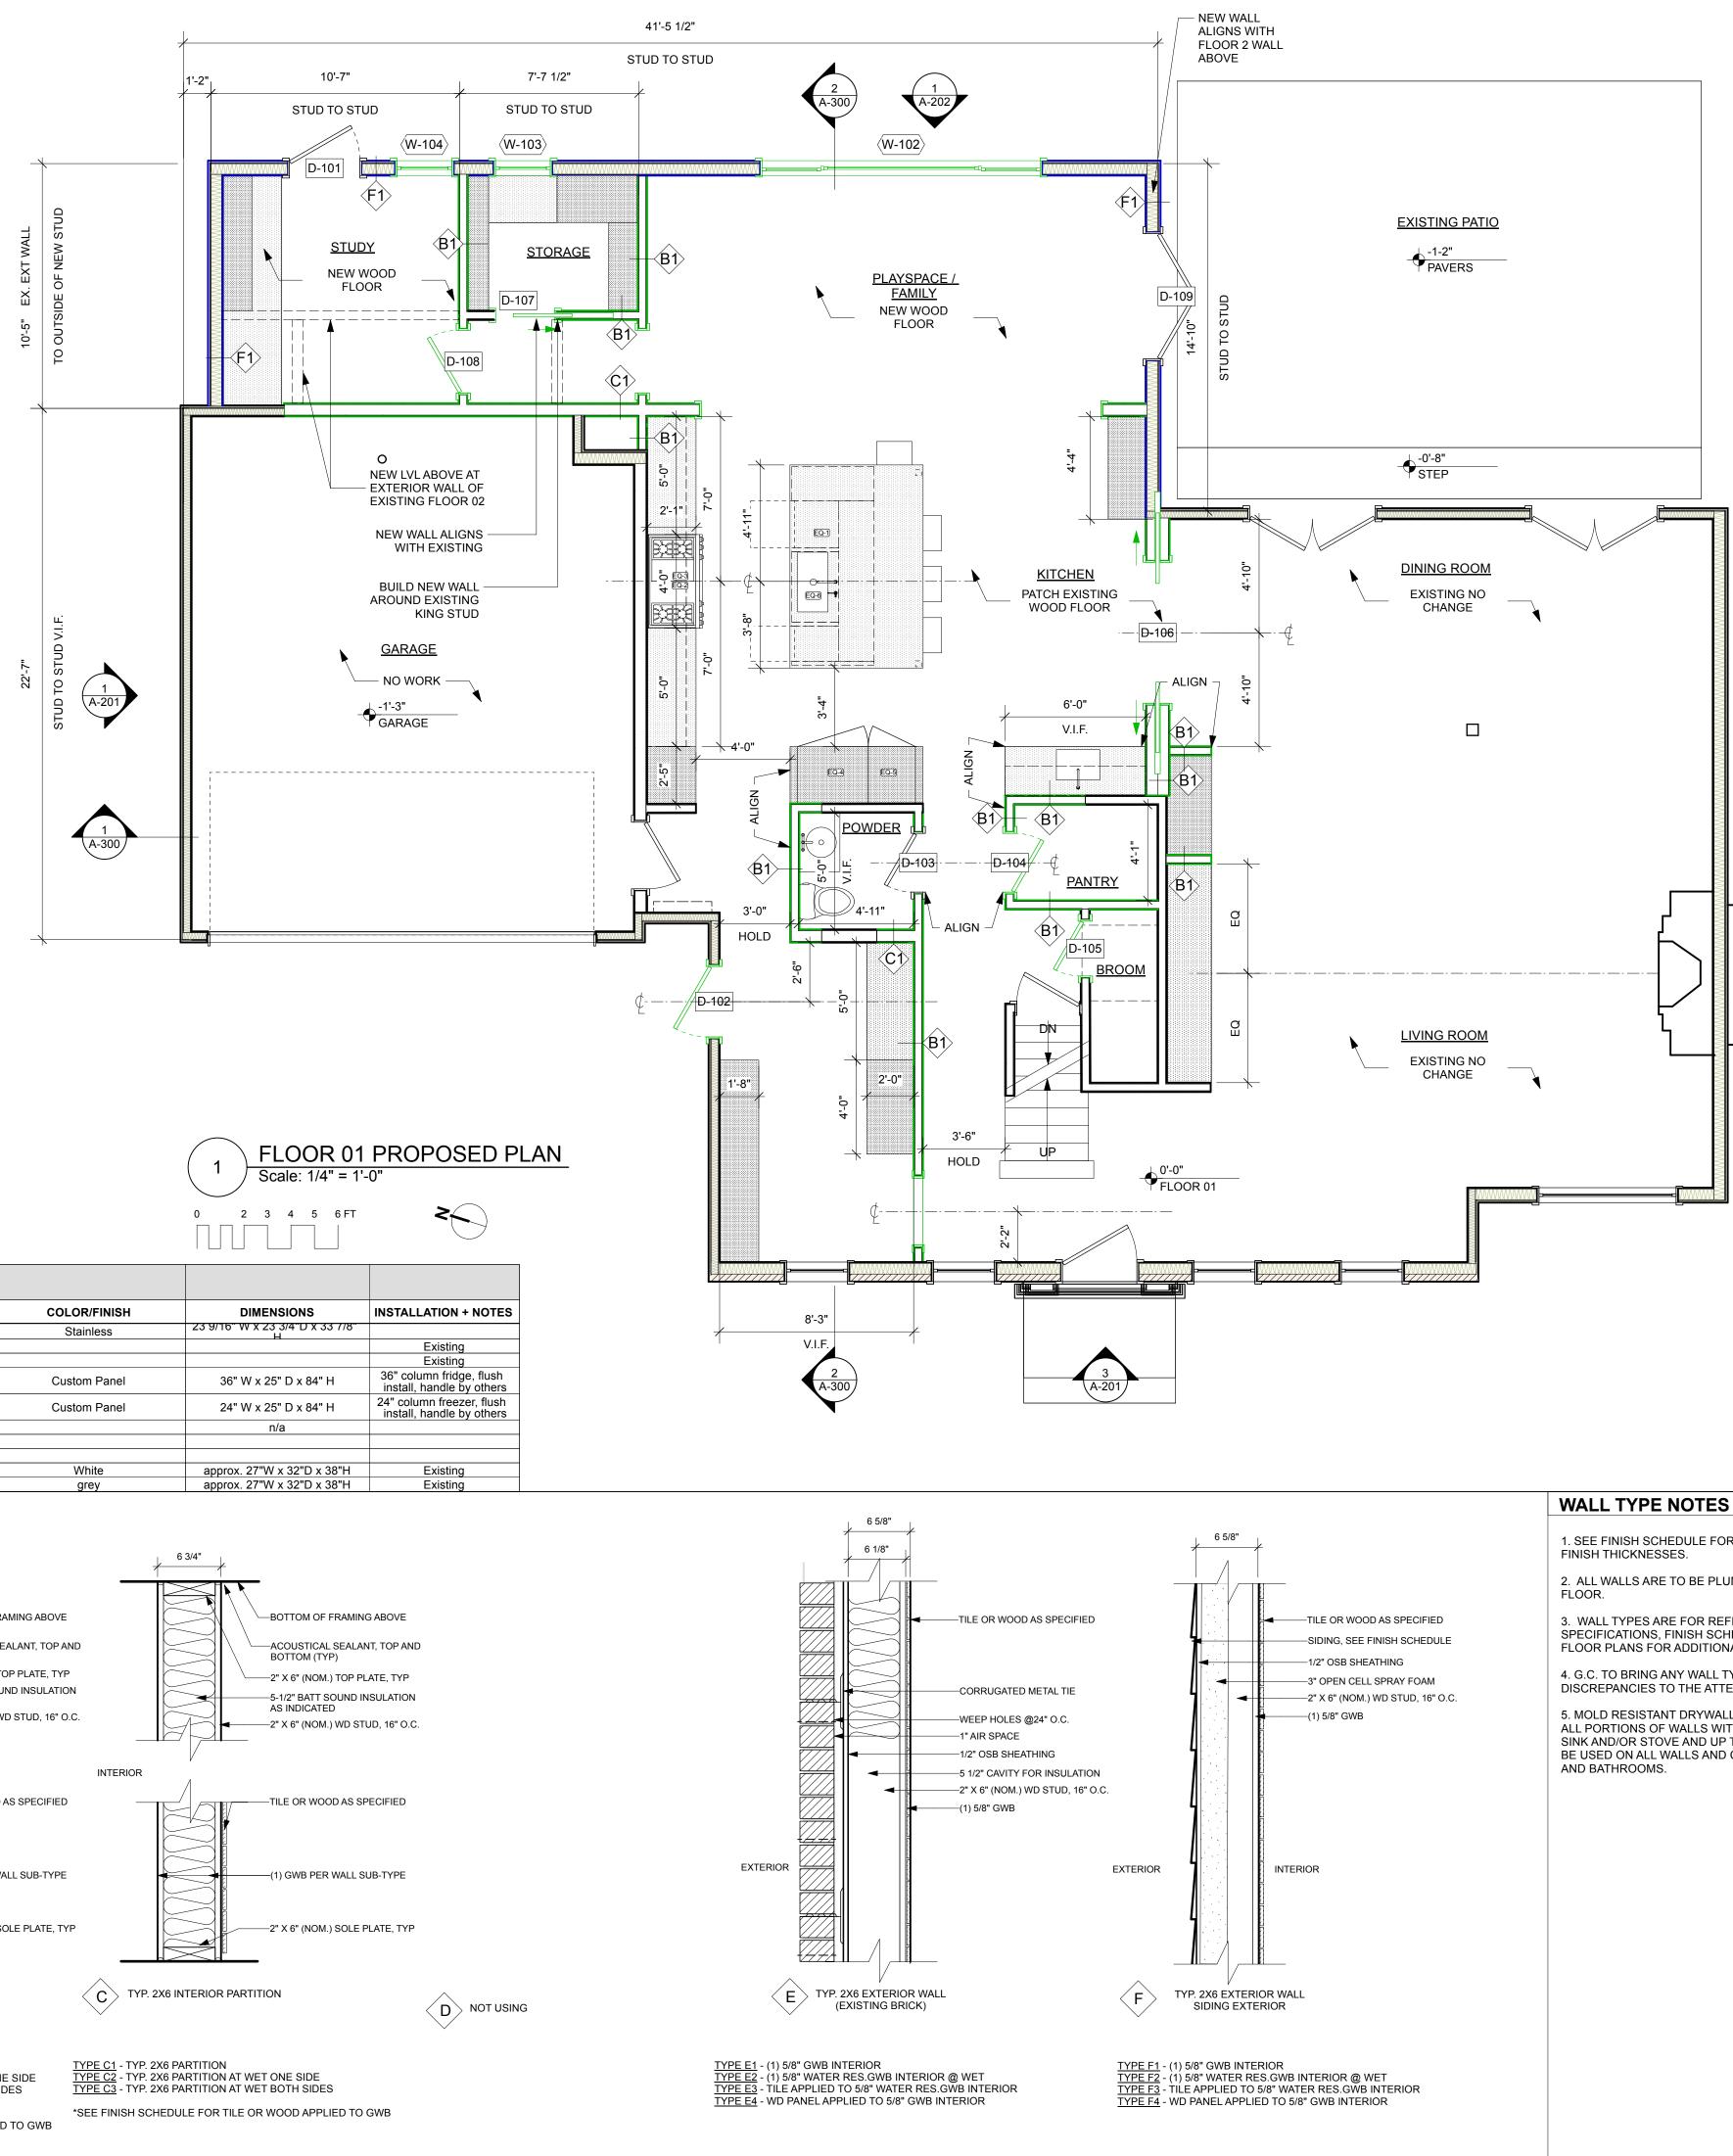

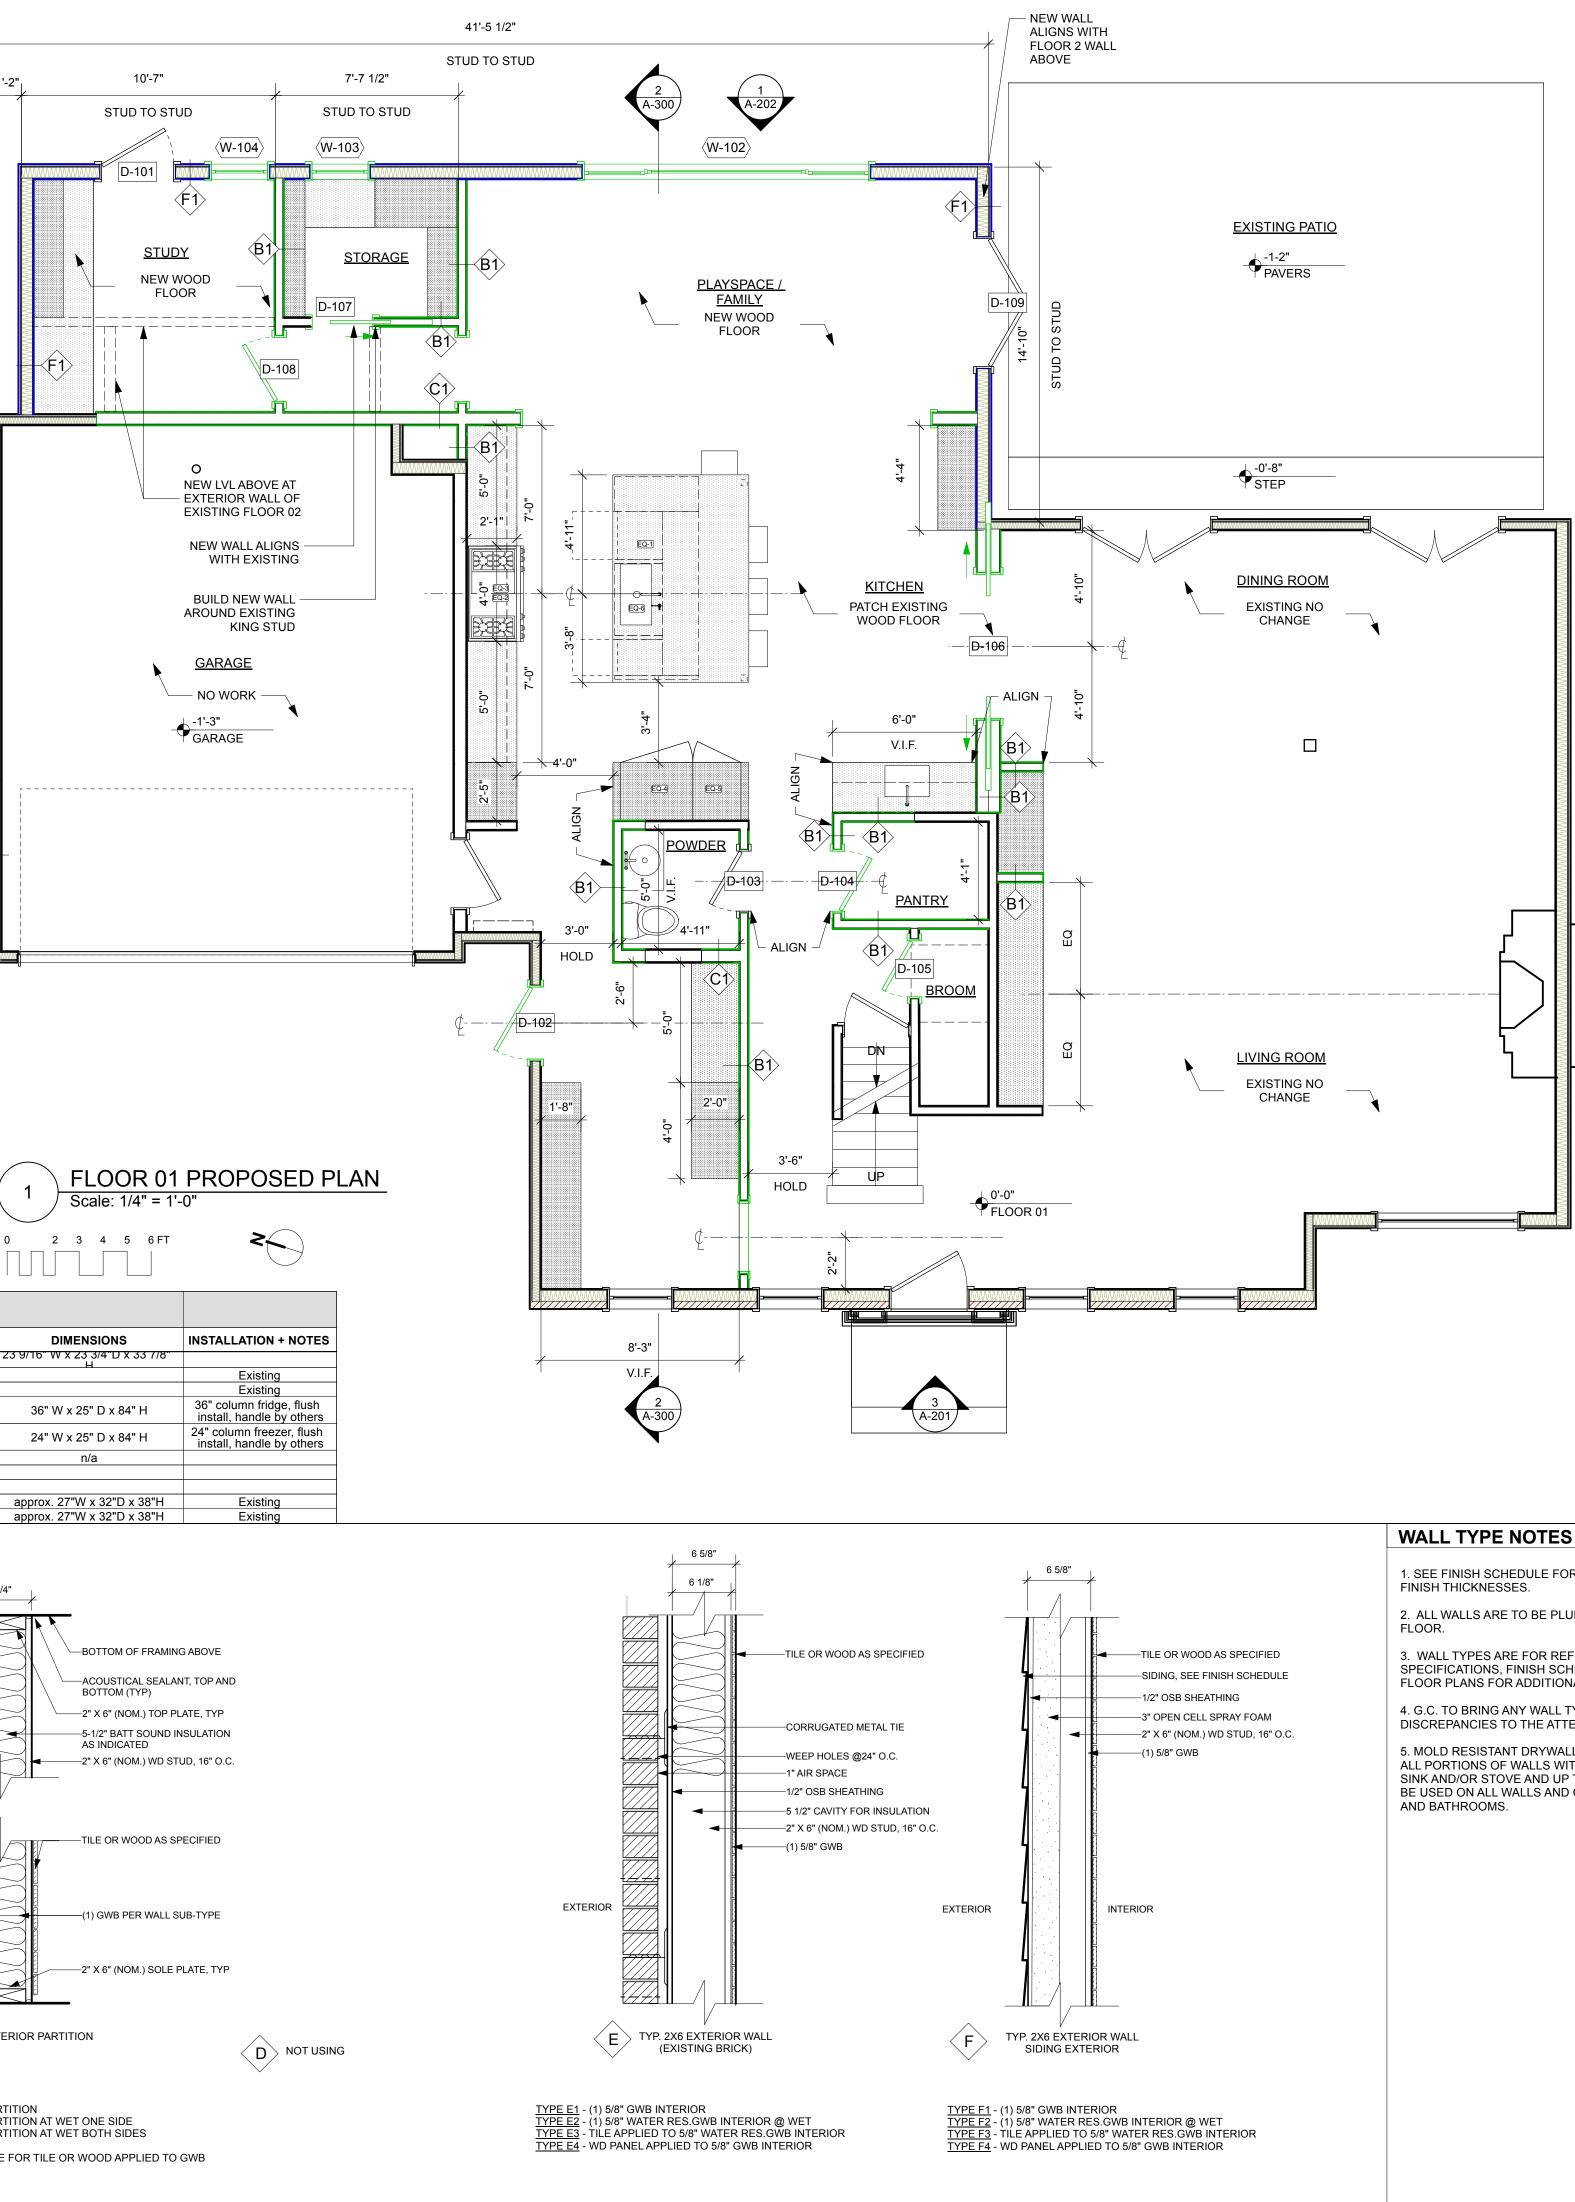

EQUIF	MENT SC	HEDUL	E				
TAG	LOCATION	QTY	APPLIANCE	MANUF.	MODEL	COLOR/FINISH	DIMENSIONS INS [®]
EQ-1	KITCHEN	1	Dishwasher	Bosch	SHE53C85N	Stainless	23 9/16" W X 23 3/4"D X 33 7/8" H
EQ-2	KITCHEN	1	48" Range	Wolf			
EQ-3	KITCHEN	1	48" Hood insert				
EQ-4	KITCHEN	1	Refrigerator	Subzero	DEC3650RID/L	Custom Panel	36" W x 25" D x 84" H
EQ-5	KITCHEN	1	Freezer	Subzero	DEC2450FI/L	Custom Panel	24" W x 25" D x 84" H 24" ins
EQ-6	KITCHEN	1	Garbage Disposal	Insinkerator	Evolution		n/a
EQ-7 EQ-8			Microwave Drawer? Wine fridge?				
EQ-9	LAUNDRY	1	Wine mage: Washer	Electrolux		White	approx. 27"W x 32"D x 38"H
EQ-01	LAUNDRY	1	Dryer	Maytag	MED6630HC	grey	approx. 27"W x 32"D x 38"H
			A1: +3/4" STUCCO APPLIEI EXPOSED SIDE OF CONC WALL, SEE ELEVATIONS A2: +THIN VENEER APPLIE EXPOSED SIDE OF CONC WALL, SEE ELEVATIONS 10" CONCRETE WALL, SEE STRUCTURAL DRAWINGS	RETE	ACOUSTICAL BOTTOM (TYF -2" X 4" (NOM.) -3-1/2" BATT SC AS INDICATED) TOP PLATE, TYP OUND INSULATION	BOTTOM OF FRAMING ABOY ACOUSTICAL SEALANT, TOF BOTTOM (TYP) -2" X 6" (NOM.) TOP PLATE, T -5-1/2" BATT SOUND INSULAT AS INDICATED -2" X 6" (NOM.) WD STUD, 16"
	EXTERIOR FROSTLINE	· · ·	COND. SPACES ONLY 5/8" MOLD RESISTANT GW 2" X 4" (NOM.) FURRING	/В		INTERIOR	TILE OR WOOD AS SPECIFIE
	•	· ·	3" OPEN CELL SPRAY FOA INSULATION W/ 3 3/4" FUR SEALANT, TOP AND BOTTO (TYP)	RRING		WALL SUB-TYPE	(1) GWB PER WALL SUB-TYP
	A TYP. F		WALL	B TYP. 2X4	INTERIOR PARTITION	SOLE PLATE, TYP	2" X 6" (NOM.) SOLE PLATE,
	3/4" \$ <u>TYPE A2</u> - TYP. STOP <u>TYPE A3</u> - TYP. 3/4" \$ <u>TYPE A4</u> - TYP.	STUCCO FINIS FOUNDATION NE VENEER F FOUNDATION STUCCO FINIS FOUNDATION	SH EXTERIOR	<u>TYPE B3</u> - TYP. 2X4 V T <u>YPE B4</u> - TYP. 2X4 P	PARTITION PARTITION AT WET LOCATION OF VALL AT WET LOCATION BOTH PARTITION AT CHASE WALL ULE FOR TILE OR WOOD APPLI	SIDES <u>TYPE C3</u> - TYP. 23 *SEE FINISH SCH	X6 PARTITION X6 PARTITION AT WET ONE SIDE X6 PARTITION AT WET BOTH SIDES IEDULE FOR TILE OR WOOD APPLIED TO GWB

1. SEE FINISH SCHEDULE FOR ALL WALL FINISH TYPES AND

2. ALL WALLS ARE TO BE PLUMB, LEVEL, AND SQUARE TO

3. WALL TYPES ARE FOR REFERENCE ONLY, SEE SPECIFICATIONS, FINISH SCHEDULE, WALL SECTIONS, AND FLOOR PLANS FOR ADDITIONAL DETAILS.

4. G.C. TO BRING ANY WALL TYPE OR DIMENSIONAL DISCREPANCIES TO THE ATTENTION OF THE ARCHITECT.

5. MOLD RESISTANT DRYWALL IS REQUIRED TO BE USED ON ALL PORTIONS OF WALLS WITHIN 2 FEET OF A KITCHEN SINK AND/OR STOVE AND UP TO 4 FEET HIGH. MUST ALSO BE USED ON ALL WALLS AND CEILINGS IN LAUNDRY ROOMS

SHEET NOTES

1. INTERIOR DIMENSIONS SHOWN OUTSIDE OF STUD TO OUTSIDE OF STUD. "HOLD TO" DIMENSIONS ARE TO FACE OF FINISH,

2. EXTERIOR DIMENSIONS TO EXTERIOR OF SHEATHING

3. WHERE POSSIBLE, WINDOWS ALIGN ON CENTER WITH THOSE ABOVE AND BELOW. SEE ELEVATIONS FOR ADDITIONAL ALIGNMENT

SMOKE /CO2 DETECTOR NOTES

1. SD/CO2 DETECTORS SHOWN IN PLAN FOR APPROXIMATE LOCATION ONLY AND DO NOT INDICATE CEILING OR WALL MOUNT. COORDINATE LOCATION IN FIELD WITH ARCHITECT.

2. EACH SMOKE DETECTOR/CARBON MONOXIDE DETECTOR SHALL BE INSTALLED OUTSIDE OF EACH SLEEPING ROOM IN THE IMMEDIATE VICINITY OR WITHIN 15' OF THE ENTRANCE TO A SLEEPING ROOM; IN EACH ROOM USED FOR SLEEPING PURPOSES AND ON EACH STORY WITHIN A DWELLING UNIT, INCLUDING BELOW GRADE STORIES.

3. EACH SMOKE DETECTOR/CARBON MONOXIDE DETECTOR SHALL BE OF TYPE THAT ALLOWS FOR READILY TESTING OF SUCH DEVICE.

4. CEILING MOUNTED DEVICES SHALL BE A MINIMUM DISTANCE OF 4" FROM ANY WALL.

5. WALL MOUNTED DEVICES SHALL BE A MINIMUM OF 4" AND MAXIMUM OF 12" FROM THE CEILING.

FINISH NOTES

1. VERIFY FINAL LIST OF FINISHES AND MATERIALS WITH ARCHITECT PRIOR TO PLACING ANY ORDERS.

2. INTERIOR DIMENSIONS ARE FOR GENERAL PLANNING PURPOSES ONLY AND SHOULD NOT BE USED FOR CONSTRUCTION. FOLLOW STUD TO STUD DIMESIONS PROVIDED ON FLOOR PLANS.

3. CONTRACTOR TO PROVIDE SAMPLES FOR ALL WOOD AND STONE SELECTION PRIOR TO PURCHASE. BID SHALL INCLUDE TEMPLATING, INSTALLATION, AND ANY OTHER NECESSARY WORK REQUIRED TO COMPLETE THE INSTALLATION.

4. ALL TILE/STONE TO BE INSTALLED PER MANUFACTURERS INSTRUCTIONS WHEN THEY EXIST OR PER RECOMMENDATIONS OF PRODUCT REPRESENTATIVE.

5. SUBSTRATE GROUT, WATERPROOFING MEMBRANE SEALANT, AND ANY ADDITIONAL MATERIALS NECESSARY TO COMPLETE TILE WORK SHALL BE THE CONTRACTORS RESPONSIBILITY AND SHALL BE INCLUDED IN THE PRICING.

6. GC TO PROVIDE 2' X 2' CONTROL SAMPLE OF TILE WITH GROUT AND SEALER TO BE APPROVED BY ARCHITECT PRIOR TO INSTALLATION.

7. REVIEW PROPOSED TILE LAYOUT W/ARCHITECT PRIOR TO INSTALLATION.


8. WOOD FLOORS SHALL BE TREATED WITH NON-TOXIC SEALER ONLY. ALL PLYWOOD MUST BE FORMALDEHYDE FREE.

9. GC TO PROVIDE MOCK-UP OF ALL STAINS, PAINTS, AND SEALERS FOR ARCHITECT'S REVIEW.

LEGEND

- RECESSED CEILING LIGHT \odot
- $-\bigcirc$ PENDANT CEILING LIGHT
- \bigotimes SURFACE MOUNT CEILING LIGHT SURFACE MOUNT WALL LIGHT
- \oplus (\mathbf{T}) THERMOSTAT
- DOORBELL CHIME
- SMOKE DETECTOR
- SD/CM CARBON MONOXIDE / SMOKE DETECTOR
- HARDWIRED W/BATTERY BACKUP. AIR SUPPLY - FLOOR OR CEILING; SEE NOTES
- \$ SWITCH
- QUAD OUTLET
- ELECTRICAL PANEL
- WALL INTERIOR NEW
- WALL EXTERIOR NEW 20002000
- WALL EXISTING TO REMAIN

SITE MAP

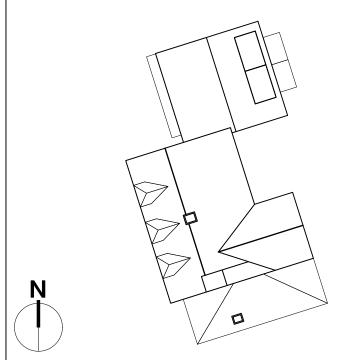

RE S ΑF ЧO ARD 0 മ Ċ Ň _____ ~ RKWA ()ш 4 Ζ Ш Ш RO Ŷ C NAH 7 Harstrol Norwalk, 917.575.3 Ľ Ш I ≍ ⊬ü КÖ Ш - + 0 Т A \mathbf{N} No. Date Description Issued to Contractor: TBD Project Schlang Residence 20 Evergreen Pkwy Westport, CT 06880

11/04/2024 Drawing Title


Drawing No.

FLOOR 01 PLAN



(<u>2</u> (A-201 /

\ A-30(

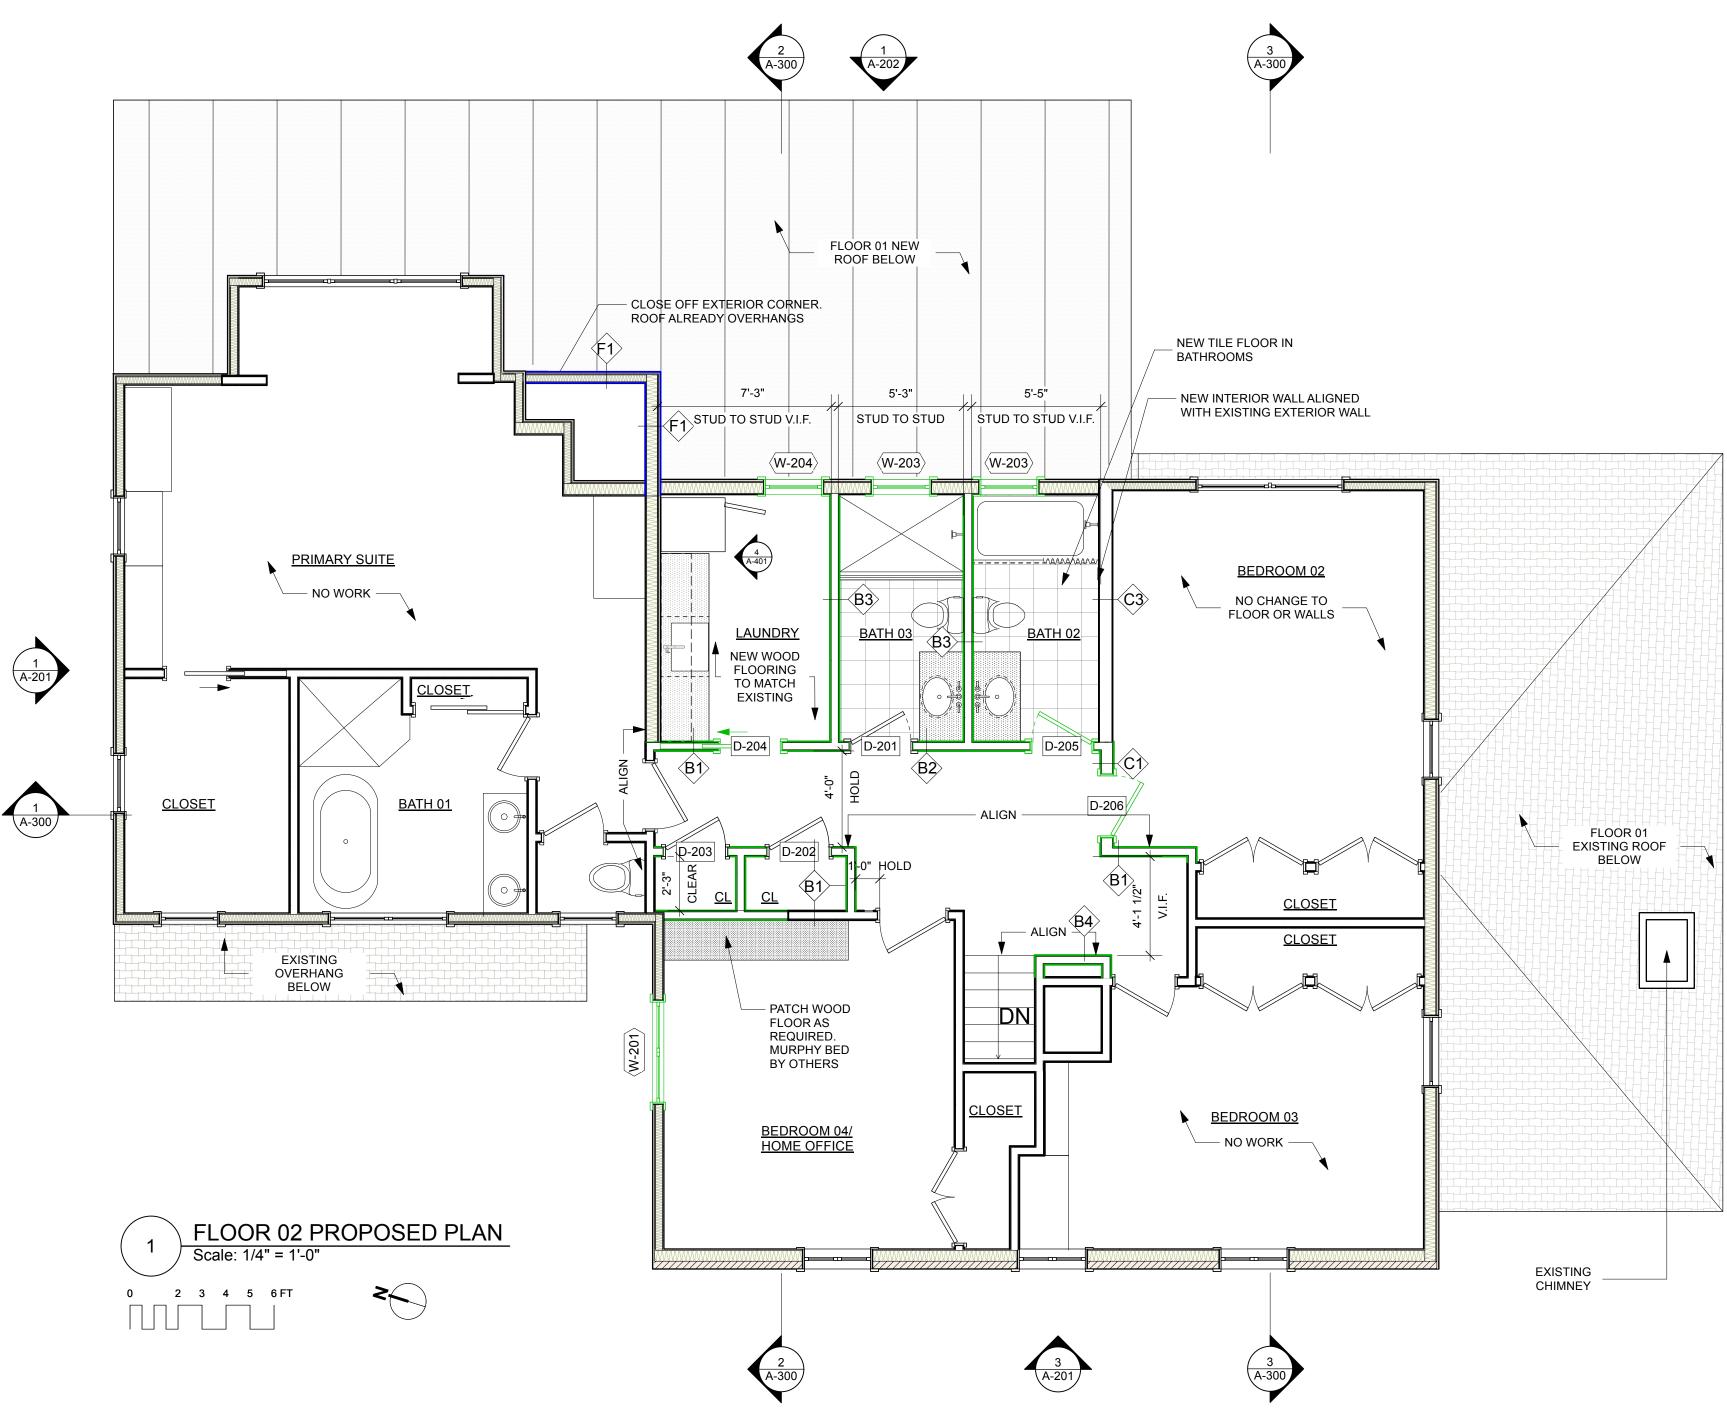

OOR S	CHEDULE															
		Location	N	Iominal Siz	e	Туре		Dooi	r Frame			Manufacturer Data				
Mark	Room Name		Width	Height	Thickness	Configuration	Top Shape	Jamb Thick	Jamb Depth	Mfr	Model No.	Panel detail	Door Finish (Exterior)	Door Finish (Interior)	Hardware Set	Comments
D- 101	Side Entry Front	Exterior	3'0"	6'8"	1 3/4"	Swing Simple	Square	3/4"	7 5/8"	Trustile	TBD	TBD	Primed	Primed	-	Existing (Relocated)
D- 102	Side Entry Front	Exterior	3'0"	6'11"	1 3/4"	Swing Simple	Square	3/4"	5 5/8"	Trustile	TBD	TBD	Primed	Primed	-	New
D- 103	Powder Room	Interior	2'6"	6'8"	1 3/4"	Swing Simple	Square	3/4"	4 3/4"	Trustile	TS1000	step (OS) flat panel	Primed	Primed	-	Existing (Relocated)
D- 104	Pantry	Interior	2'6"	6'8"	1 3/4"	Swing Simple	Square	3/4"	4 3/4"	Trustile	TS1000	step (OS) flat panel	Primed	Primed	-	New
D- 105	Broom	Interior	2'4"	6'8"	1 3/4"	Swing Simple	Square	3/4"	4 3/4"	Trustile	TS1000	step (OS) flat panel	Primed	Primed	-	New
D- 106	Kitchen/Dining	Interior	6'0"	6'8"	1 3/4"	Pocket Bi-part	Square	3/4"	1'0 1/4"	Trustile	TS1000	step (OS) flat panel	Primed	Primed	-	New
D- 107	Storage	Interior	2'6"	6'8"	1 3/4"	Pocket Simple	Square	3/4"	4 3/4"	Trustile	TS1000	step (OS) flat panel	Primed	Primed	-	New
D- 108	Office	Interior	2'8"	6'8"		Swing Simple	Square	3/4"	4 3/4"	Trustile	TS1000	step (OS) flat panel	Primed	Primed	-	New
D- 109	Patio	Exterior	5'4"	6'8"		Swing Bi-part	Square	3/4"	7 5/8"	Trustile	TS1000	step (OS) flat panel	Primed	Primed	-	Existing to Remain
D- 201	Bath 03	Interior	2'6"	6'6"		Swing Simple	Square	3/4"	4 3/4"	Trustile	TS1000	step (OS) flat panel	Primed	Primed	-	Existing (Relocated)
D- 202	Hall Closet	Interior	2'6"	6'6"		Swing Simple	Square	1"	4 3/4"	Trustile	TS1000	step (OS) flat panel	Primed	Primed	-	Existing (Relocated)
D- 203	Hall Closet	Interior	2'6"	6'6"	1 3/4"	Swing Simple	Square	1"	4 3/4"	Trustile	TS1000	step (OS) flat panel	Primed	Primed	-	Existing (Relocated)
D- 204	Laundry	Interior	2'6"	6'6"	1 3/4"	Pocket Simple	Square	3/4"	4 3/4"	Trustile	TS1000	step (OS) flat panel	Primed	Primed	-	New
D- 205	Bath 02	Interior	2'6"	6'6"	1 3/4"	Swing Simple	Square	3/4"	4 3/4"	Trustile	TS1000	step (OS) flat panel	Primed	Primed	-	New
D- 206	Bedroom 02	Exterior	2'6"	6'6"	1 3/4"	Swing Simple	Square	3/4"	6 3/4"						-	Existing (Relocated)

	WINDC	OW SCHEDULE	E													
	Rough Opening			Rough Opening Operation						Manufacturer Data						
	Mark	Room Name	R.O. Width	R.O. Height	Elevation Set At	Elevation	Sash Operation	Exterior Finish	Interior Window Finish	Mfr	Model	Model No.	Horizontal Muntins	Vertical Muntins	Comments	
W-	102	Family	12'0"	5'0"	Sill of Window	1'7"	Custom	White	White	TBD	TBD	TBD	0	1		
W-	103	Storage	2'6"	3'4"	Sill of Window	3'0"	Casement	White	White	TBD	TBD	TBD	2	1		
W-	104	Office	2'6"	3'4"	Sill of Window	3'0"	Casement	White	White	TBD	TBD	TBD	2	1		
W-	201	Bedroom 04	4'4"	4'0"	Sill of Window	2'7"	Bi-parting Casement	White	White	TBD	TBD	TBD	1	1		
W-	203	Bath 03	2'6"	3'4"	Sill of Window	3'4"	Casement	White	White	TBD	TBD	TBD	2	1		
W-	203	Bath 03	2'6"	3'4"	Sill of Window	3'4"	Casement	White	White	TBD	TBD	TBD	2	1		
W-	204	Laundry	2'6"	3'4"	Sill of Window	3'4"	Casement	White	White	TBD	TBD	TBD	2	1		

SHEET NOTES

1. INTERIOR DIMENSIONS SHOWN OUTSIDE OF STUD TO OUTSIDE OF STUD. "HOLD TO" DIMENSIONS ARE TO FACE OF FINISH,

2. EXTERIOR DIMENSIONS TO EXTERIOR OF SHEATHING

3. WHERE POSSIBLE, WINDOWS ALIGN ON CENTER WITH THOSE ABOVE AND BELOW. SEE ELEVATIONS FOR ADDITIONAL ALIGNMENT

SMOKE /CO2 DETECTOR NOTES

1. SD/CO2 DETECTORS SHOWN IN PLAN FOR APPROXIMATE LOCATION ONLY AND DO NOT INDICATE CEILING OR WALL MOUNT. COORDINATE LOCATION IN FIELD WITH ARCHITECT.

2. EACH SMOKE DETECTOR/CARBON MONOXIDE DETECTOR SHALL BE INSTALLED OUTSIDE OF EACH SLEEPING ROOM IN THE IMMEDIATE VICINITY OR WITHIN 15' OF THE ENTRANCE TO A SLEEPING ROOM; IN EACH ROOM USED FOR SLEEPING PURPOSES AND ON EACH STORY WITHIN A DWELLING UNIT, INCLUDING BELOW GRADE STORIES.

3. EACH SMOKE DETECTOR/CARBON MONOXIDE DETECTOR SHALL BE OF TYPE THAT ALLOWS FOR READILY TESTING OF SUCH DEVICE.

4. CEILING MOUNTED DEVICES SHALL BE A MINIMUM DISTANCE OF 4" FROM ANY WALL.

5. WALL MOUNTED DEVICES SHALL BE A MINIMUM OF 4" AND MAXIMUM OF 12" FROM THE CEILING.

FINISH NOTES

2 A-201 /

(1) (A-300)

1. VERIFY FINAL LIST OF FINISHES AND MATERIALS WITH ARCHITECT PRIOR TO PLACING ANY ORDERS.

2. INTERIOR DIMENSIONS ARE FOR GENERAL PLANNING PURPOSES ONLY AND SHOULD NOT BE USED FOR CONSTRUCTION. FOLLOW STUD TO STUD DIMESIONS PROVIDED ON FLOOR PLANS.

3. CONTRACTOR TO PROVIDE SAMPLES FOR ALL WOOD AND STONE SELECTION PRIOR TO PURCHASE. BID SHALL INCLUDE TEMPLATING, INSTALLATION, AND ANY OTHER NECESSARY WORK REQUIRED TO COMPLETE THE INSTALLATION.

4. ALL TILE/STONE TO BE INSTALLED PER MANUFACTURERS INSTRUCTIONS WHEN THEY EXIST OR PER RECOMMENDATIONS OF PRODUCT REPRESENTATIVE.

5. SUBSTRATE GROUT, WATERPROOFING MEMBRANE SEALANT, AND ANY ADDITIONAL MATERIALS NECESSARY TO COMPLETE TILE WORK SHALL BE THE CONTRACTORS RESPONSIBILITY AND SHALL BE INCLUDED IN THE PRICING.

6. GC TO PROVIDE 2' X 2' CONTROL SAMPLE OF TILE WITH GROUT AND SEALER TO BE APPROVED BY ARCHITECT PRIOR TO INSTALLATION.

7. REVIEW PROPOSED TILE LAYOUT W/ARCHITECT PRIOR TO INSTALLATION.


8. WOOD FLOORS SHALL BE TREATED WITH NON-TOXIC SEALER ONLY. ALL PLYWOOD MUST BE FORMALDEHYDE FREE.

9. GC TO PROVIDE MOCK-UP OF ALL STAINS, PAINTS, AND SEALERS FOR ARCHITECT'S REVIEW.

LEGEND

O RECESSED CEILING LIGHT

- PENDANT CEILING LIGHT
- SURFACE MOUNT CEILING LIGHT
- T THERMOSTAT
- D DOORBELL CHIME
- S SMOKE DETECTOR
- SD/CM CARBON MONOXIDE / SMOKE DETECTOR HARDWIRED W/BATTERY BACKUP.
- AIR SUPPLY FLOOR OR CEILING; SEE NOTES
- SWITCH
- QUAD OUTLET
- ELECTRICAL PANEL
 - WALL INTERIOR NEW
 - WALL EXTERIOR NEW
- WALL EXISTING TO REMAIN

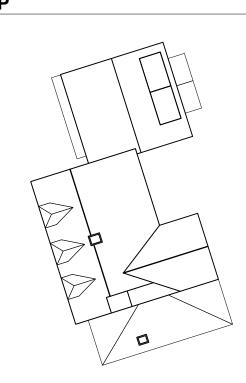



ЯE လု 7 AΡ ЧO ARD Ô ш Ċ -Ñ _____ Z S \succ RKWA + ш C ш Ζ Ш Ш RO $\mathbf{\mathcal{L}}$ — C INAH 7 Harstrol Norwalk, 917.575.3 Ľ Ш I ¥ ⊬ü КĊ Ш 20 Т A No. Date Description Issued to Contractor: TBD Project: Schlang Residence 20 Evergreen Pkwy Westport, CT 06880 11/04/2024 Drawing Title


FLOOR 02 PLAN

Drawing No.



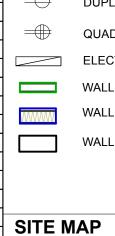


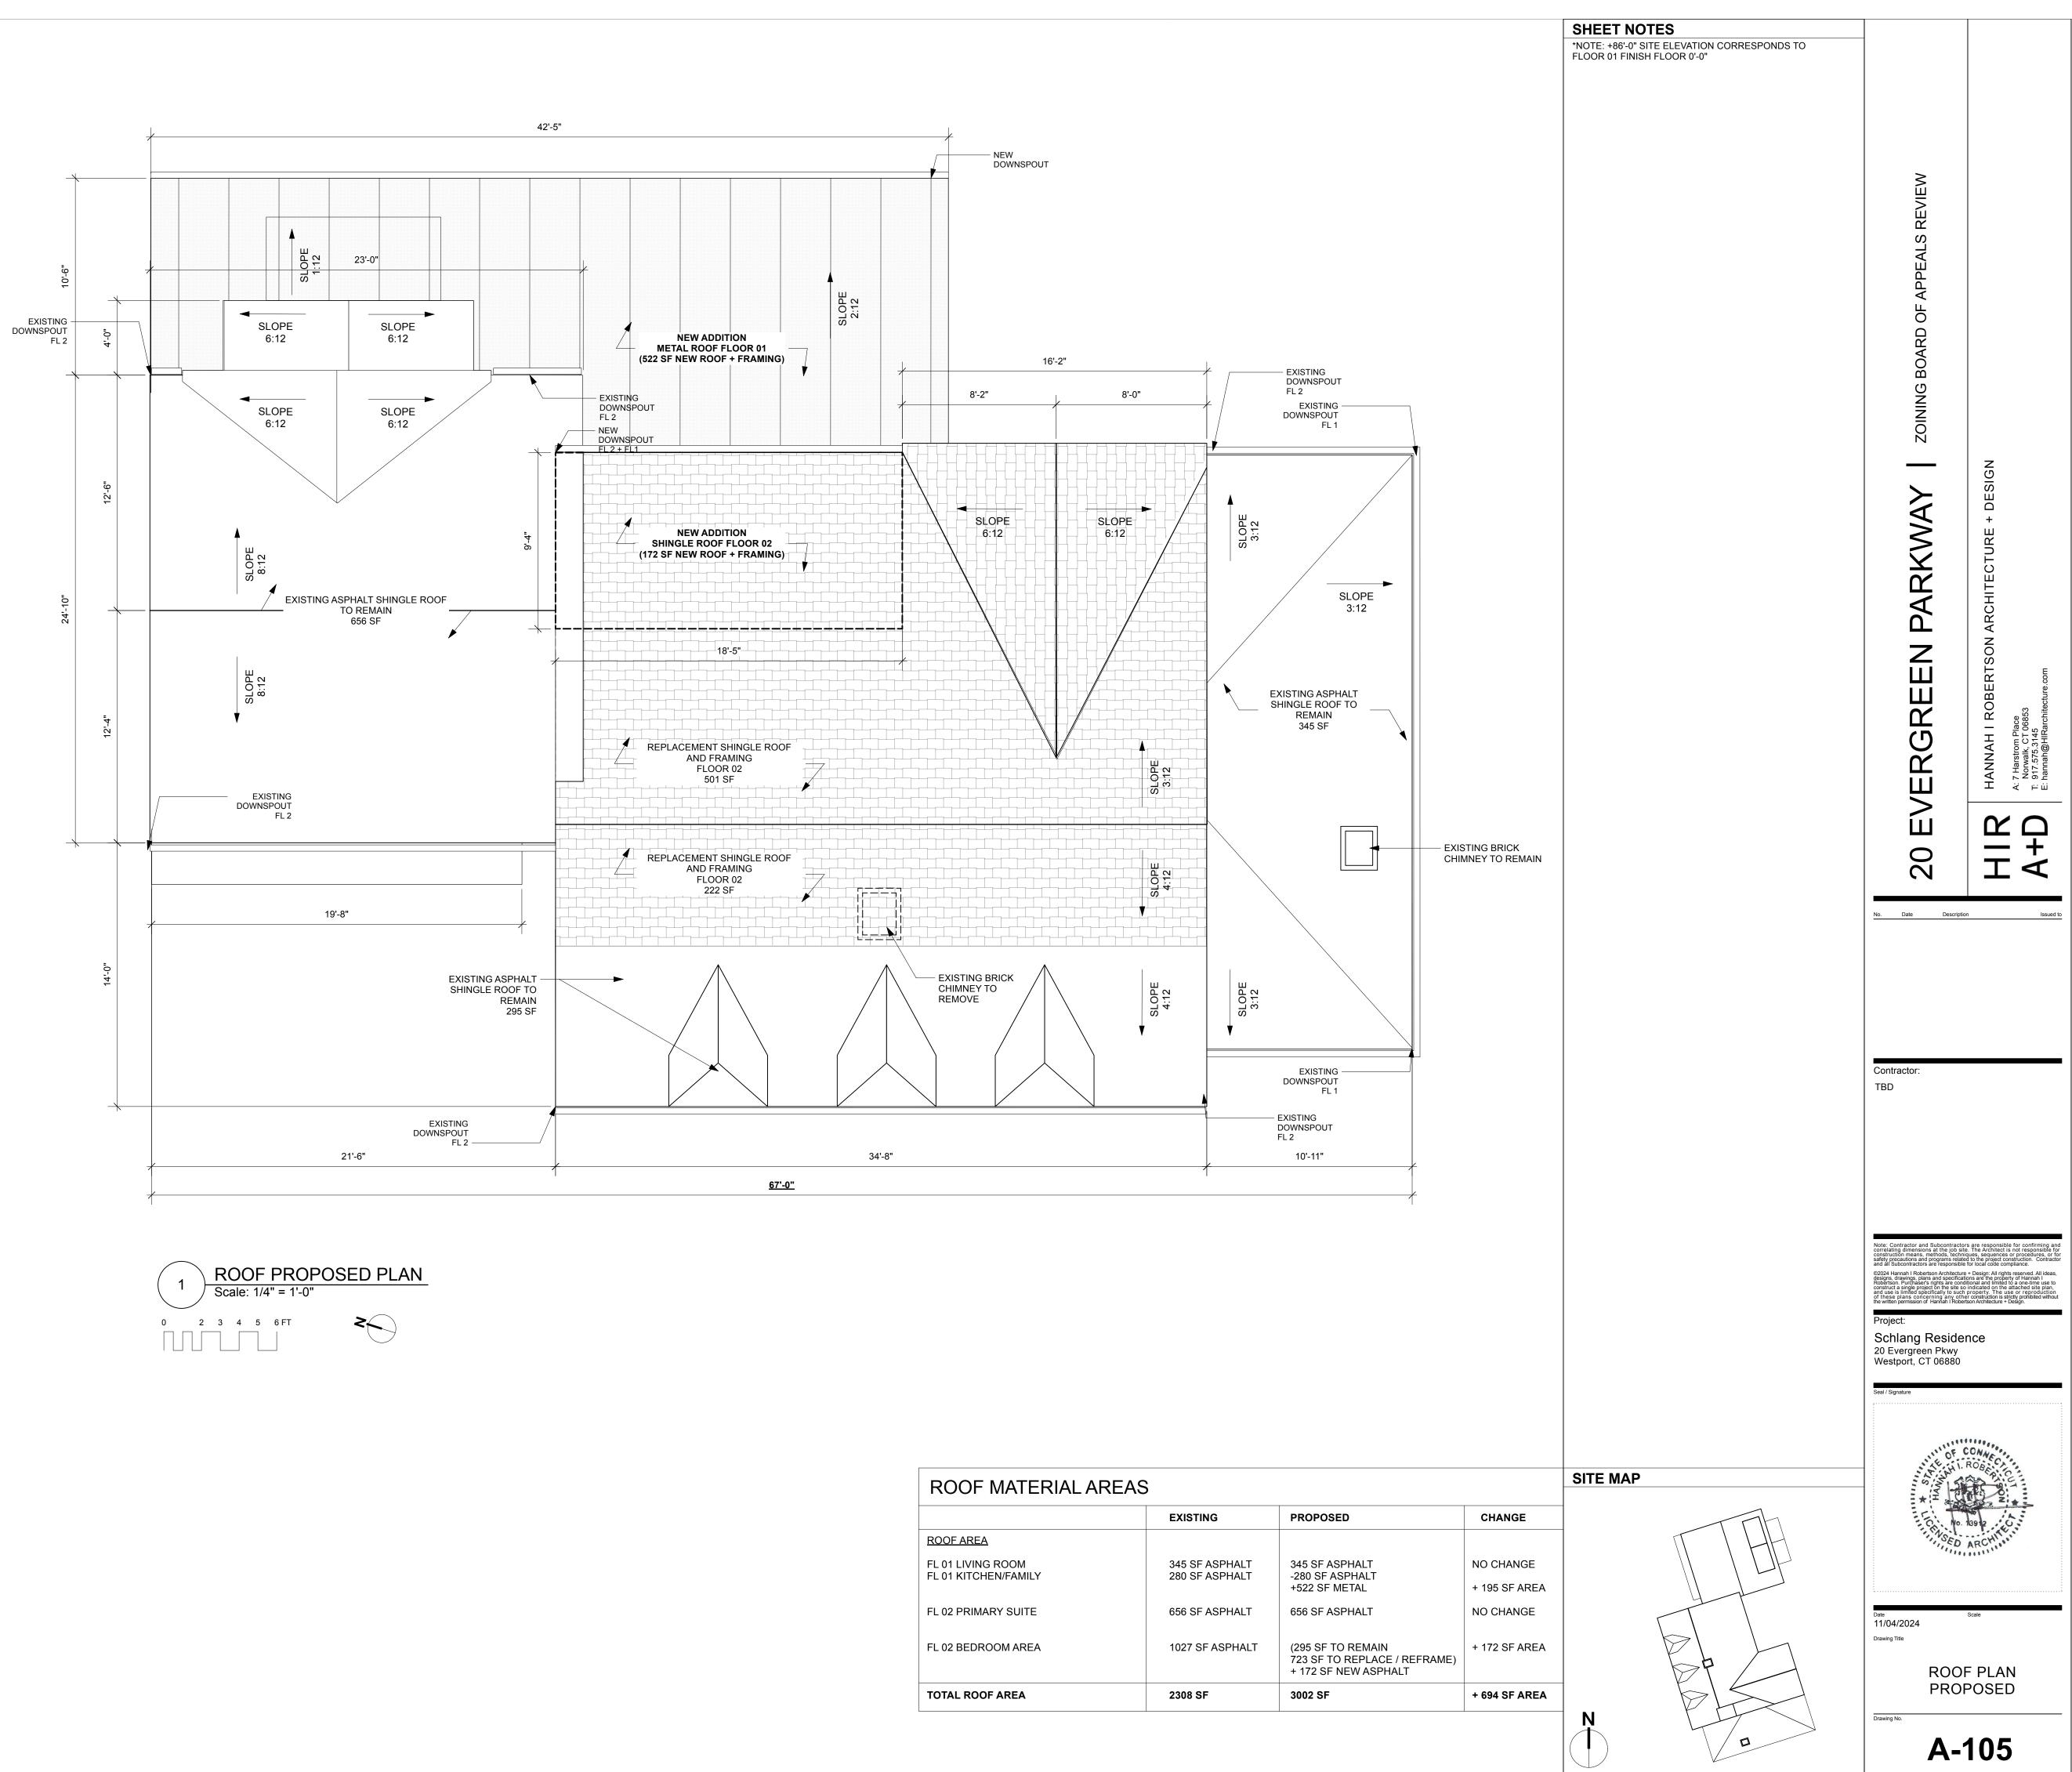

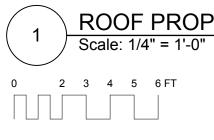





ROOF MATERIAL AREAS							
	EXISTING						
ROOF AREA							
FL 01 LIVING ROOM FL 01 KITCHEN/FAMILY	345 SF ASPHALT 280 SF ASPHALT						
FL 02 PRIMARY SUITE	656 SF ASPHALT						
FL 02 BEDROOM AREA	1027 SF ASPHALT						
TOTAL ROOF AREA	2308 SF						

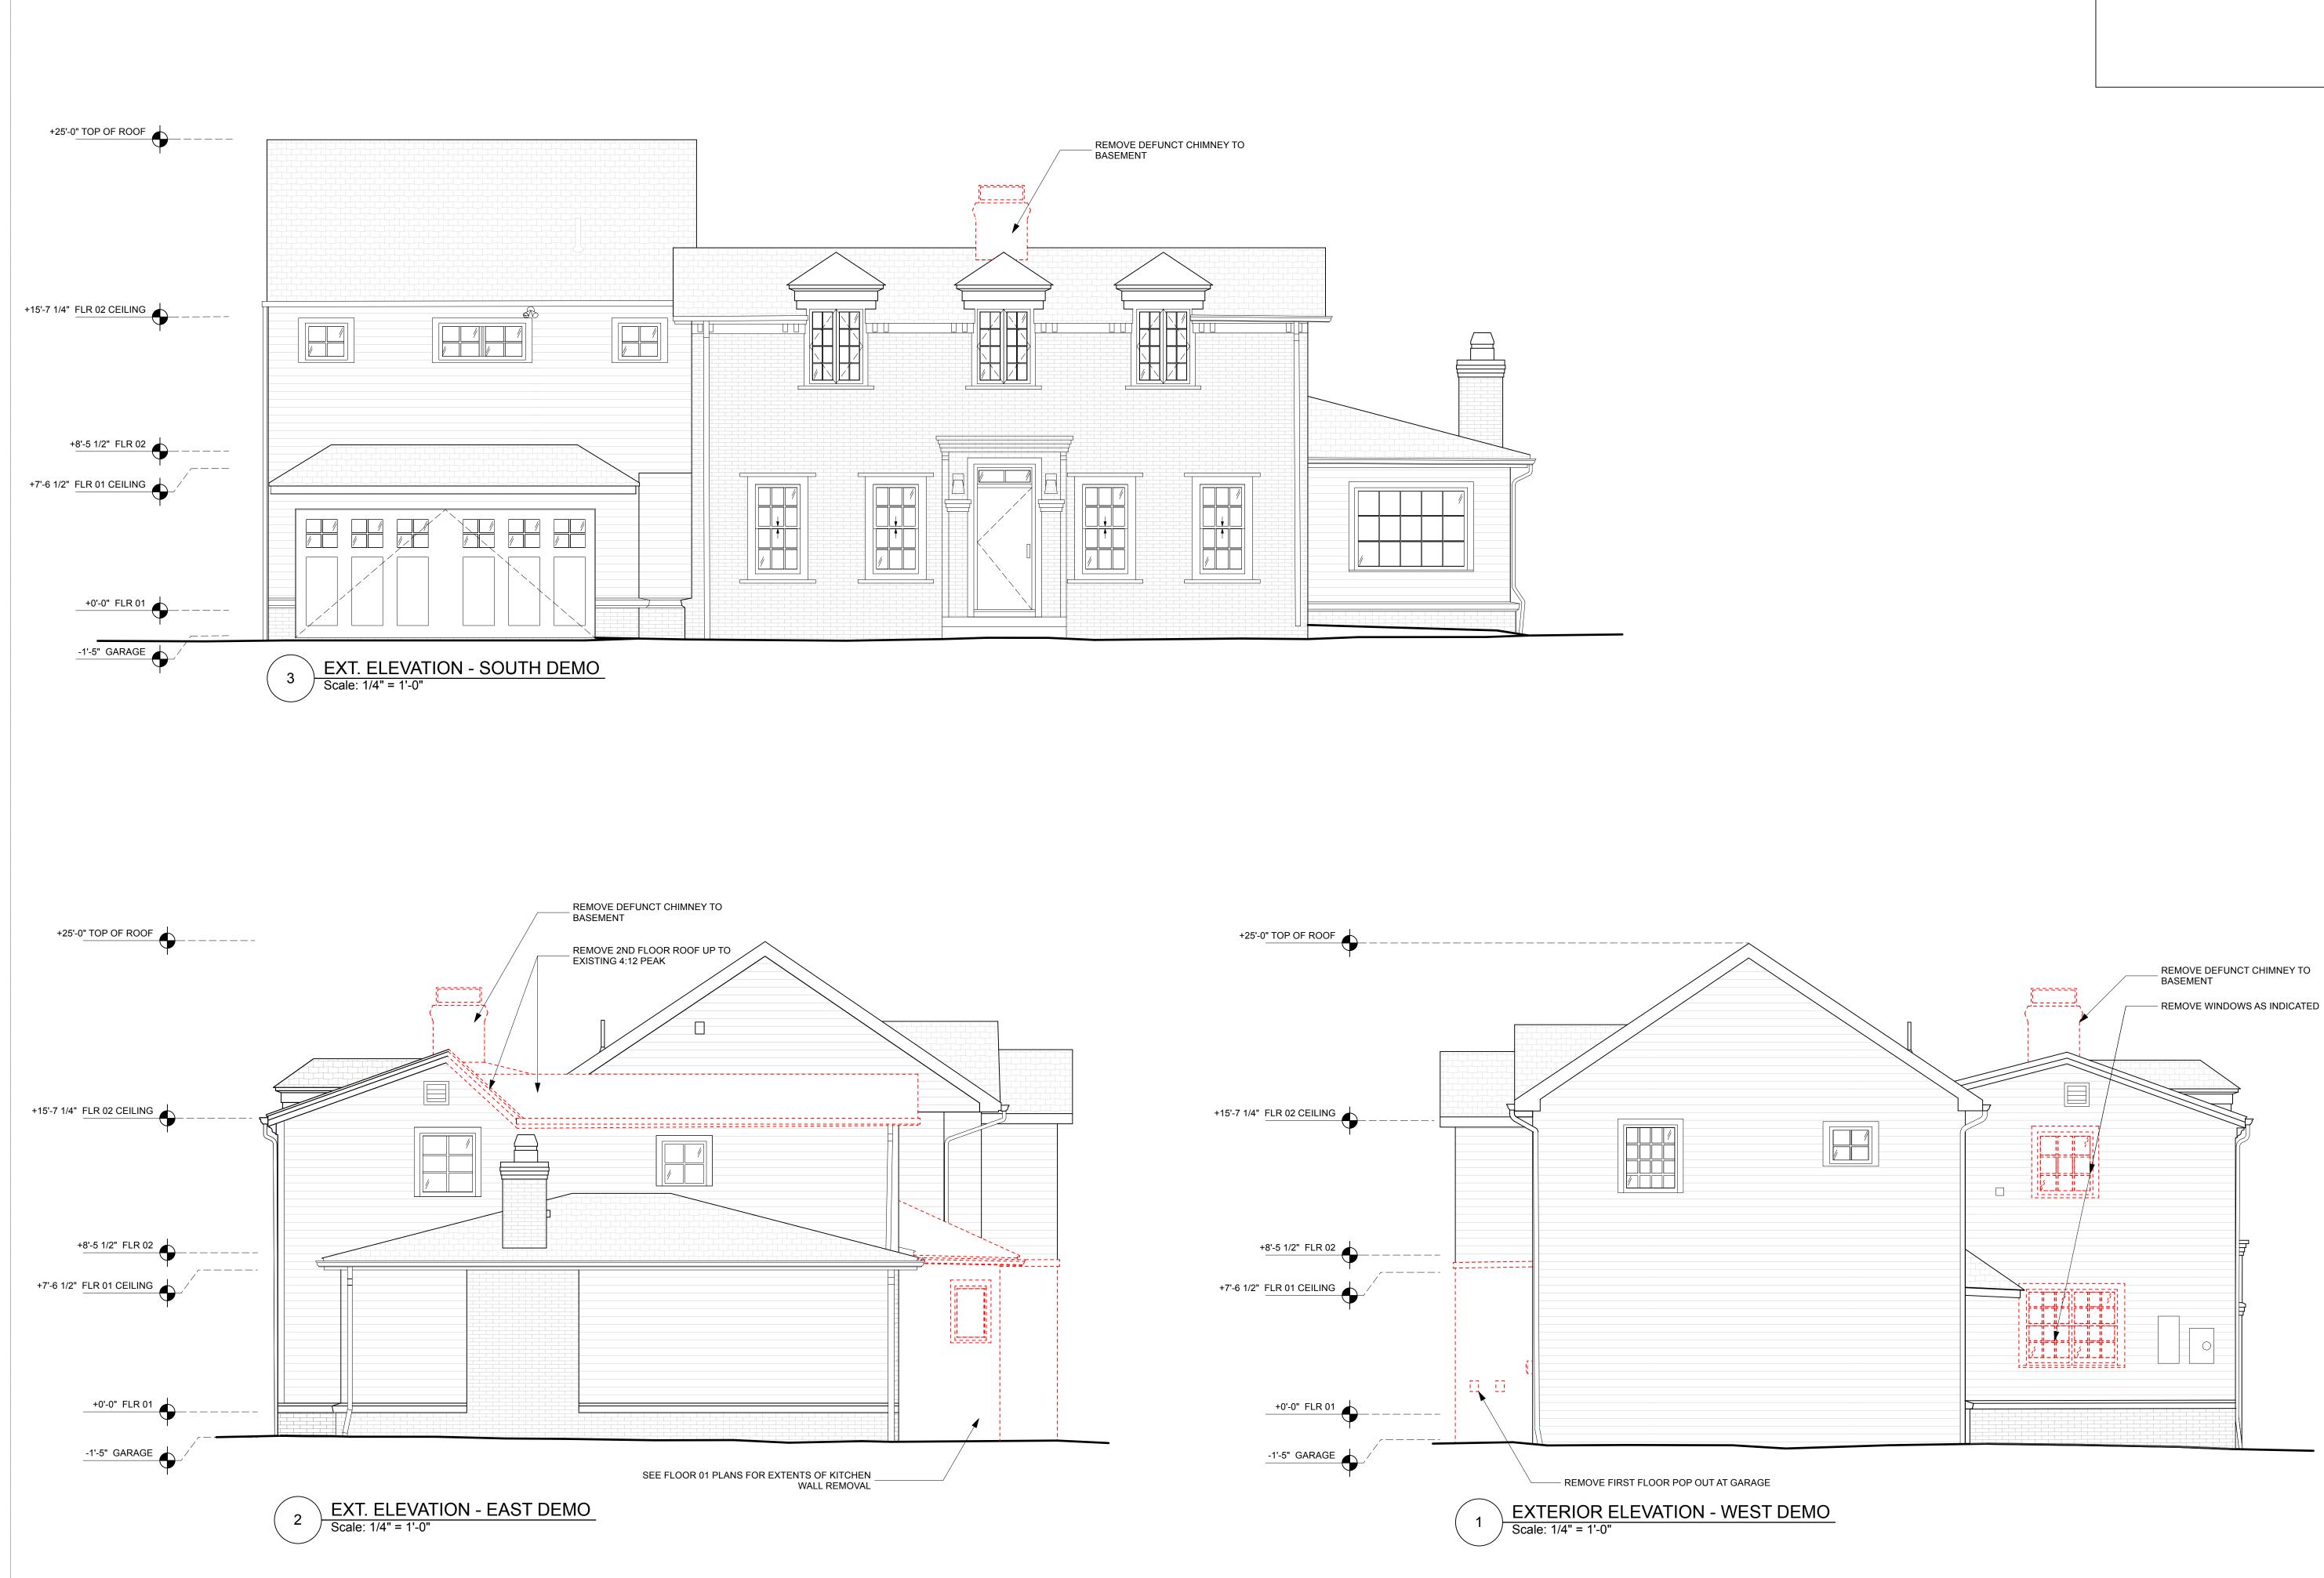

LEGEND

DEMOLITION BRICK WALL ASPHALT SHINGLE CLAPBOARD SIDING

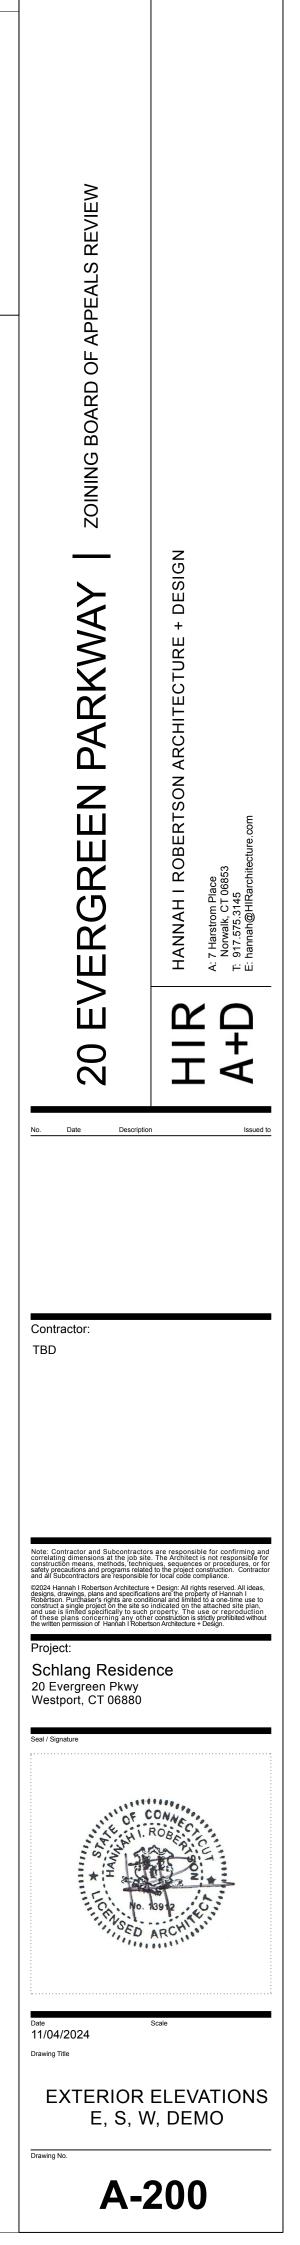

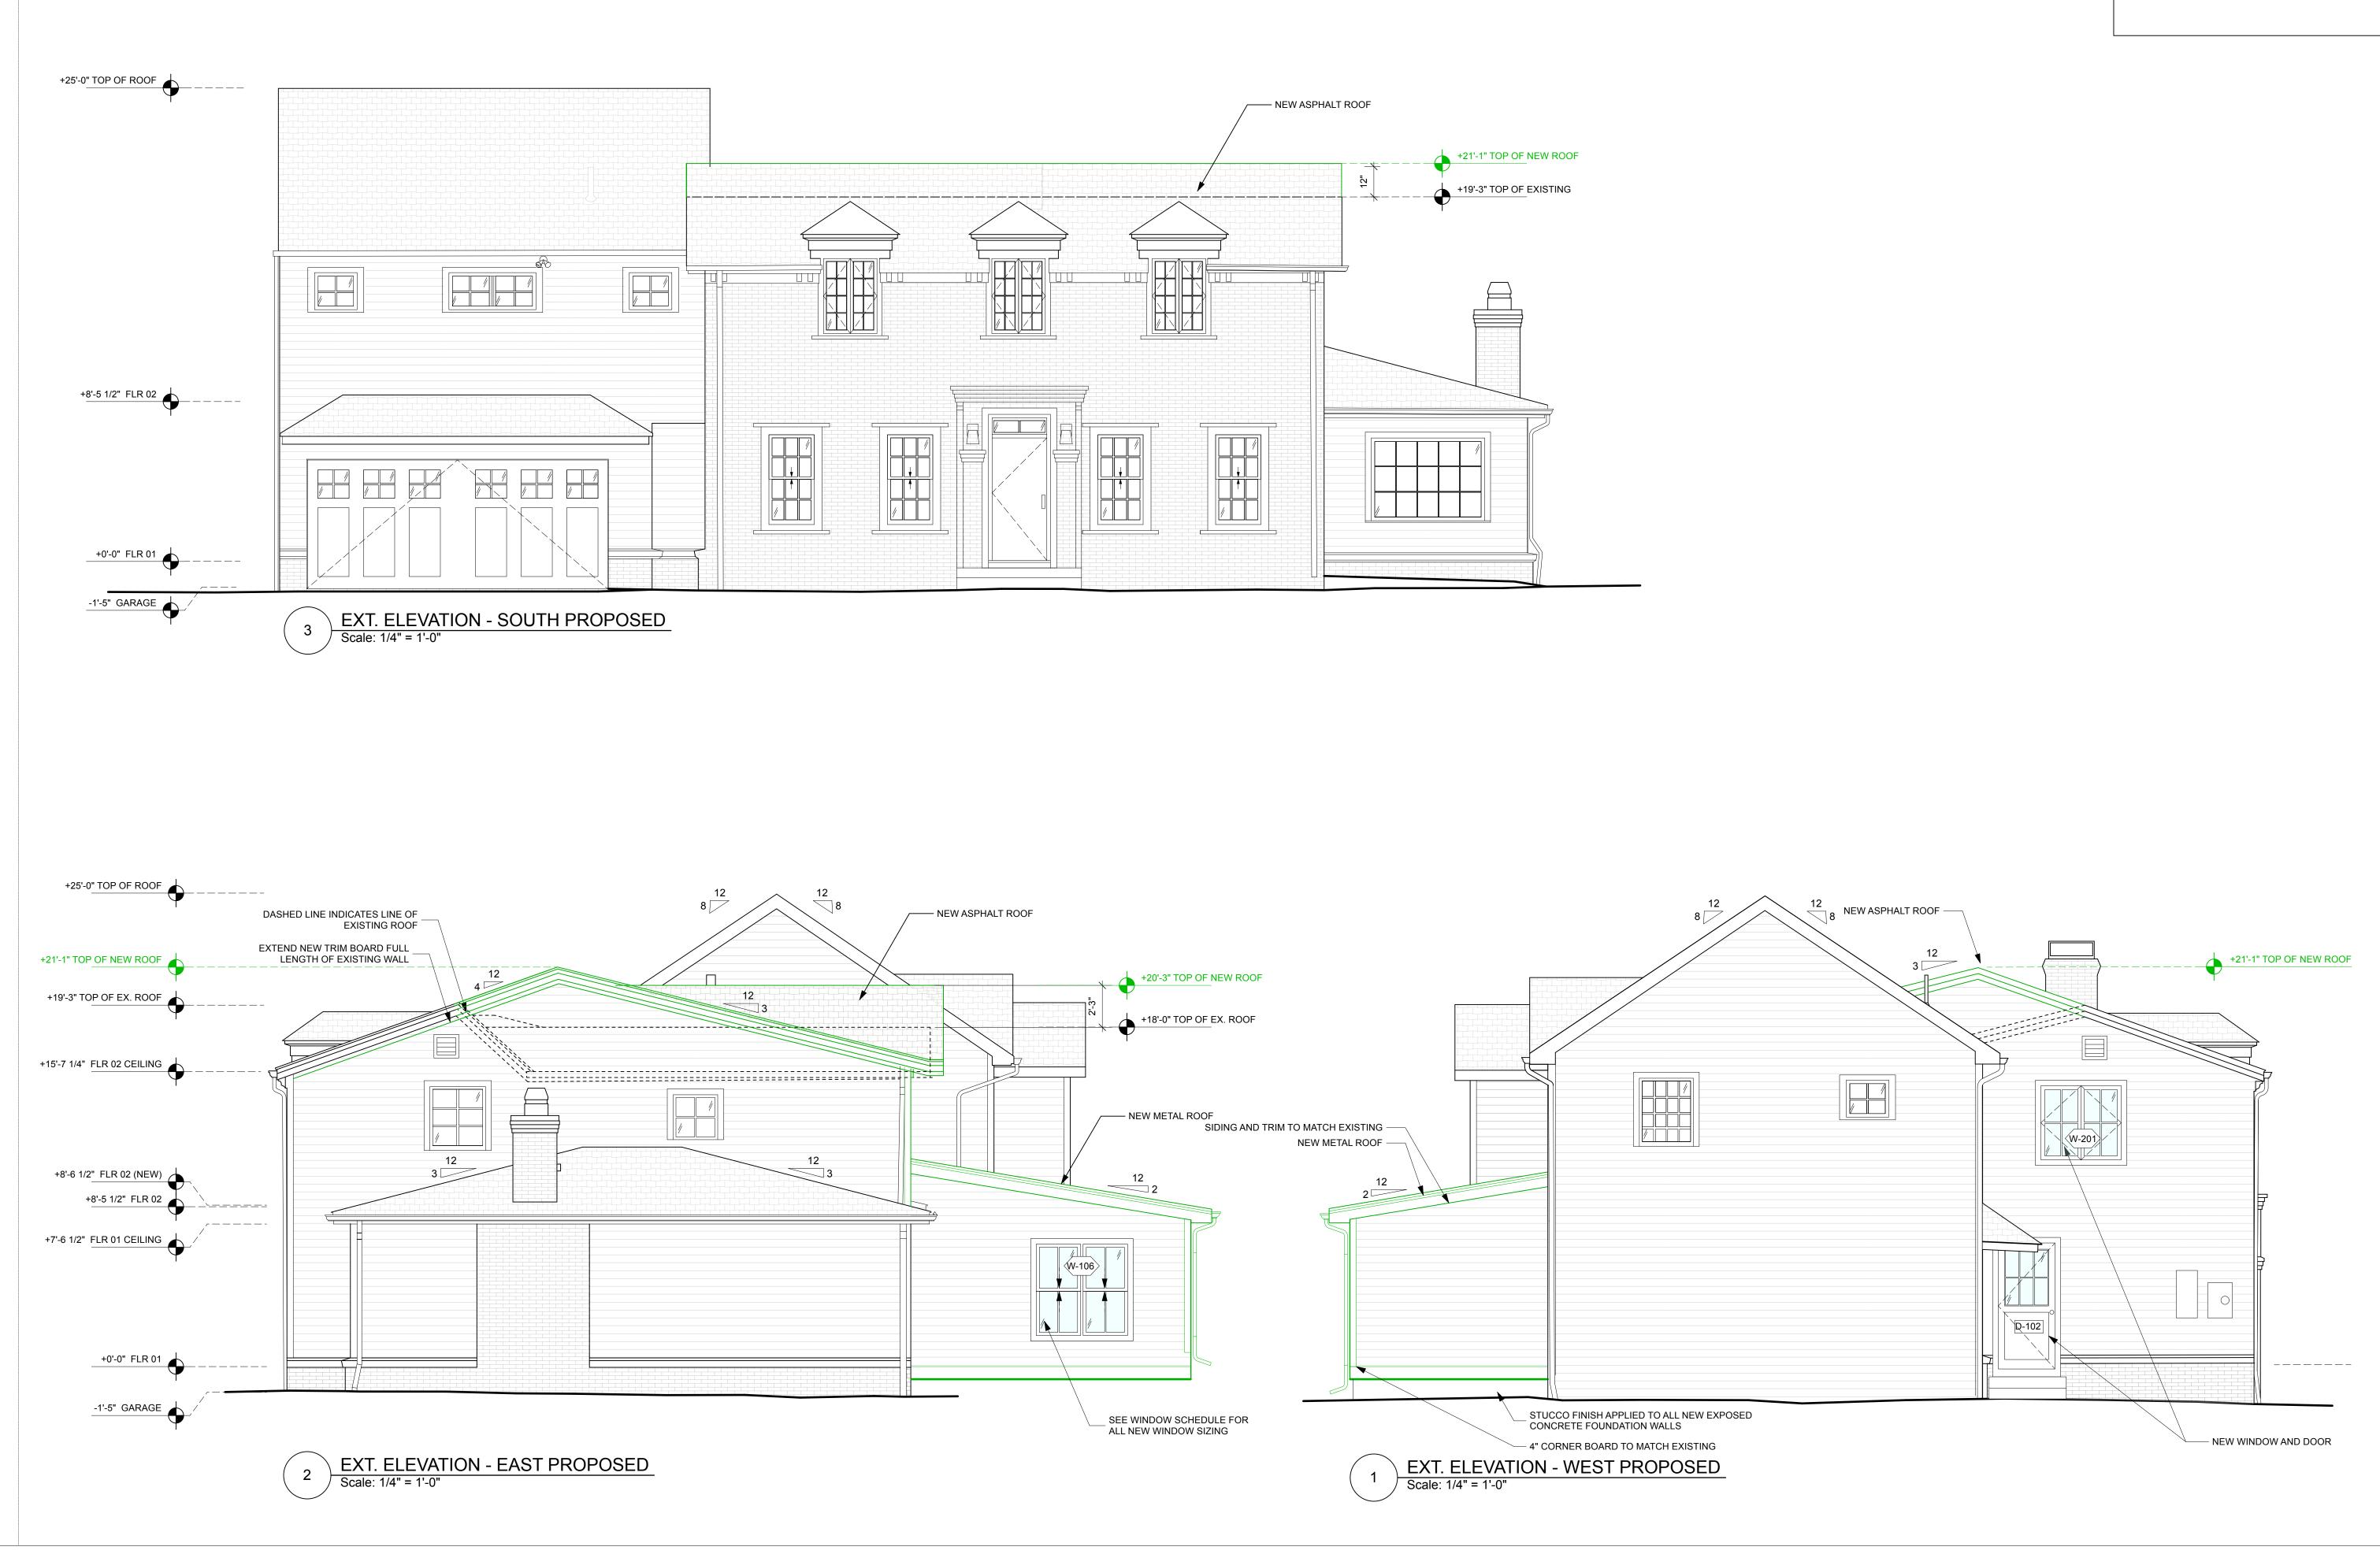


LEGEND

 NEW ADDITION


 BRICK WALL


 ASPHALT SHINGLE

 CLAPBOARD SIDING

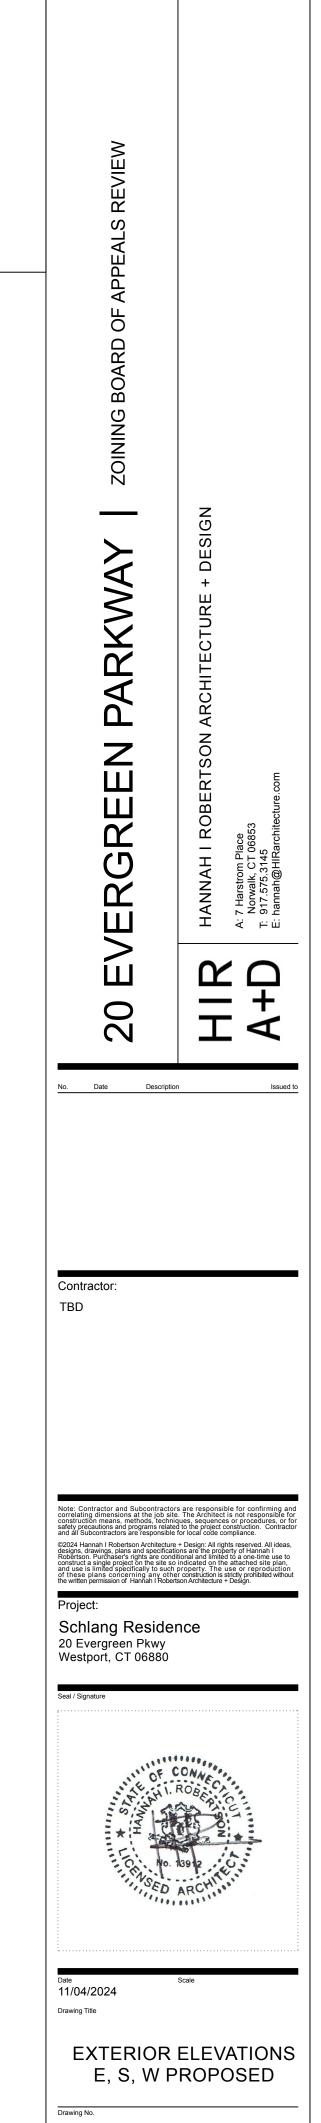

A-201

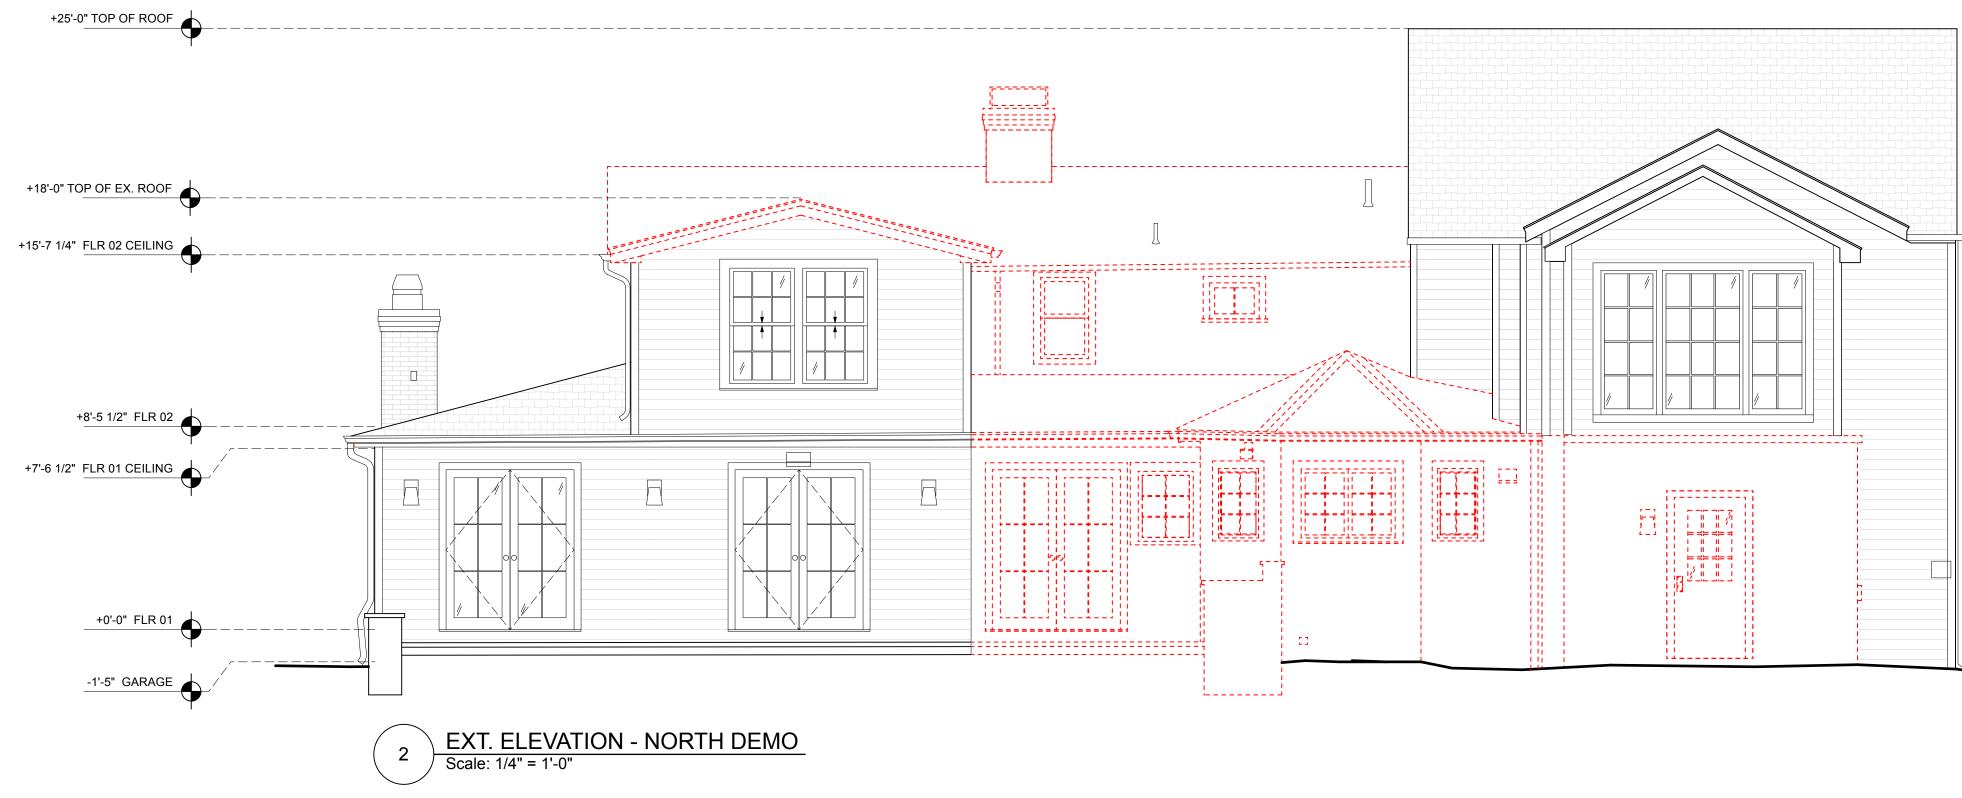

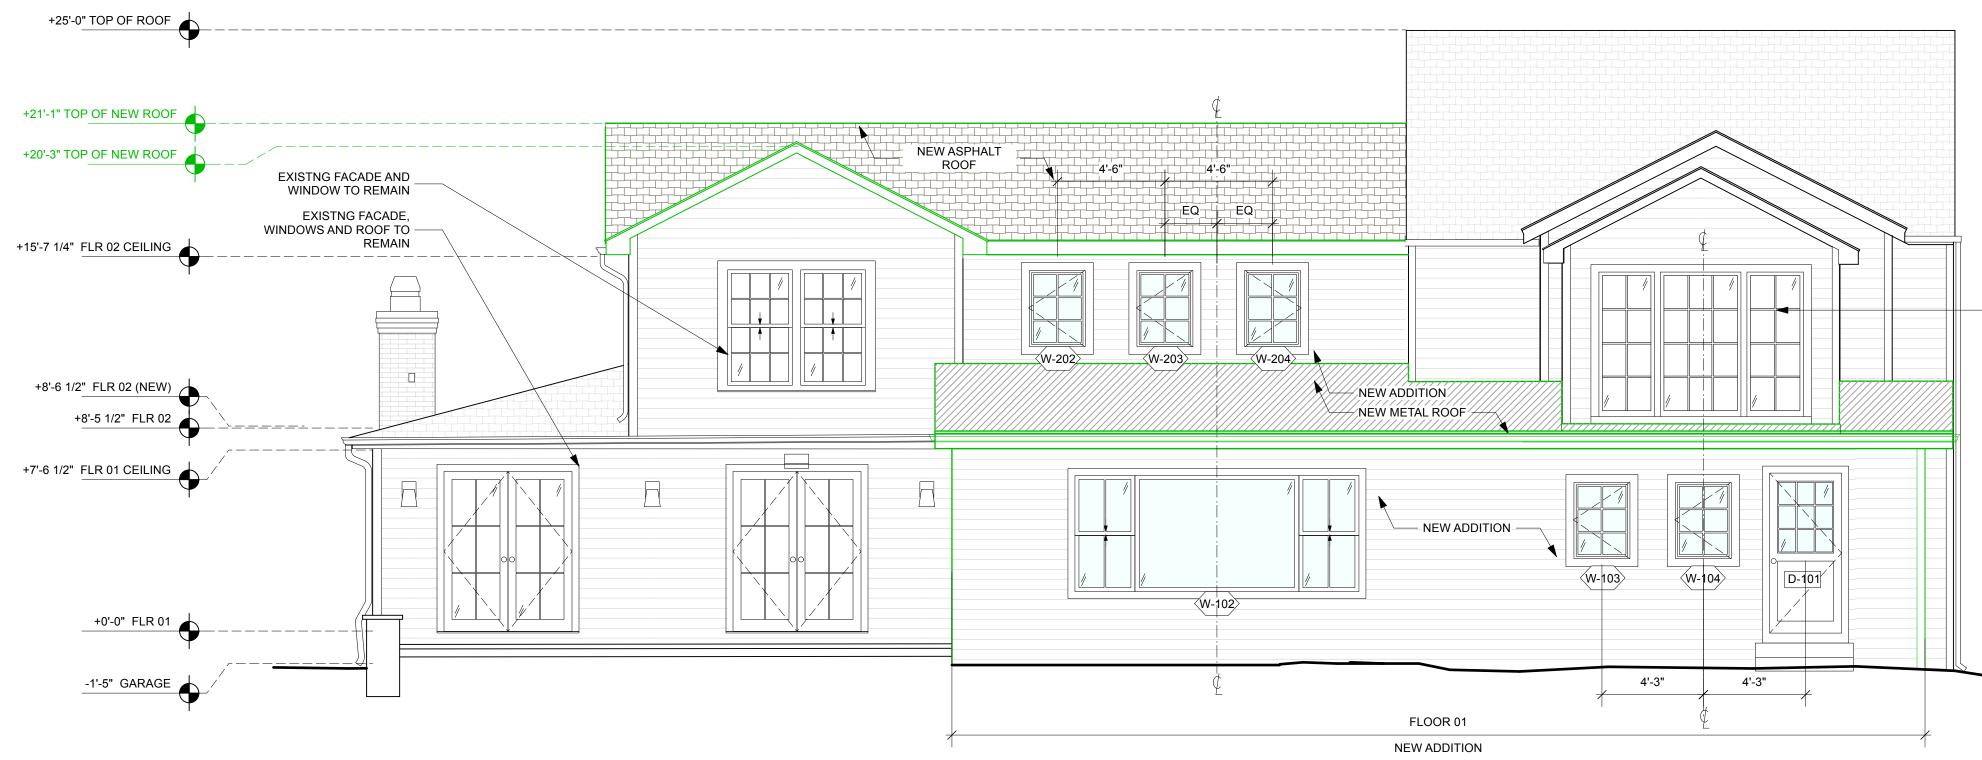

1

) EXT. ELEVATION - NORTH PROPOSED Scale: 1/4" = 1'-0"

LEGEND

DEMOLITION NEW ADDITION BRICK WALL ASPHALT SHINGLE CLAPBOARD SIDING _____

EXISTNG FACADE, — WINDOWS AND ROOF TO REMAIN

20 EVERGREEN PARKWAY HIR A+D No. Date Description Issued to Contractor: TBD Project Schlang Residence 20 Evergreen Pkwy Westport, CT 06880 11/04/2024 Drawing Title EXTERIOR ELEVATIONS NORTH Drawing No. A-202

ΕV

BOARD OF APPEALS REV

ZOINING

Z

S

ш Δ

()

ш

RO

IHH

HANNA A: 7 Harstro Norwalk, T: 917.575.5 E: hannah@

