

LEGEND TIDAL WETLAND LIMIT (STATE & FEDERAL) FEMA 100-YEAR FLOOD (CALCULATED) COASTAL JURISDICTION LINE MEAN HIGH WATER HIGH TIDE LINE ORDINARY HIGH WATER WATER HANDLING COFFERDAM (SANDBAGS) COFFERDAM ^^^^ SEDIMENTATION CONTROL SYSTEM ————————

NOTE: MEAN LOW WATER (MLW) IS AT ELEVATION -3.7, WHICH IS BELOW THE STREAMBED


GENERAL NOTES:

- 1. THESE PLANS ARE NOT FOR CONSTRUCTION AND ARE INTENDED ONLY FOR ENVIRONMENTAL PERMITTING PURPOSES. THESE PLANS HOLD AUTHORITY FOR ALL ACTIVITIES CONCERNING THE REGULATED AREA. FOR DETAILED PLANIMETRIC
- INFORMATION AND PAYMENT REFER TO THE APPLICABLE CONTRACT DOCUMENTS.

 2. FOR A DESCRIPTION OF THE WATERCOURSES, WETLANDS AND WETLAND SOILS SEE RELEVANT SECTIONS OF THE PERMIT APPLICATION.
- 3. 400 FOOT GRID BASED ON CONNECTICUT COORDINATE SYSTEM N.A.D. 1983, VERTICAL DATUM BASED ON NAVD OF 1988.
- 4. ALL CONSTRUCTION ACTIVITIES WILL BE CONDUCTED IN ACCORDANCE WIH THE DEPARTMENT'S STANDARD SPECIFICATIONS FOR ROADS, BRIDGES, FACILITIES AND INCIDENTAL CONSTRUCTION, FORM 818, SECTION 1.10 AND WILL ALSO FOLLOW REQUIRED BEST MANAGEMENT PRACTICES (BMPs) AND SEDIMENT AND EROSION CONTROL MEASURES IN ACCORDANCE WITH THE 2002 EROSION & SEDIMENTATION CONTROL GUIDELINES AND THE 2004 STORMWATER QUALITY MANUAL.


ENVIRONMENTAL PERMIT PLANS STATE PROJECT NO. 0158-0219 REPLACEMENT OF BRIDGE NO. 04972 - GREENS FARMS ROAD OVER SASCO BROOK

Town of WESTPORT

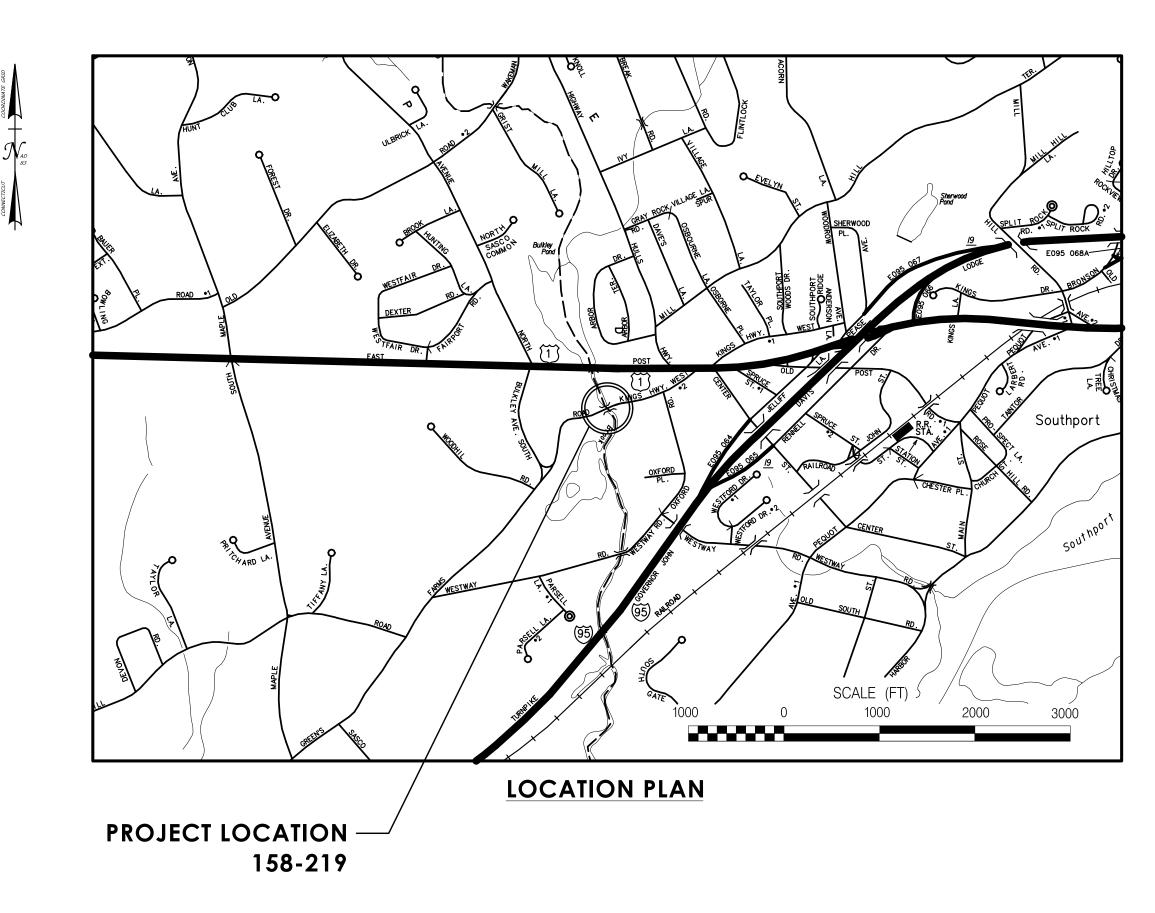

LIST OF DRAWINGS		
DRAWING NOS.	DRAWING TITLE	
PMT-01	TITLE SHEET	
PMT-02	GENERAL SITE PLAN	
PMT-03	WETLAND/WATERCOURSE IMPACT PLAN	
PMT-04	100-YR FLOOD IMPACT PLAN	
PMT-05	BRIDGE ELEVATION AND MISCELLANEOUS DETAILS	
PMT-06	MISCELLANEOUS DETAILS	
PMT-07	WATER HANDLING PLAN - PHASE 1	
PMT-08	WATER HANDLING PLAN - PHASE 2	

DRAWING TITLE: TITLE SHEET

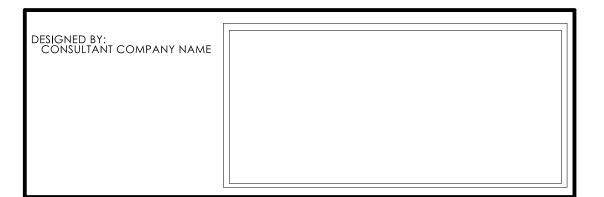

PLAN DATE: MAY 18, 2023

BLOCK:


Alfred Benesch
& Company


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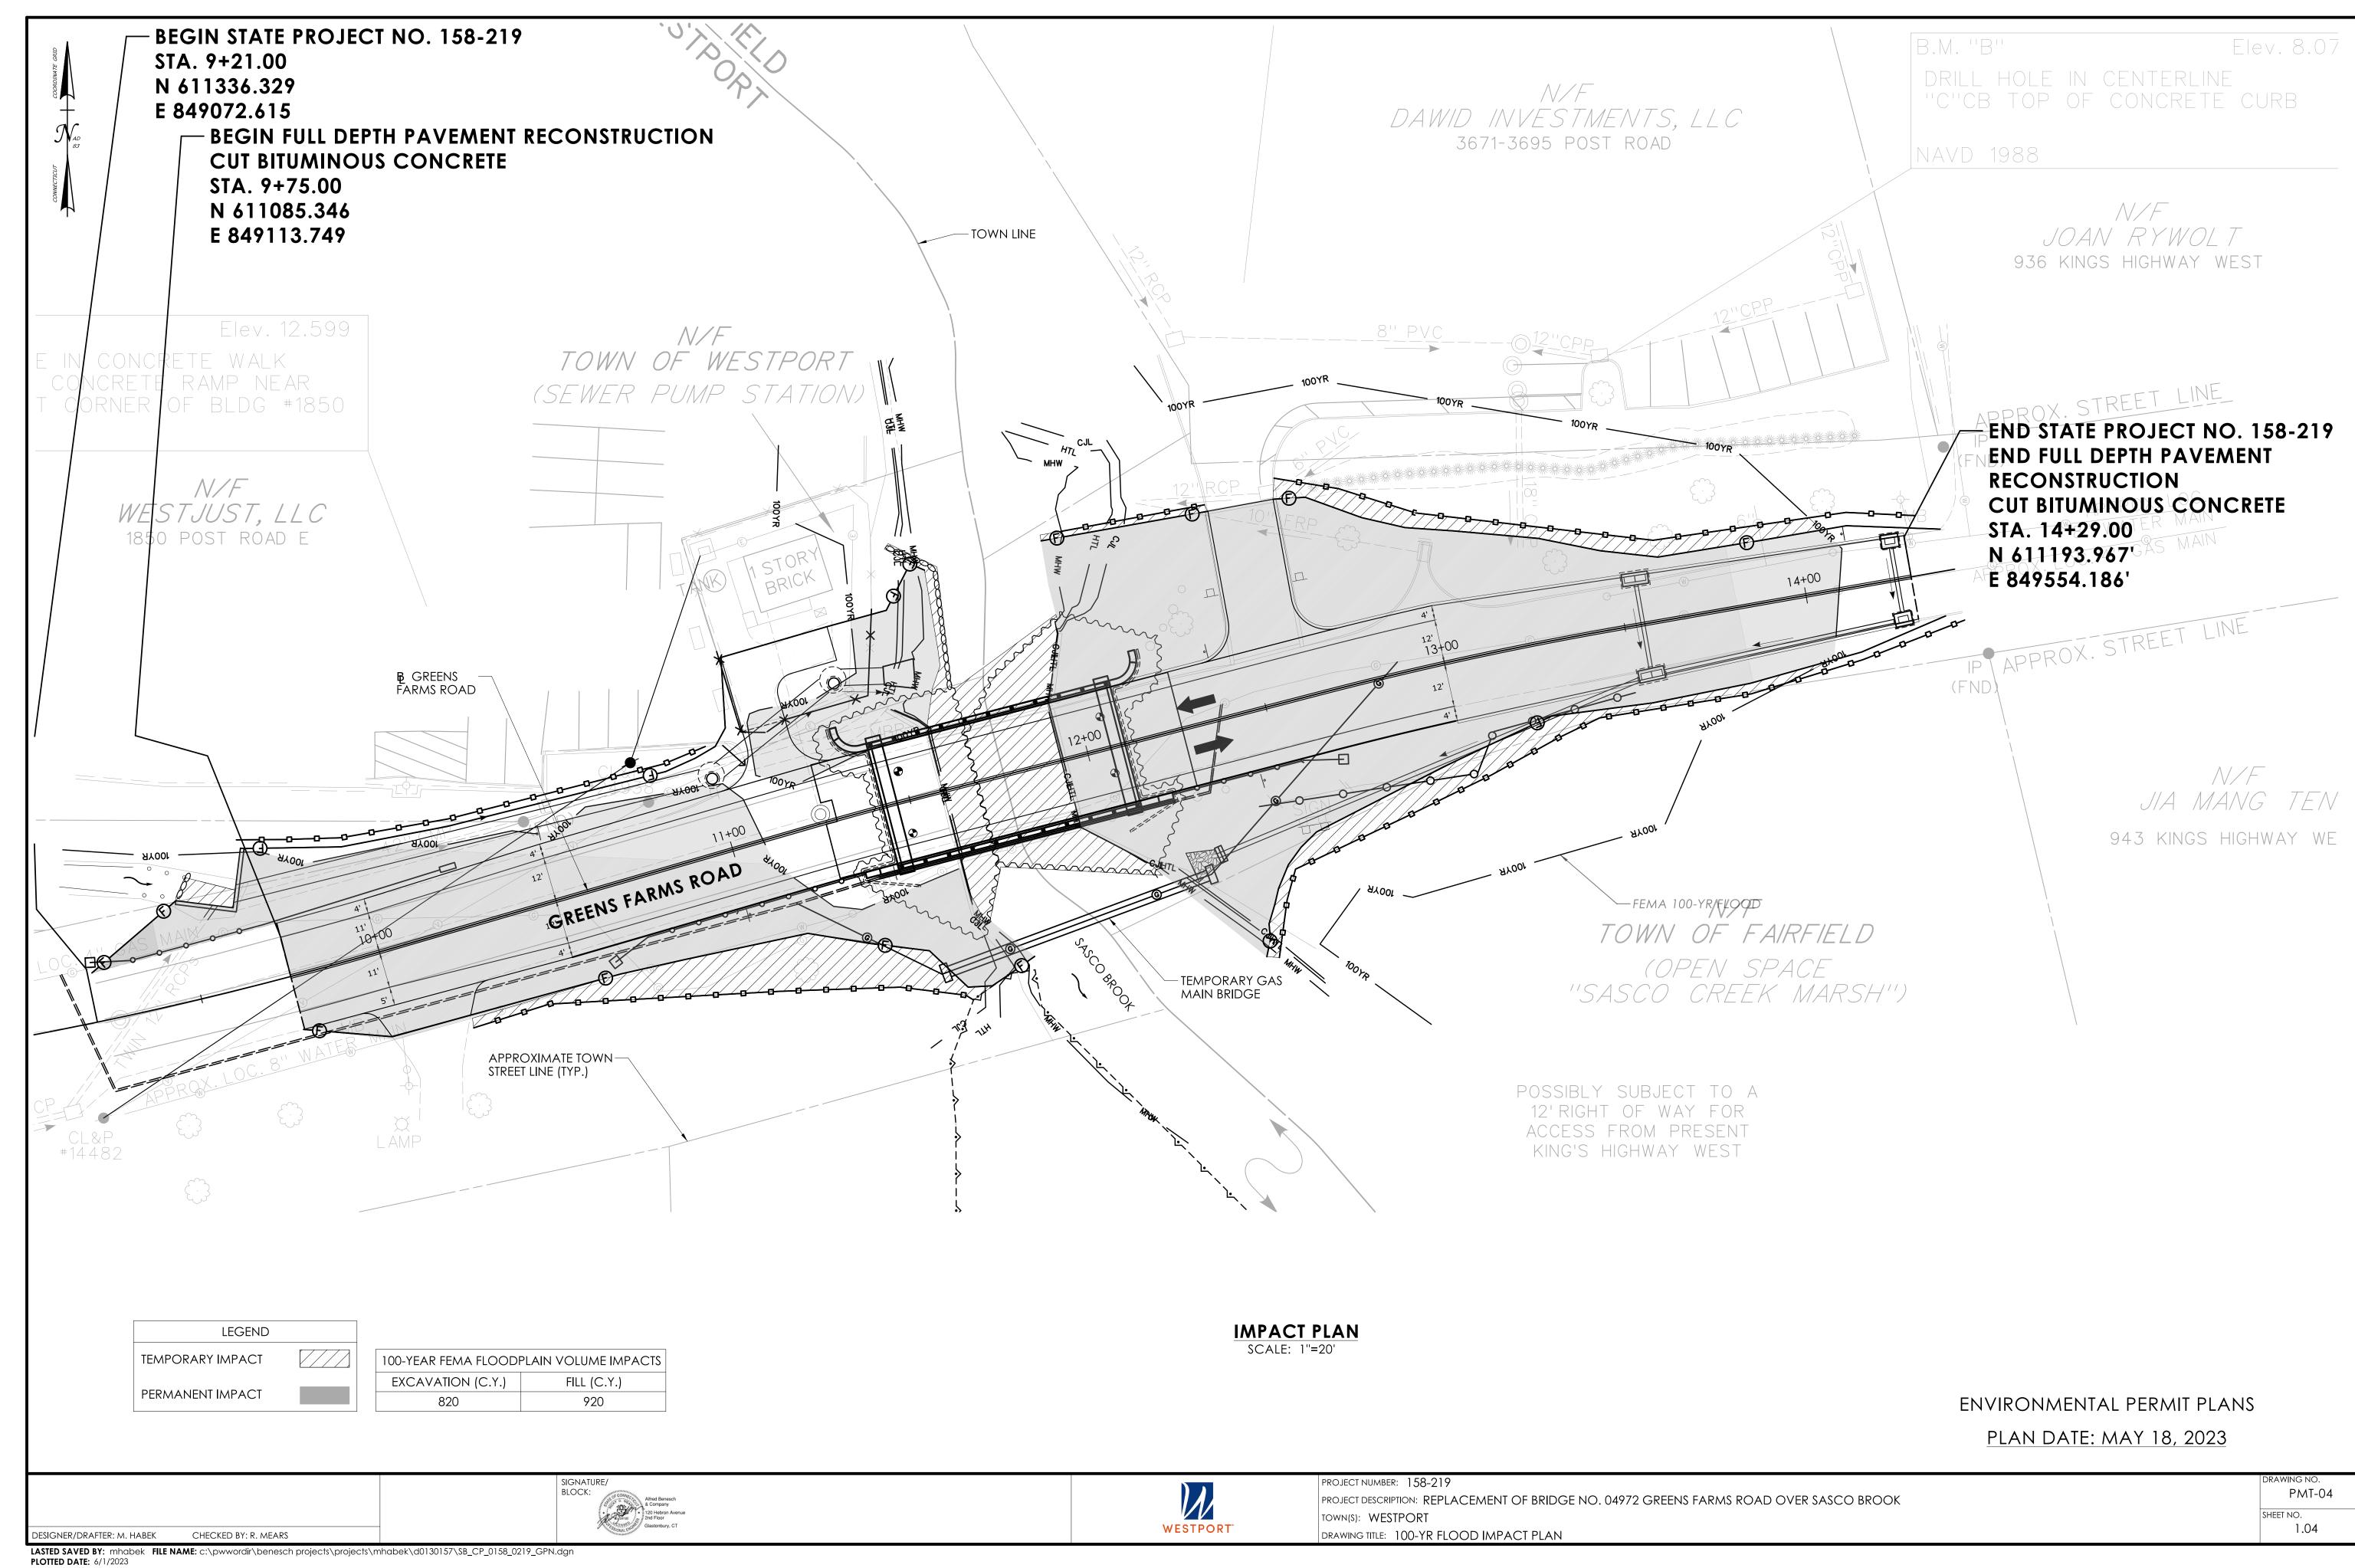



CHECKED BY: R. MEARS


DESIGNER/DRAFTER: M. HABEK




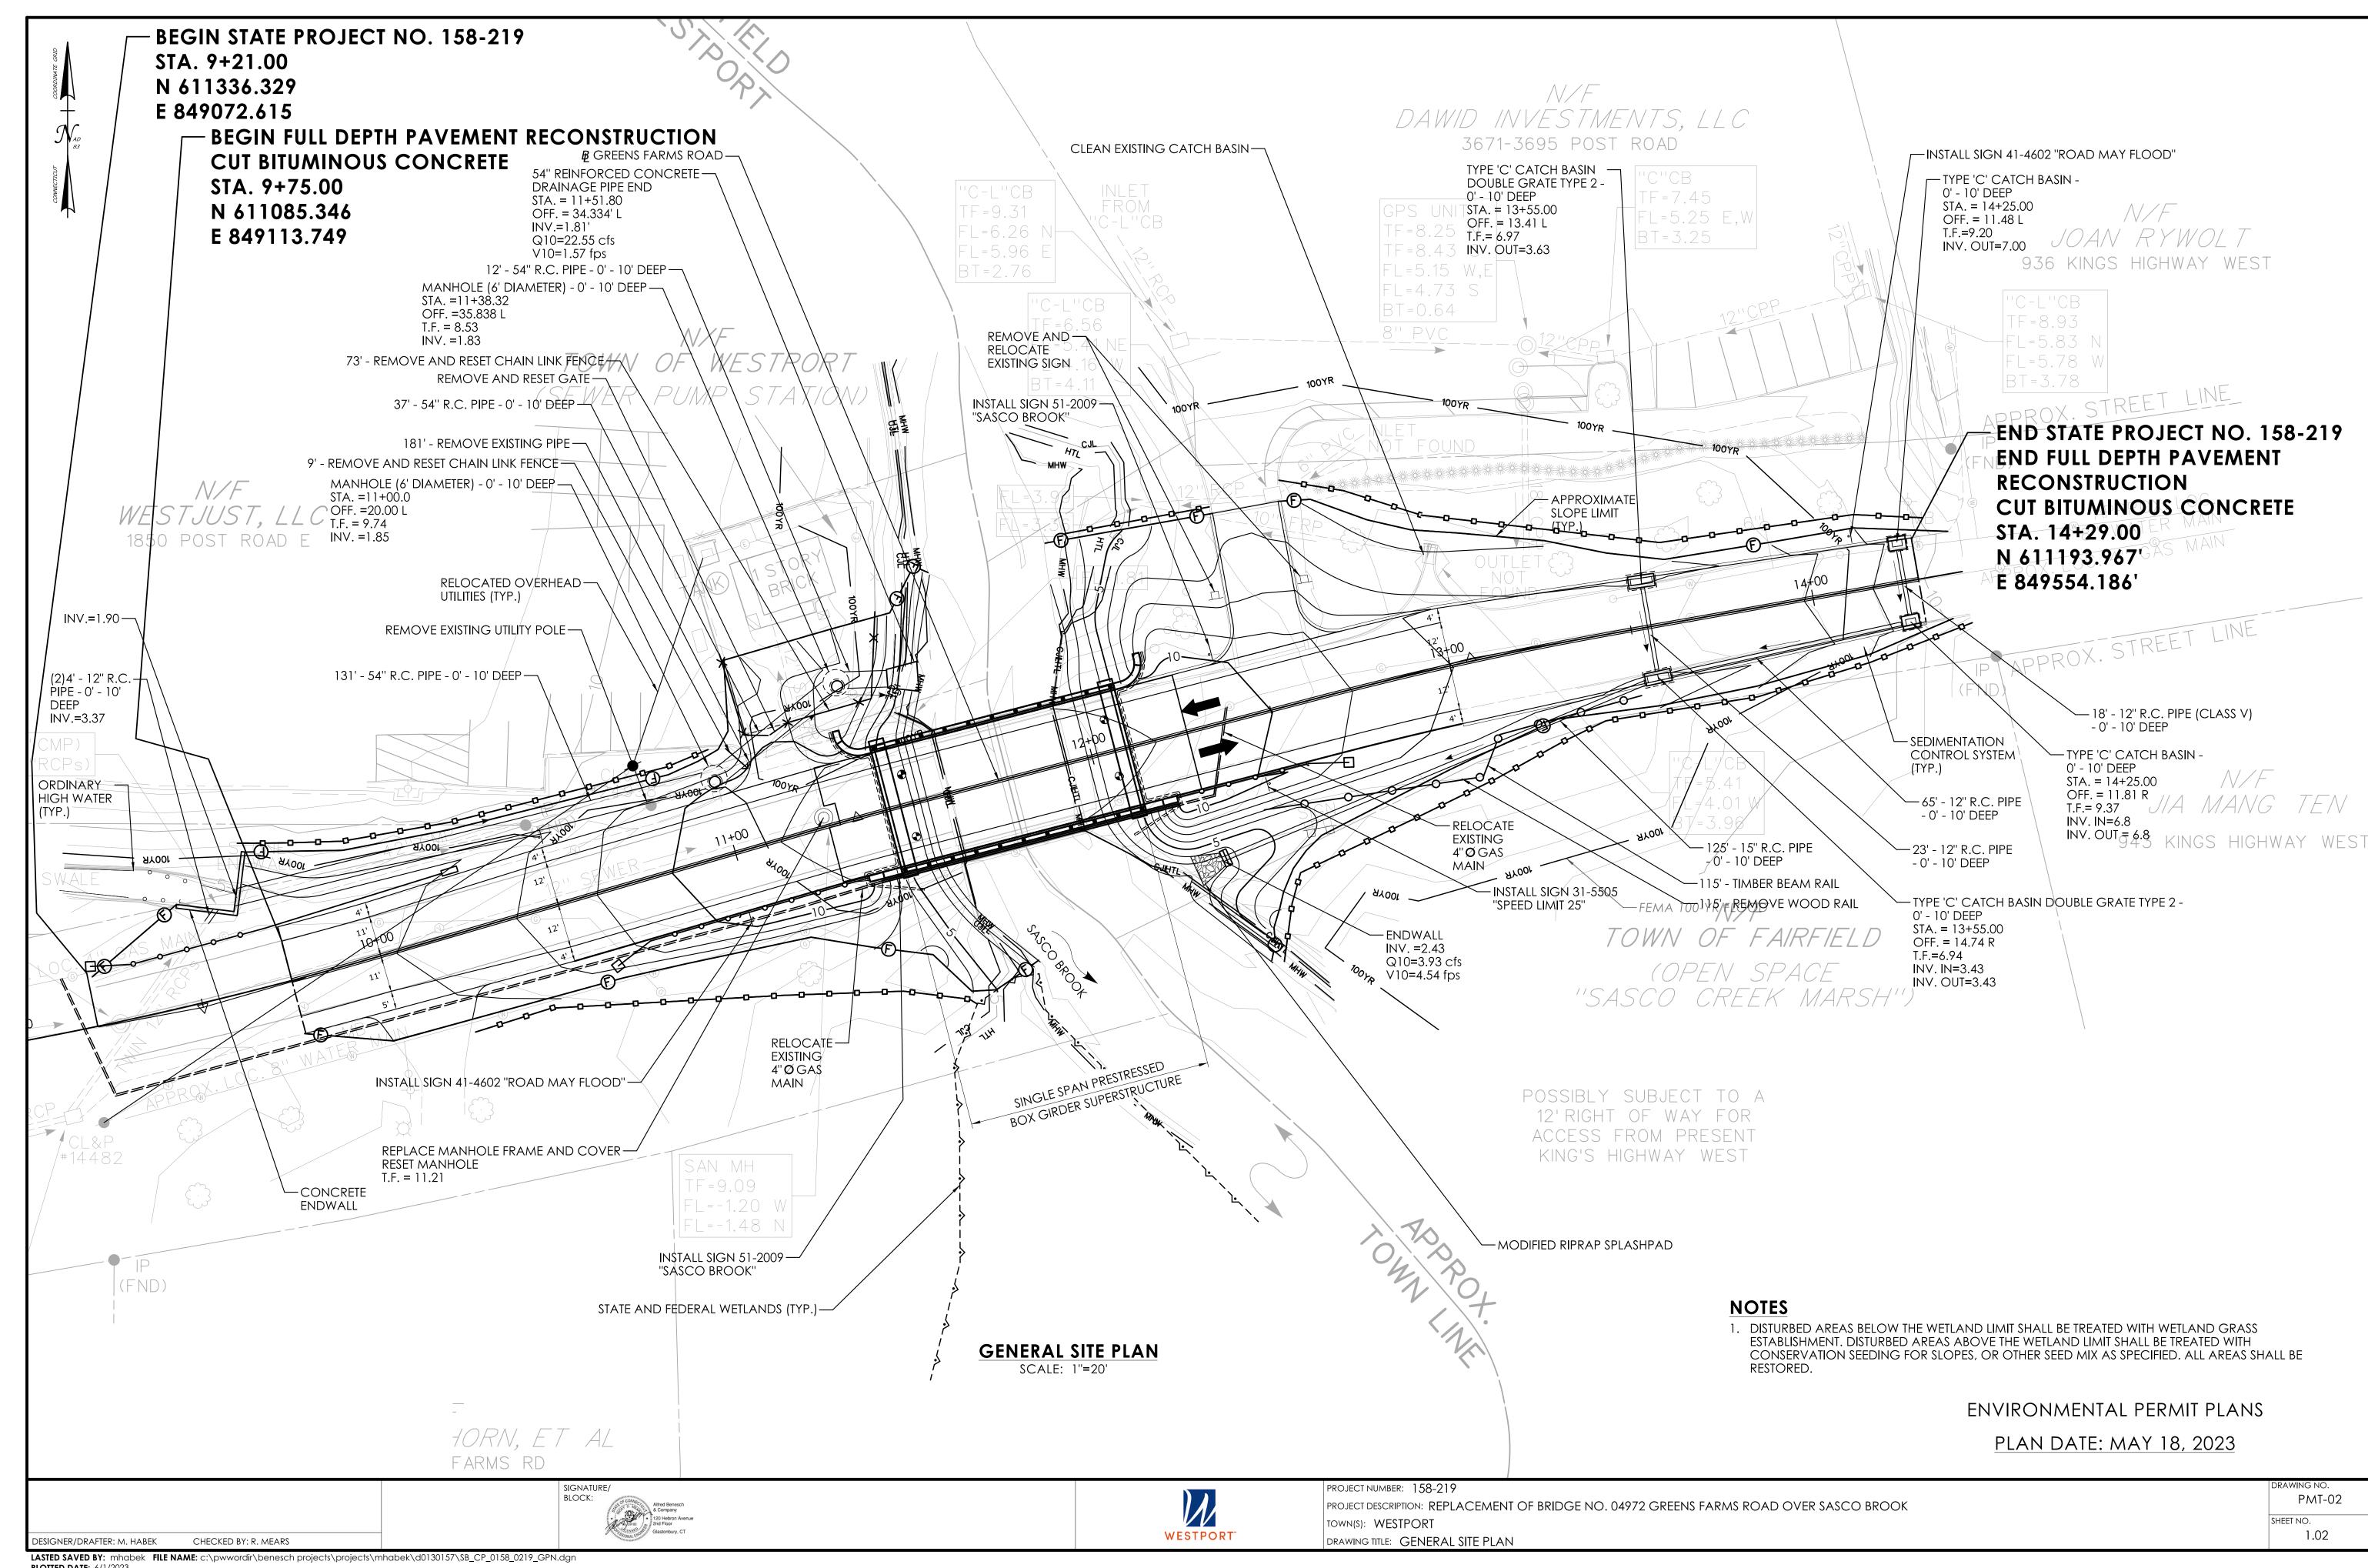


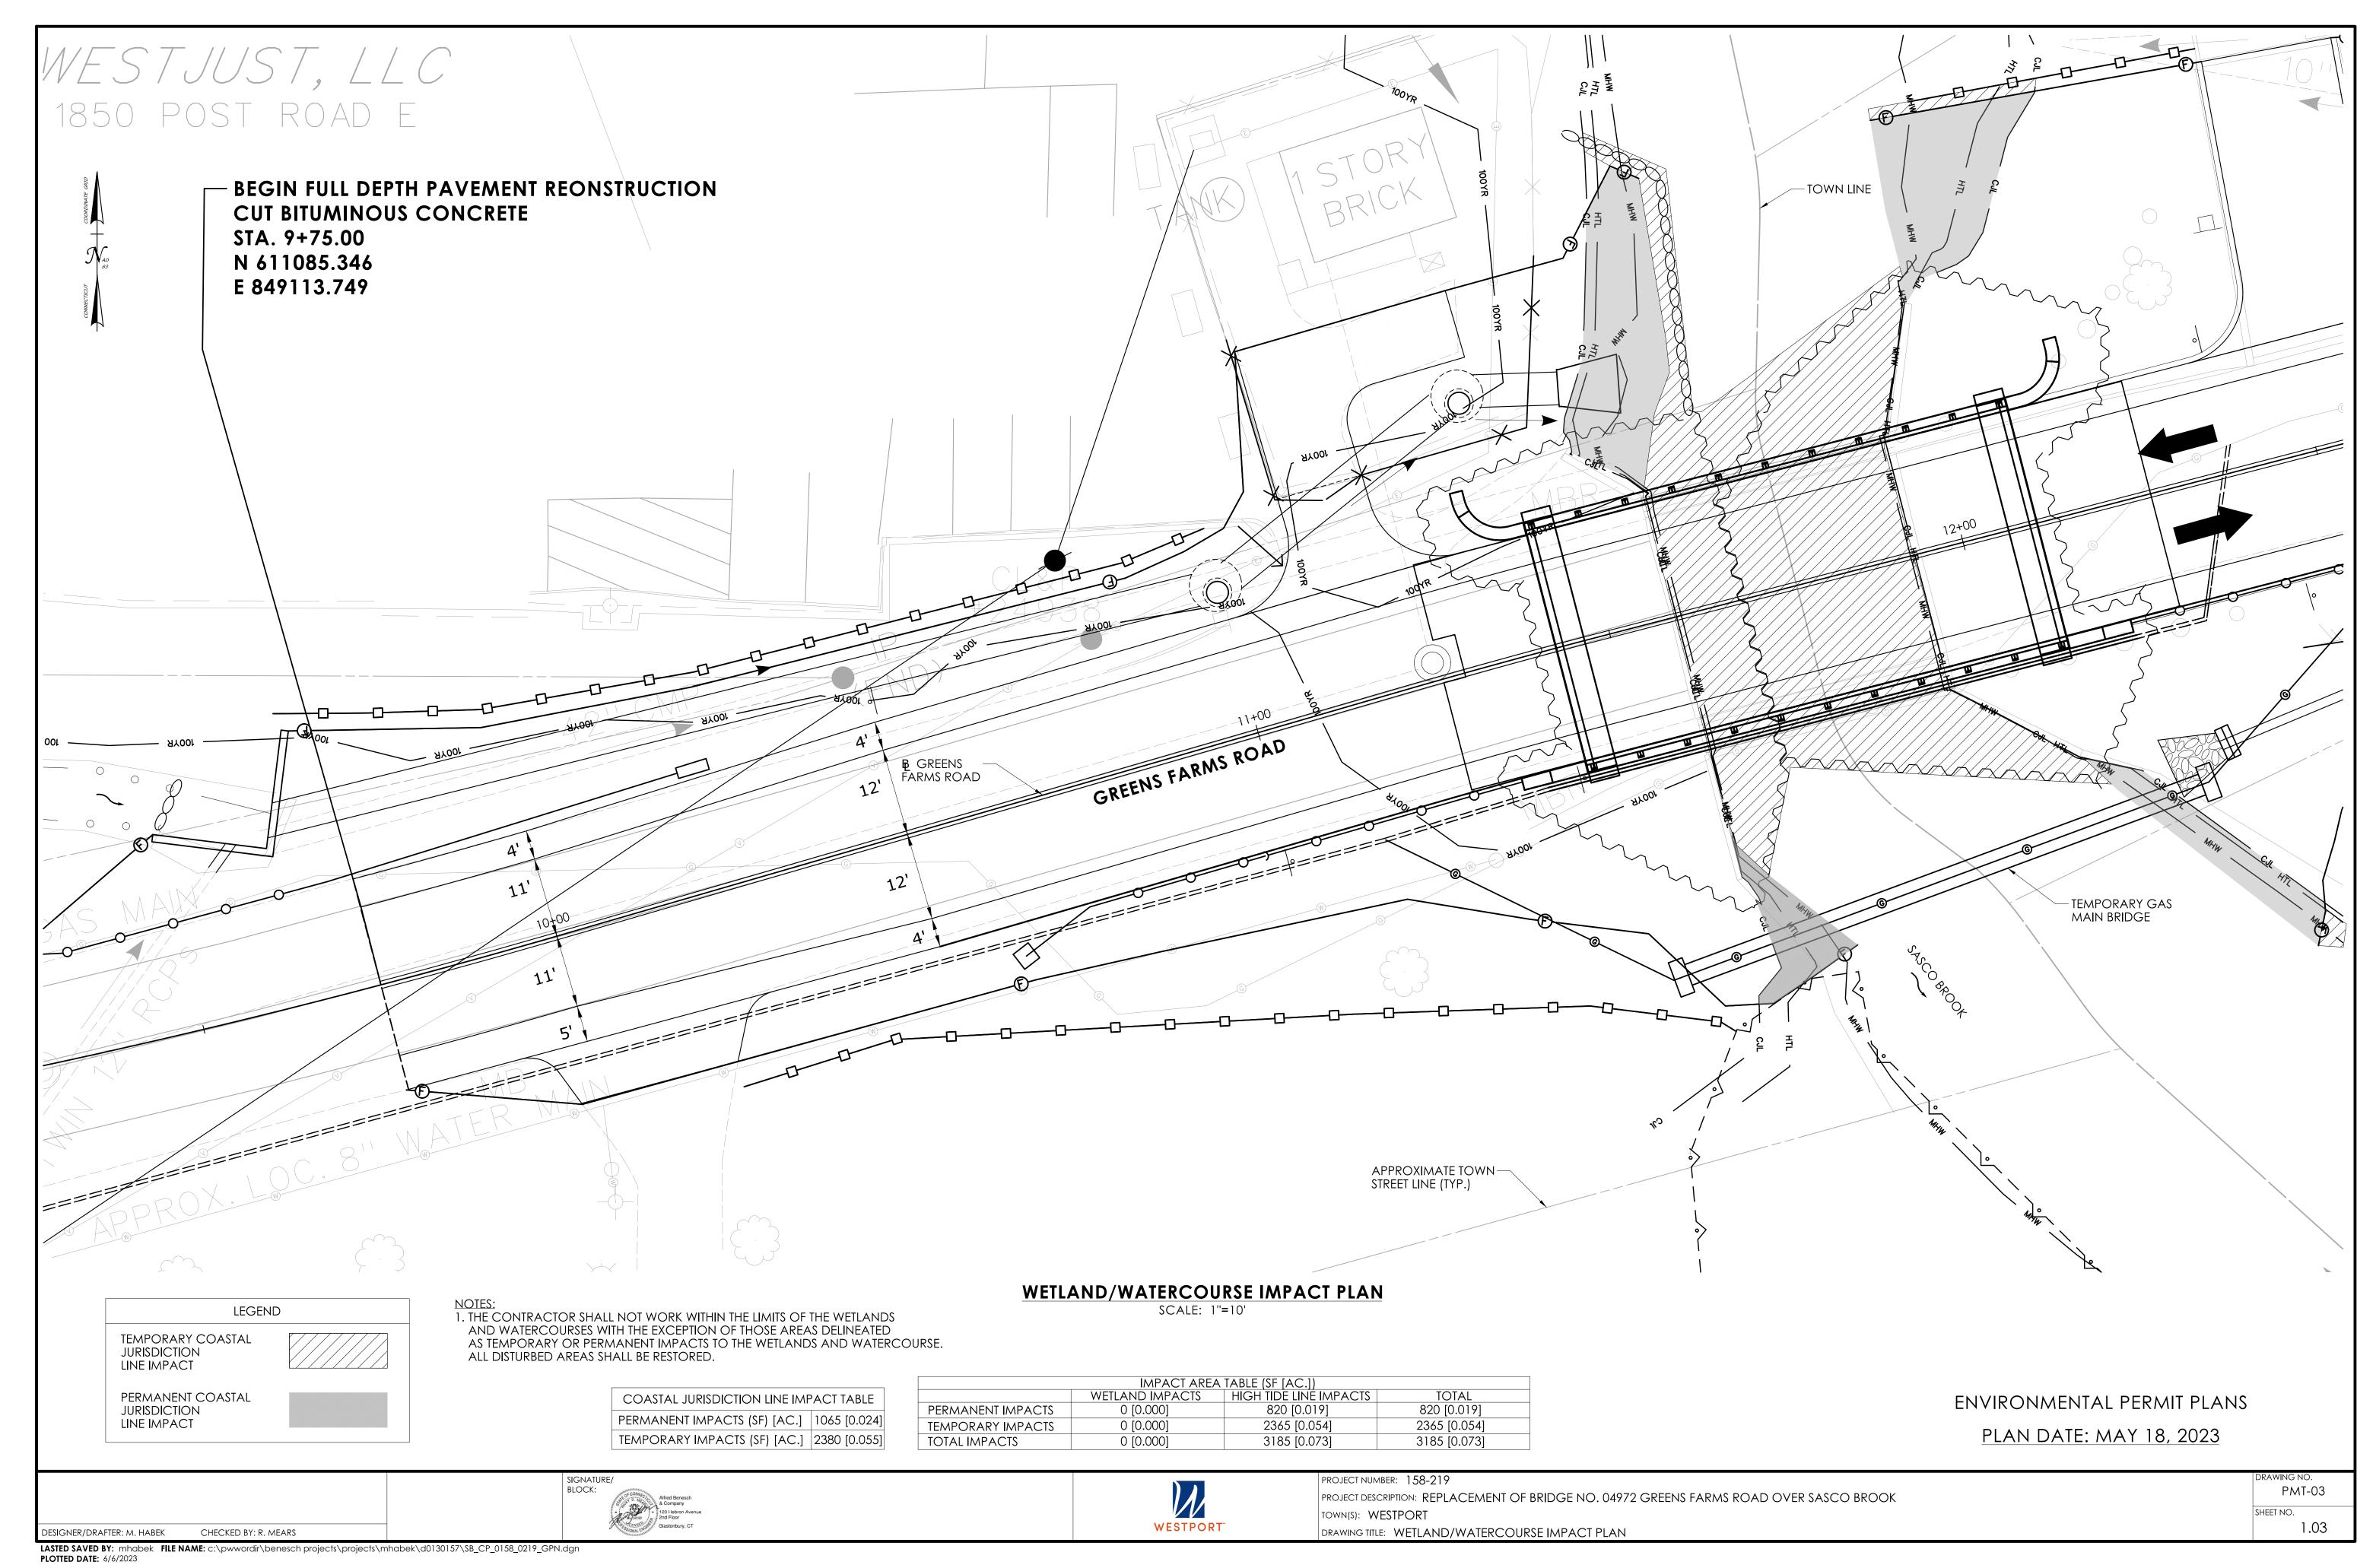

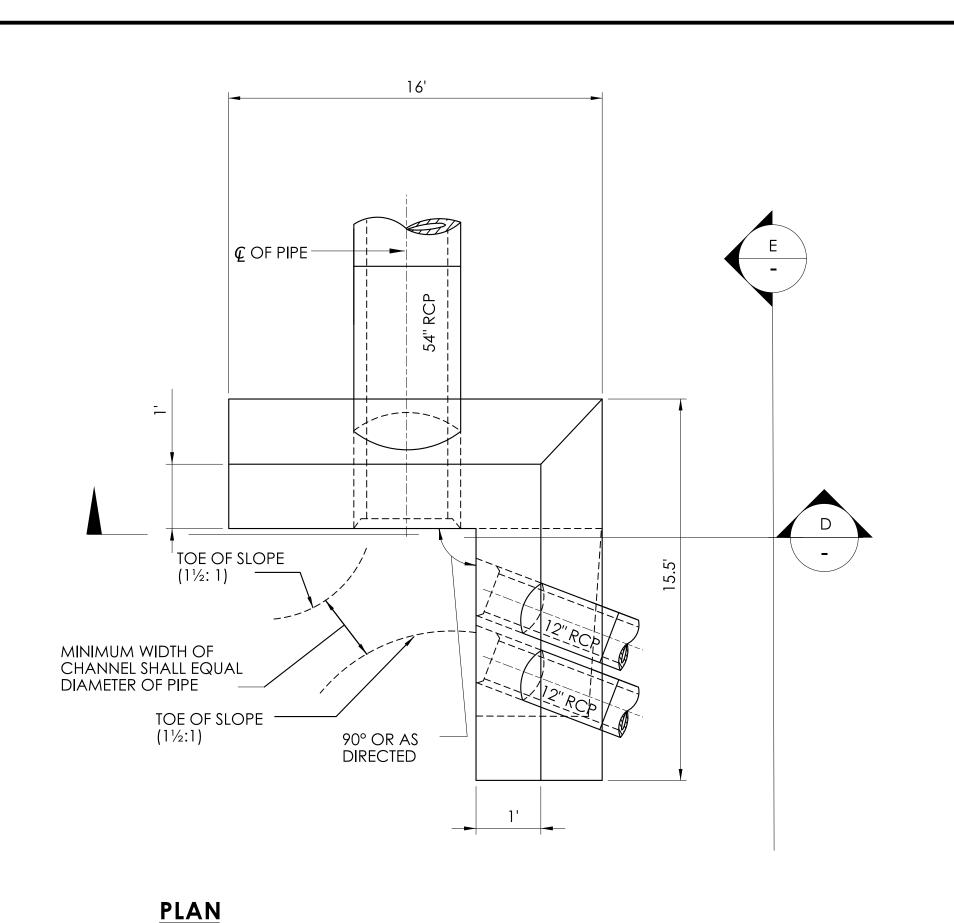

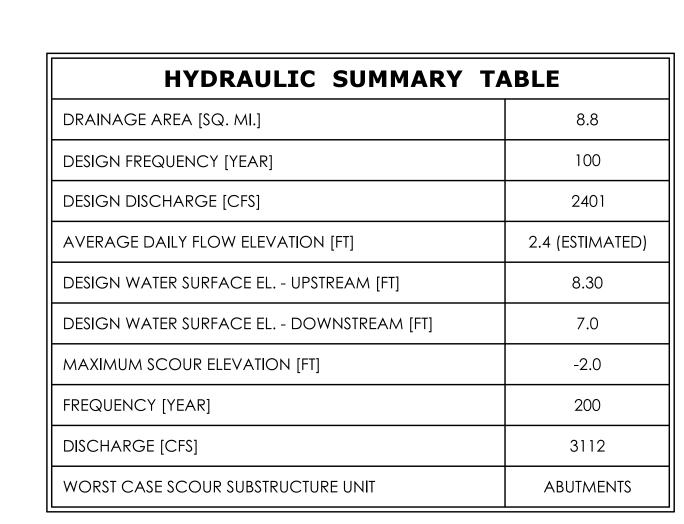


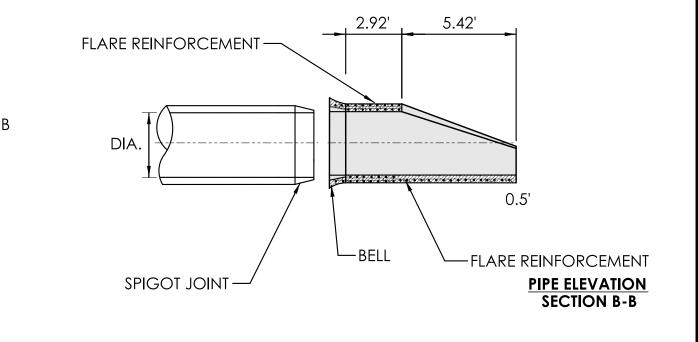

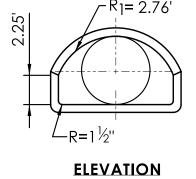


REINFORCED CONCRETE DRAINAGE PIPE END DETAIL FOR 54" R.C. PIPE

NOT TO SCALE

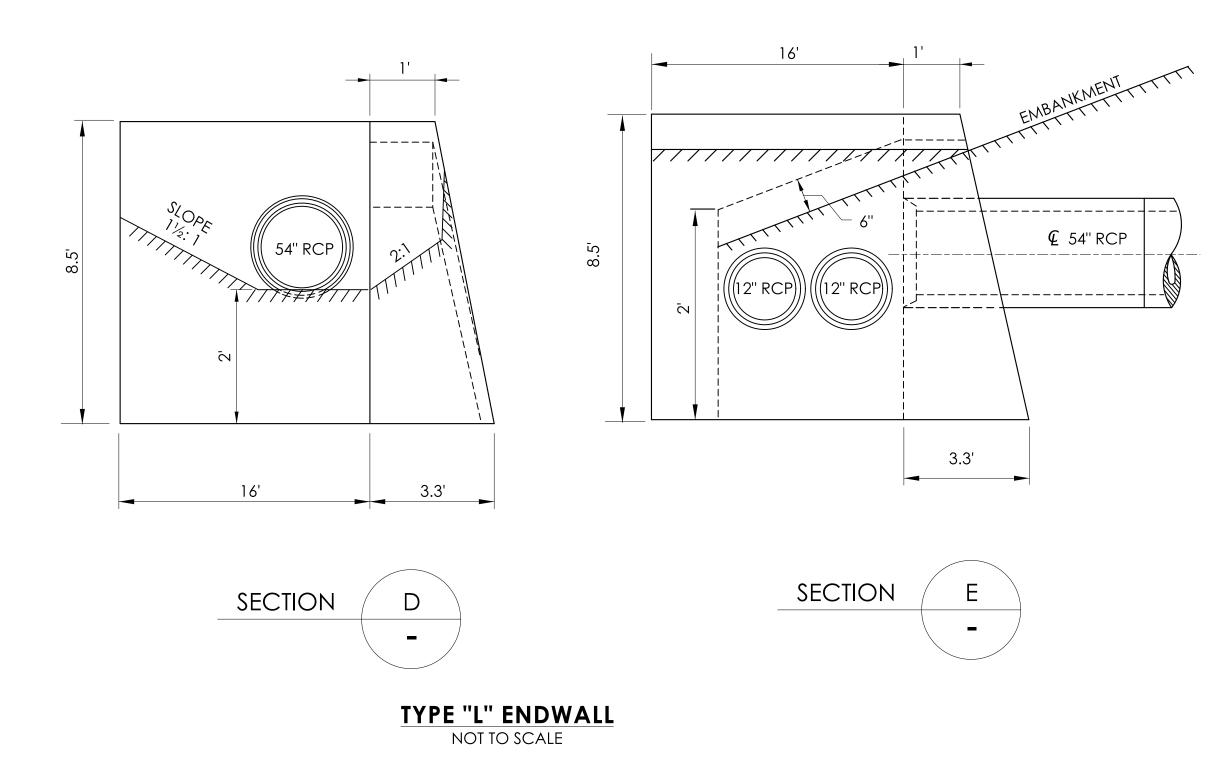

SIGNATURE/ BLOCK:

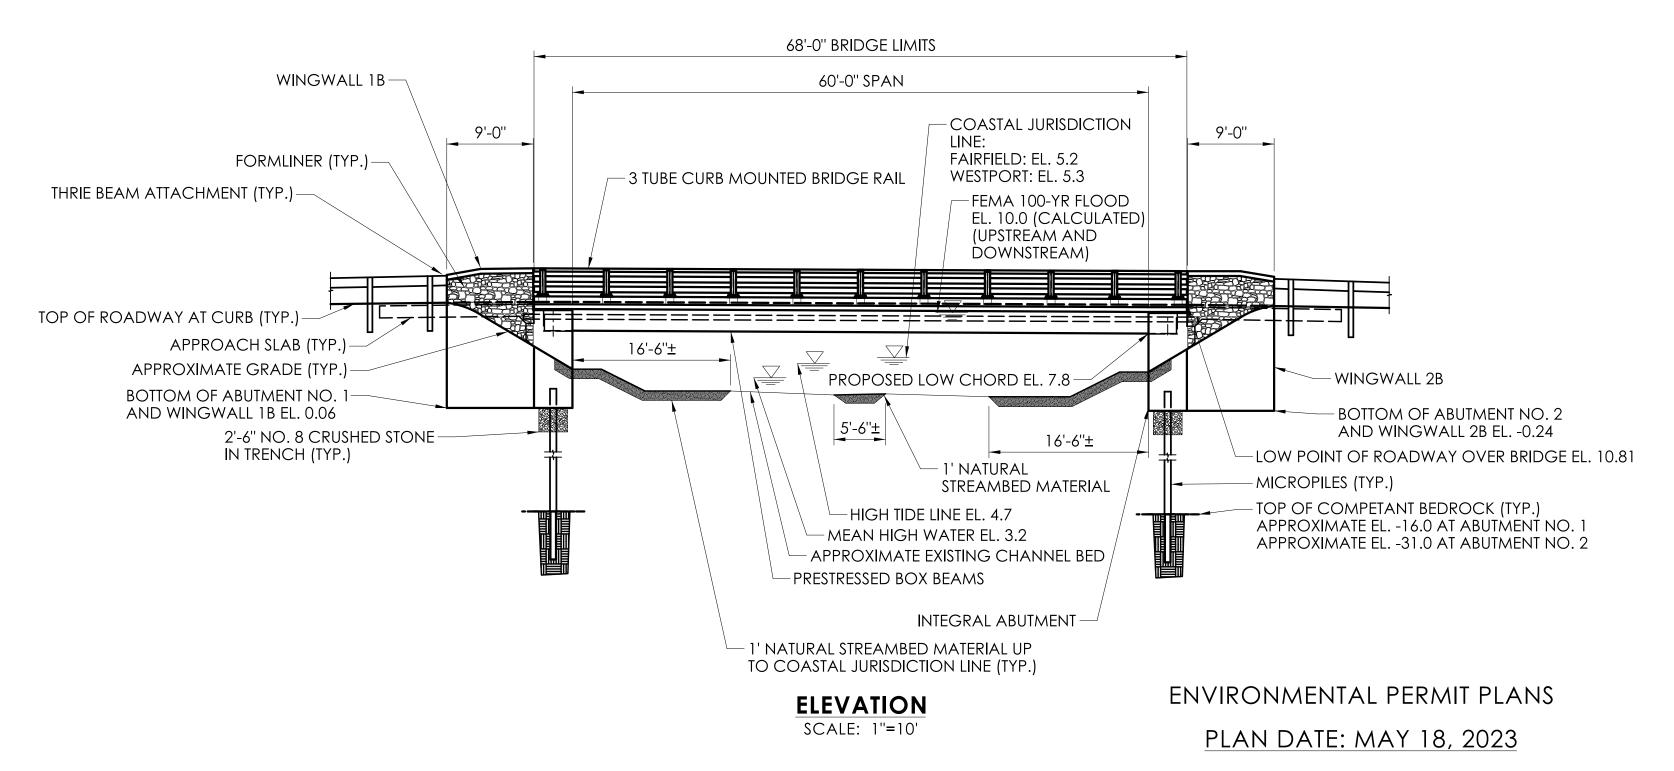

WESTPORT"

PROJECT NUMBER: 158-219
PROJECT DESCRIPTION: REPLACEMENT OF BRIDGE NO. 04972 GREENS FARMS ROAD OVER SASCO BROOK TOWN(S): WESTPORT
DRAWING TITLE: BRIDGE ELEVATION AND MISCELLANEOUS DETAILS

JOINT SEALER —


PIPE OUTLET PLAN VIEW

12'

DRAWING NO.
PMT-05
SHEET NO.
1.05


CHECKED BY: R. MEARS

DESIGNER/DRAFTER: M. HABEK

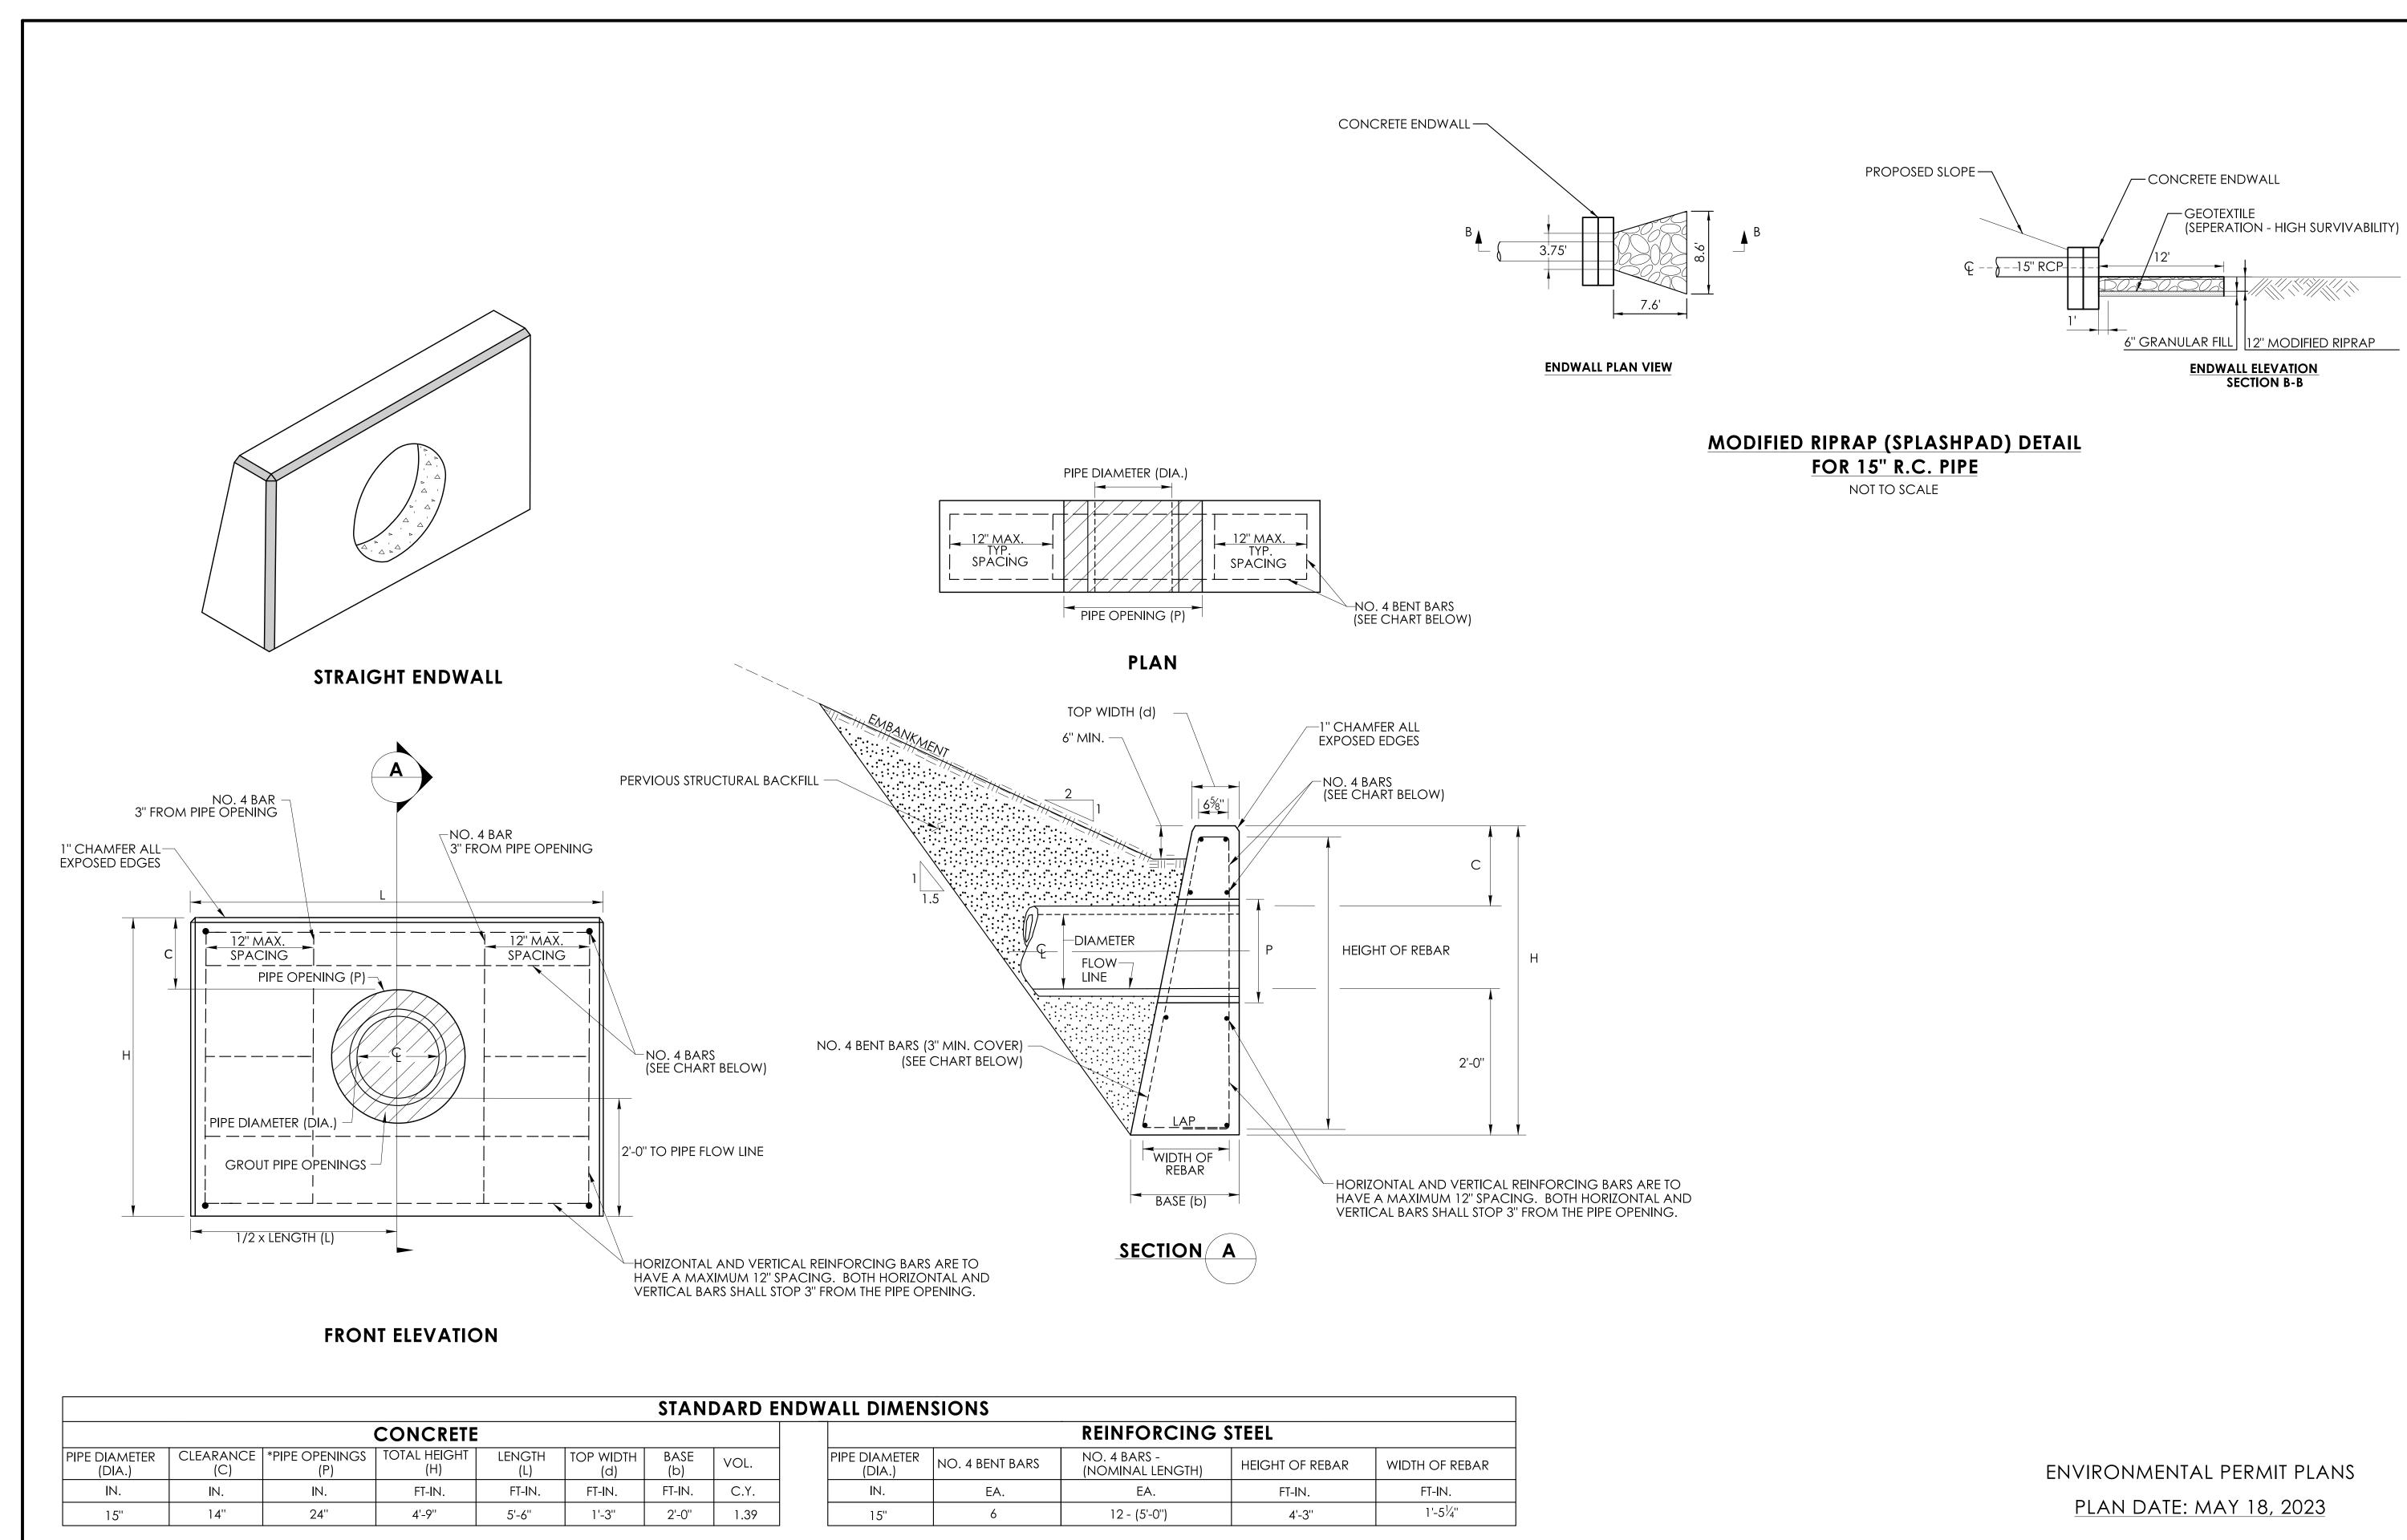

SIGNATURE/
BLOCK:
BLOCK

DESIGNER/DRAFTER: M. HABEK

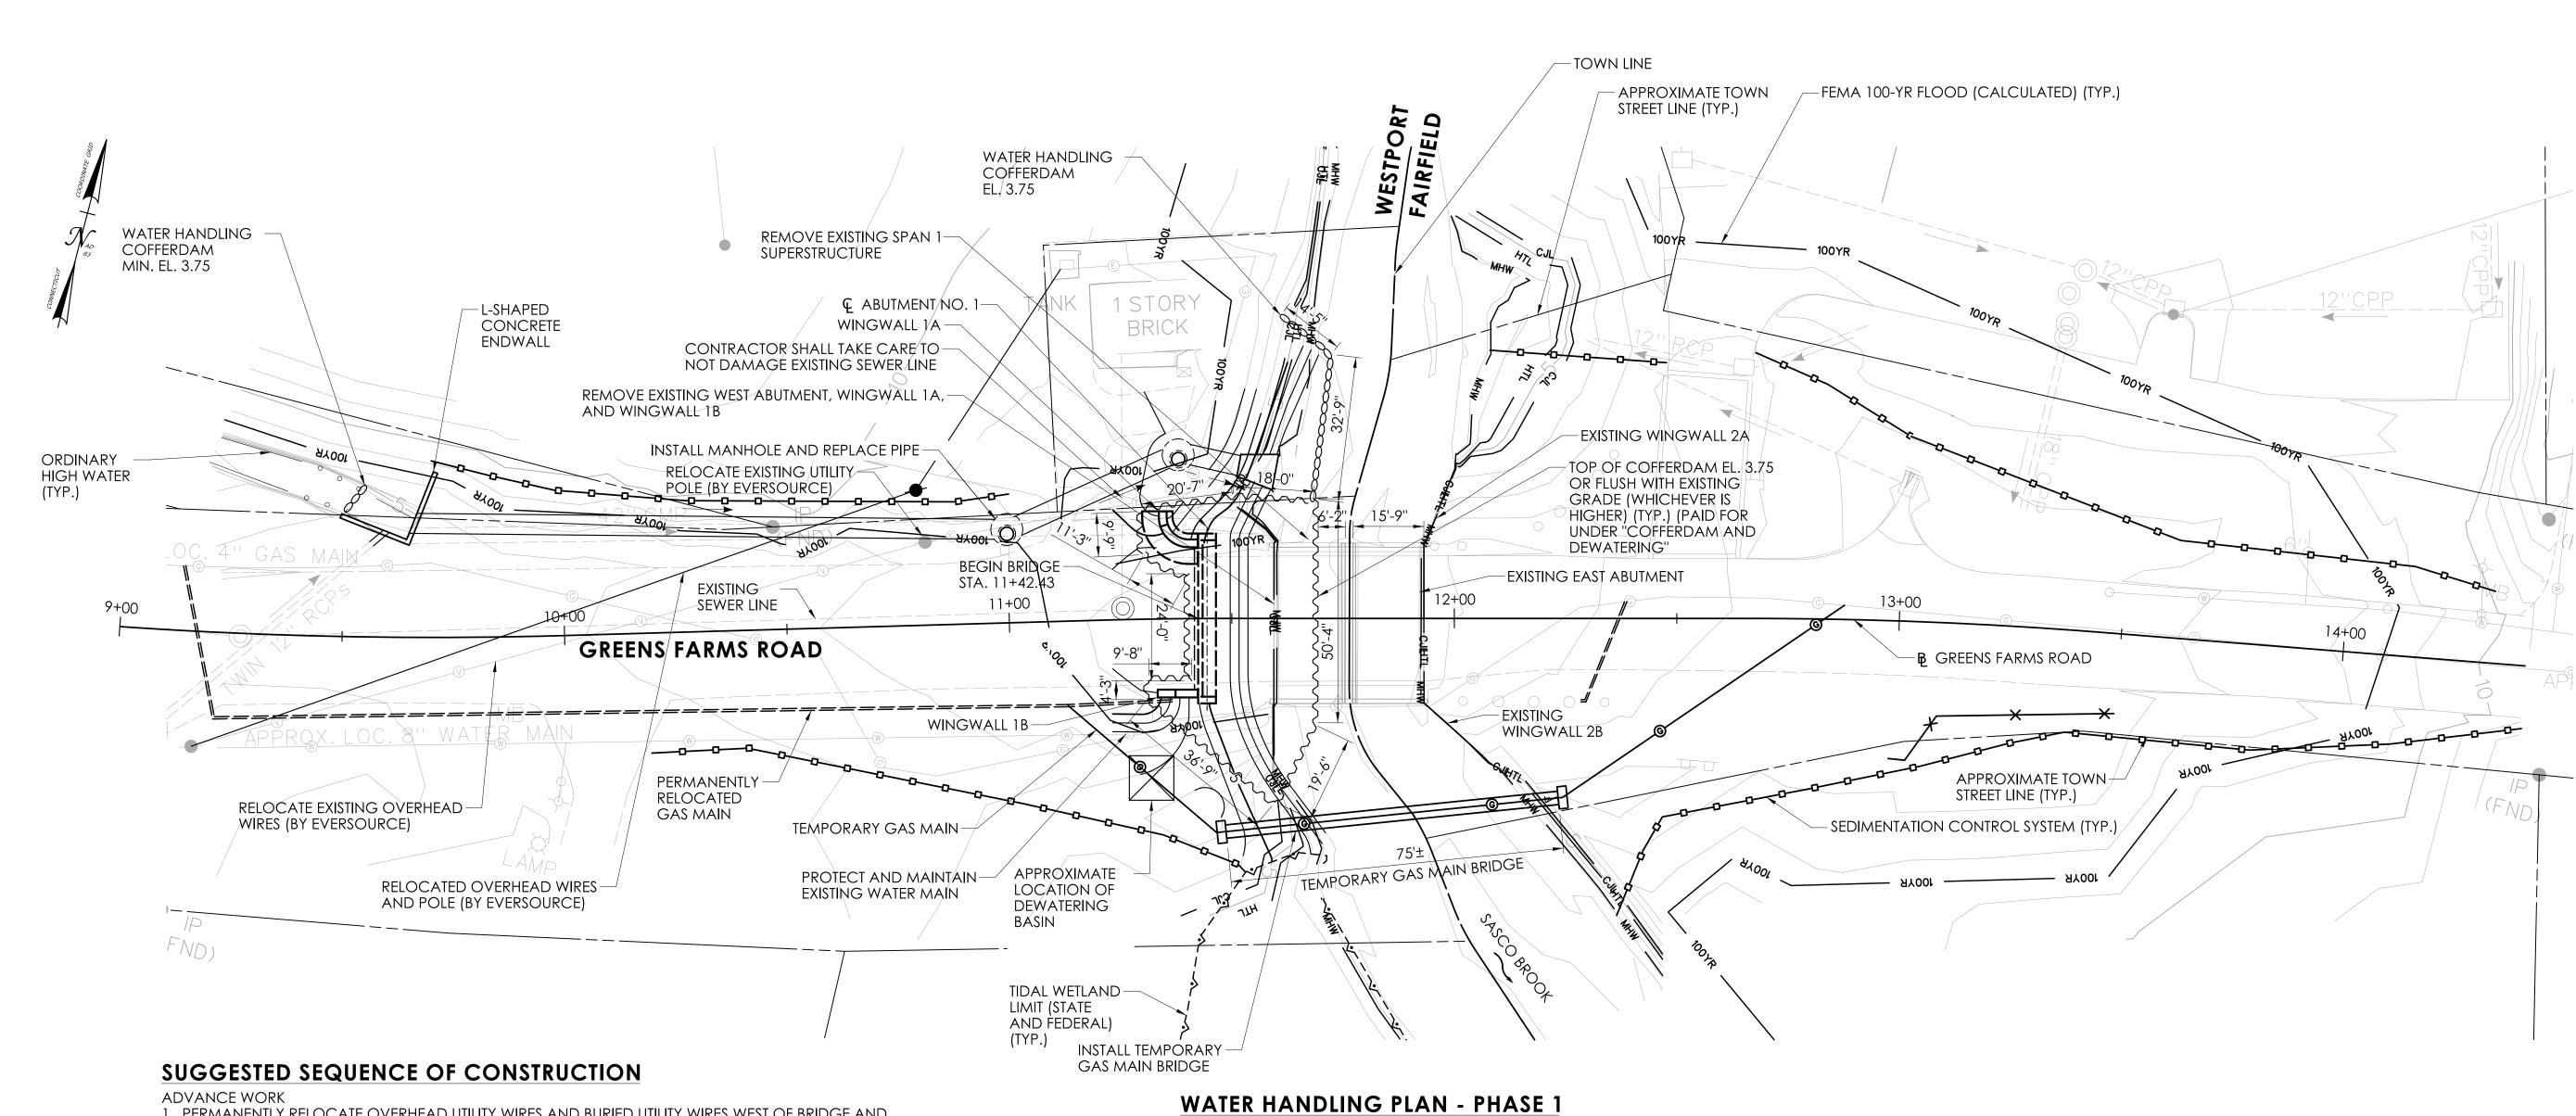

- 1. PERMANENTLY RELOCATE OVERHEAD UTILITY WIRES AND BURIED UTILITY WIRES WEST OF BRIDGE AND
- RE-ATTACH SERVICE TO WATER PUMP SERVICE STATION. 2. INSTALL TEMPORARY GAS MAIN BRIDGE AND TEMPORARY GAS MAIN
- 3. CLEAR AND GRUB AND INSTALL SEDIMENTATION CONTROL SYSTEMS

DESIGNER/DRAFTER: M. HABEK

- INSTALL DETOUR SIGNAGE AND CLOSE ROADWAY
- 2. INSTALL TEMPORARY DEBRIS SHIELD IN SPAN 1. MINIMUM ELEVATION OF TEMPORARY DEBRIS
- SHIELD EL. 3.75. 3. MOBILIZE CRANE
- 4. DEMOLISH EXISTING SPAN 1 SUPERSTRUCTURE. REMOVE TEMPORARY DEBRIS SHIELD
- 5. INSTALL WATER HANDLING COFFERDAM IN SWALE AT APPROXIMATE STATION 9+50 AND INSTALL DEWATERING BASIN BEHIND EXISTING WINGWALL 1B. INSTALL TEMPORARY BYPASS PUMP TO BRING WATER FROM SWALE TO DEWATERING BASIN.
- 6. INSTALL PHASE 1 COFFERDAM AND WATER HANDLING COFFERDAM AT THE WEST SIDE OF THE BRIDGE AS SHOWN.
- 7. REMOVE EXISTING 42" DRAINAGE PIPE, INSTALL NEW MANHOLE, INSTALL NEW 54" DRAINAGE PIPE (AT SWALE), NEW L-SHAPED ENDWALL, AND NEW PIPE END. DEMOLISH EXISTING WEST ABUTMENT AND WINGWALLS COMPLETELY.
- 9. EXCAVATE FOR AND INSTALL MICROPILES AND CAST-IN-PLACE ABUTMENT NO. 1 AND WINGWALLS 1A AND 1B.
- 10. REGRADE CHANNEL WITHIN COFFERDAM AND INSTALL NATURAL STREAMBED MATERIAL
- 11. BACKFILL AND GRADE SLOPES AROUND ABUTMENT NO. 1 AND WINGWALLS 1A AND 1B.
- 12. REMOVE WATER HANDLING COFFERDAM AND DEWATERING BASIN
- 13. REMOVE PORTIONS OF PHASE 1 COFFERDAM NOT SHARED WITH PHASE 2 COFFERDAM

TIME-OF-YEAR BMP NOTES


NO UNCONFINED IN-WATER WORK IS PERMITTED FROM APRIL 1 TO JUNE 30, INCLUSIVE. THIS INCLUDES THE REMOVAL AND INSTALLATION OF COFFERDAMS. AT LEAST 50% OF THE RIVER CHANNEL SHOULD REMAIN OPEN DURING THIS PERIOD. NO CONSTRUCTION NOISES ABOVE 90 DECIBELS AND NO LIGHTS DIRECTED ONTO THE WATER'S SURFACE SHALL BE PERMITTED FROM SUNSET TO SUNRISE, FROM APRIL 1 TO JUNE 30.

WATER HANDLING NOTES

1. THE CONTRACTOR SHALL MAINTAIN WATER THROUGH THE TEMPORARY WATER HANDLING SYSTEM AS

SCALE: 1"=20'

- REQUIRED DURING CONSTRUCTION OF THE NEW STRUCTURE.
- 2. A DEWATERING BASIN SHALL BE ESTABLISHED OUTSIDE OF THE WETLAND LIMITS. 3. TEMPORARY WATER-HANDLING-COFFERDAM SHALL CONSIST OF AN APPROVED SYSTEM THAT THE
- CONTRACTOR ELECTS TO USE WHICH WILL SAFELY CONVEY WATER FLOWS THROUGH THE CONSTRUCTION AREA, SHALL BE ABLE TO SUPPORT CONSTRUCTION ACTIVITY AND SHALL CONFORM
- ANY WATER HANDLING SCHEME DEPICTED WITHIN THE DEPARTMENT'S 'HANDLING WATER TYPICAL SCHEMATICS' MAY BE UTILIZED UNLESS SPECIFICALLY PROHIBITED. A MEANS AND METHOD FOR WATER HANDLING SYSTEM SHALL BE SUBMITTED BY THE CONTRACTOR TO THE ENGINEER FOR APPROVAL. WATER HANDLING MEASURES SHALL NOT EXCEED IMPACT AREAS SHOWN ON THE WETLAND AND FLOODPLAIN IMPACT SHEETS OF THE PERMIT PLANS.

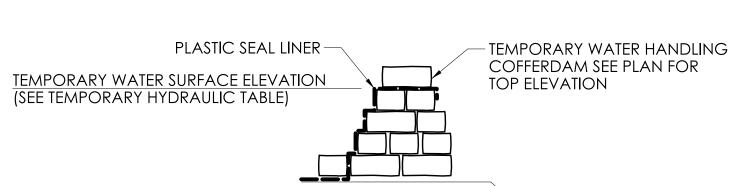

WATER HANDLING COFFERDAM SANDBAGS

NOT TO SCALE

PHASE 1 TEMPORARY HYDRAU	LIC DATA
AVERAGE DAILY FLOW (ADF) [CFS]	16
AVERAGE SPRING FLOW (ASF) [CFS]	31
2 YEAR FREQUENCY DISCHARGE [CFS]	332
TEMPORARY DESIGN DISCHARGE [CFS]	71
TEMPORARY DESIGN FREQUENCY	1-YEAR
TEMPORARY WATER SURFACE EL UPSTREAM	3.4 FEET
TEMPORARY WATER SURFACE EL DOWNSTREAM	3.3 FEET

ENVIRONMENTAL PERMIT PLANS PLAN DATE: MAY 18, 2023


BLOCK: 120 Hebron Avenu



PROJECT NUMBER: 158-219 PROJECT DESCRIPTION: REPLACEMENT OF BRIDGE NO. 04972 GREENS FARMS ROAD OVER SASCO BROOK TOWN(S): WESTPORT DRAWING TITLE: WATER HANDLING PLAN - PHASE 1

PMT-07 SHEET NO. 1.07

CHECKED BY: R. MEARS

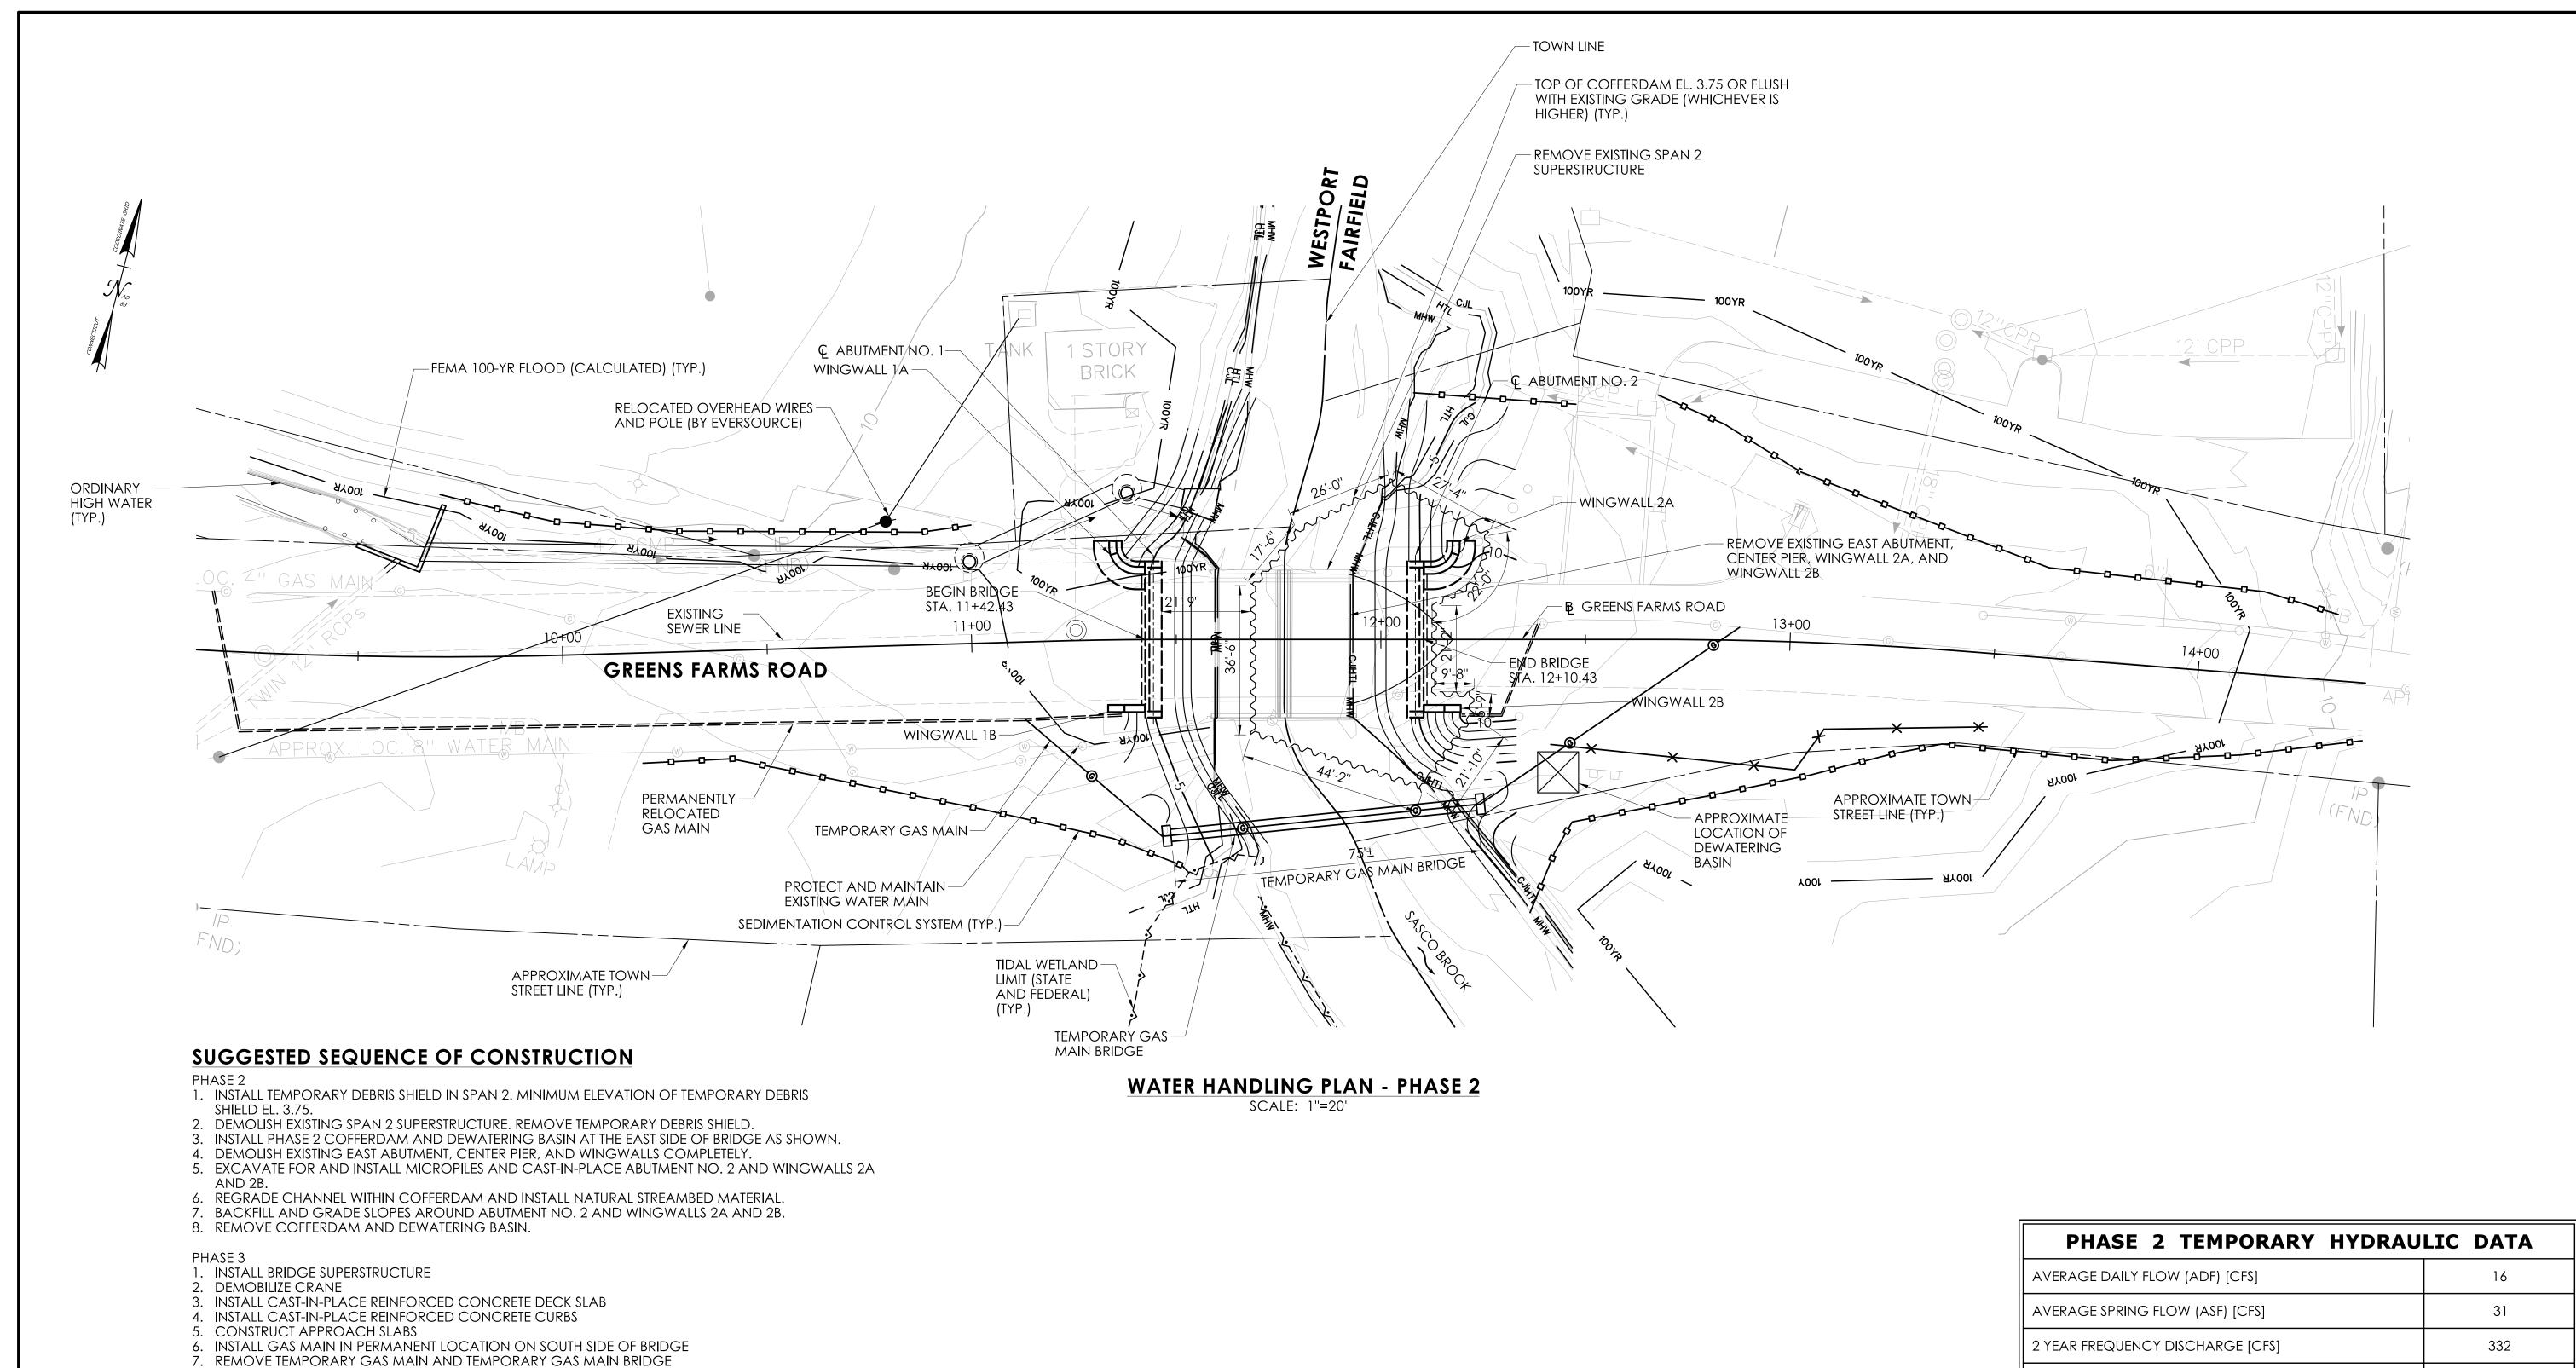

TIME-OF-YEAR BMP NOTES

14. PLACE FINAL PAVEMENT MARKINGS

10. REGRADE DRIVEWAYS

8. INSTALL DRAINAGE PIPES AND STRUCTURES

11. RECONSTRUCT ROADWAY (FULL DEPTH)

13. COMPLETE FINAL GRADING AND SEEDING

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12. INSTALL WATERPROOFING MEMBRANE, PAVE THE BRIDGE AND APPROACH ROADWAYS

PHASE 2 TEMPORARY HYDRAU	LIC DATA
AVERAGE DAILY FLOW (ADF) [CFS]	16
AVERAGE SPRING FLOW (ASF) [CFS]	31
2 YEAR FREQUENCY DISCHARGE [CFS]	332
TEMPORARY DESIGN DISCHARGE [CFS]	71
TEMPORARY DESIGN FREQUENCY	1-YEAR
TEMPORARY WATER SURFACE EL UPSTREAM	3.6 FEET
TEMPORARY WATER SURFACE EL DOWNSTREAM	3.3 FEET

ENVIRONMENTAL PERMIT PLANS PLAN DATE: MAY 18, 2023

BLOCK: DESIGNER/DRAFTER: M. HABEK CHECKED BY: R. MEARS

9. INSTALL GUIDERAIL AND 3-TUBE CURB MOUNTED BRIDGE RAIL

16. REMOVE DETOUR SIGNAGE AND RE-OPEN ROADWAY

15. REMOVE SEDIMENTATION CONTROL SYSTEM UPON FINAL STABILIZATION





PROJECT NUMBER: 158-219 PROJECT DESCRIPTION: REPLACEMENT OF BRIDGE NO. 04972 GREENS FARMS ROAD OVER SASCO BROOK TOWN(S): WESTPORT DRAWING TITLE: WATER HANDLING PLAN - PHASE 2

PMT-08 SHEET NO. 1.08