



# FRONTROYAL II TM VAVRA ASSOCIATES, P.C.

GENERAL REQUIREMENTS:

CONTRACTOR IS RESPONSIBLE TO VERIFY PLAN, EXISTING DIMENSIONS AND CONDITIONS OF THIS PROPOSED DESIGN. DISCREPANCIES SHALL BE PROVIDED TO THE BUILDER IN WRITING PRIOR TO COMMENCEMENT OF CONSTRUCTION.

THESE PLANS ARE DESIGNED IN ACCORDANCE WITH THE 2018 IRC WITH VRC AMENDMENTS. ITEMS NOT ADDRESSED HEREIN ARE SUBJECT TO 2018 IRC AND VRC. IT IS ASSUMED THAT THE CONTRACTOR/ BUILDER IS VERSED IN THE AFOREMENTIONED CODES AND THAT ALL CONSTRUCTION PRACTICES WILL BE EXECUTED IN A MANNER CONSISTENT WITH THESE STANDARDS.

THE CONTRACTOR IS SOLELY RESPONSIBLE FOR ALL CONSTRUCTION MEANS, MATERIALS AND METHODS, ENSURING THAT PROJECT COORDINATION IS IN ACCORDANCE WITH REQUIREMENTS OF THE AUTHORITY HAVING JURISDICTION.

#### STRUCTURAL SPECIFICATIONS:

THE CONDITIONS AND ASSUMPTIONS STATED IN THESE SPECIFICATIONS SHALL BE VERIFIED BY THE CONTRACTOR FOR CONFORMANCE TO ALL CODES AND CONDITIONS. IN THE EVENT OF ANY DISCREPANCY BETWEEN THESE SPECIFICATIONS AND CODES AND CONDITIONS, THE CONTRACTOR SHALL NOTIFY THE BUILDER IN WRITING OF THE DISCREPANCY AND ALTERNATE PRESCRIPTIVE MEASURES OR ENGINEERED SOLUTIONS SHALL BE APPLIED TO ENSURE STRUCTURAL ADEQUACY.

WHERE A CONFLICT BETWEEN THESE DRAWINGS EXISTS WITH AFOREMENTIONED CODE OR DESIGN PRINCIPALS, THE MORE STRINGENT REQUIREMENT SHALL BE FOLLOWED.

DESIGN CRITERIA	
SROUND SNOW LOAD	25
EXPOSURE CATEGORY (WALL BRACING)	В
SEISMIC DESIGN CATEGORY	В
WEATHERING PROBABILITY	SEVERE
FROST DEPTH	JURISDICTIONAL
INDERLAYMENT REQUIRED	YE5

LIVE LOADING	
LIVING AREAS	40
SLEEPING AREAS	30
ATTICS WITH STORAGE	20
HABITABLE ATTICS	30
BALCONIES AND DECKS	40
PASSENGER VEHICLE GARAGES	50
5TAIRS	40

SOILS SHALL PROVIDE AN ASSUMED 1500 LBS. ALLOWABLE BEARING. THE WATER TABLE (SEASONAL OR OTHERWISE) SHALL NOT EXTEND TO WITHIN 2' OF THE BOTTOM OF CONCRETE SLABS, FOOTINGS AND WALLS.

FOOTINGS MUST EXTEND TO FROST DEPTH DESIGNATED BY THE AUTHORITY HAVING JURISDICTION.
FOOTINGS SHALL BE PLACED ON NON-EXPANSIVE SOILS.

BACKFILL FOR SLABS MUST BE IN ACCORDANCE WITH IRC R506.

CONCRETE COMPRESSIVE STRENGTH	
BASEMENT WALLS, FOUNDATIONS AND OTHER CONCRETE WALLS NOT EXPOSED TO WEATHER	25 <i>00</i> PSI
BASEMENT SLABS AND INTERIOR SLABS ON GROUND (NOT GARAGES)	25 <i>00</i> PSI
BASEMENT WALLS, FOUNDATION WALLS, EXTERIOR WALLS AND OTHER VERTICAL CONCRETE EXPOSED TO WEATHER	35 <i>00</i> PSI
PORCHES, CARPORT SLABS, STEPS EXPOSED TO WEATHER AND OTHER VERTICAL CONCRETE EXPOSED TO WEATHER.	3500 PSI

ALL STRUCTURAL WALL SHEATHING SHALL BE ½" O.S.B AND FASTENED IN ACCORDANCE WITH TABLE 602.10.4.

STRUCTURAL FLOOR SHEATHING SHALL BE MINIMUM  $\frac{3}{4}$ " O.S.B TONGUE AND GROOVE OR BLOCKED AT ALL EDGES. FASTEN WITH 8D COMMON NAILS FASTENED 6" AT EDGES 12" AT INTERMEDIATE SUPPORT.

MASONRY:

ALL SOLID SAWN HEADERS, BEAMS AND GIRDERS SHALL BE MINIMUM SYP #2. APPLY WET FACTOR FOR WEATHER EXPOSED MEMBERS.

ALL WOODEN MEMBERS SHALL BE PROTECTED FROM DECAY AND TERMITE INFESTATION IN

WOOD TRUSSES SHALL BE DESIGNED INSTALLED AND MANUFACTURED IN ACCORDANCE WITH ANSI TPI I. MANUFACTURER SHALL PROVIDE SEALED TRUSS DRAWINGS FOR REVIEW AND INSPECTION.

ACCORDANCE WITH R317 AND R318 OF THE IRC.

PROVIDE A CONTINUOUS DOUBLE TOP PLATE ACROSS ALL BEARING STUD WALLS.

MINIMUM COLUMN SUPPORT UNDER ANY BEAM OR HEADER UNLESS OTHERWISE NOTED IS A SINGLE 2X4 SPF #2. HEADERS MUST HAVE A MINIMUM OF I JACK STUD AND I KING STUD.

FOUNDATION ANCHORAGE SHALL BE IN ACCORDANCE WITH R403.1.6.

TRANSFERRED TO A BEAM BELOW.

ALL STRUCTURAL COMPOSITE LUMBER SHALL BE INSTALLED IN ACCORDANCE WITH MANUFACTURER'S SPECIFICATIONS AND MUST BE ACCOMPANIED BY BOTH A LAYOUT AND BEAM

ALL POSTS SHOWN ON FLOOR OR FRAMING PLAN SHALL TERMINATE TO FOOTING AT GROUND OR

SHEETS PRODUCED BY THE DESIGNER.

BORING AND NOTCHING LIMITS SHALL EXCEED NEITHER MANUFACTURER'S SPECS FOR STRUCTURAL COMPOSITE NOR IRC LIMITS FOR SOLID SAWN LUMBER.

ALL WALLS TO BE ASSEMBLED IN ACCORDANCE WITH FLOOR PLAN AND FRAMING PLANS REFERENCED HERE.

MORTAR USED SHALL BE TYPE "S". ANY ADDITIVES SHALL BE PROPORTIONED IN ACCORDANCE WITH ASTM C-270.

BRICK VENEER SHALL BE ATTACHED TO FRAMING WITH MINIMUM 22 GAUGE GALVANIZED CORRUGATED STEEL TIES  $\frac{7}{6}$ " WIDE 24" O.C VERTICALLY AND 32" O.C. HORIZONTALLY.

WEEP HOLES SHALL BE WITHIN THE FIRST COURSE ABOVE GRADE AND WITHIN THE FIRST COURSE ABOVE STEEL LINTELS. WEEP HOLES SHALL BE NO LESS THAN 3/16" DIAMETER AND NO MORE THAN 33" O.C.

VENEER FLASHING SHALL BE IN ACCORDANCE WITH IRC R703.7.5

ALLOWA	BLE SPANS FOR LINTELS	SUPPORTING MASONRY	VENEER
ANGLE SIZE	NO STORY ABOVE	ONE STORY ABOVE	TWO STORIES ABOVE
3×3×1/4	6'	4'-6"	3'
4×3×1⁄4	8'	6'	4'-6"
5X <sup>3</sup> ½X <sup>5</sup> %	10'	8'	6'
6׳½×5⁄6	14'	9'-6"	7'
2-6׳½×5/6	20'	12'	9'-6"

ALL MASONRY FOUNDATION CONSTRUCTION SHALL BE INSTALLED IN ACCORDANCE WITH TMS 402, ACI 530, ASCE 5 NCMA TR68-A. THE IRC PRESCRIPTIVE CODE MAY BE USED AS AN ALTERNATIVE.

### ENERGY, THERMAL & MOISTURE

WHERE REQUIRED, WALLS SHALL BE DAMPROOFED/ WATERPROOFED IN ACCORDANCE WITH IRC R405 & R406.

A 6 MIL. POLYETHYLENE VAPOR RETARDER SHALL BE PLACED BENEATH ALL INTERIOR SLABS.

THE EARTH ENCLOSED BY CRAWL SPACES SHALL BE COVERED WITH A CLASS I VAPOR RETARDER IN ACCORDANCE WITH IRC R408.

FLASHING SHALL BE INSTALLED ON ALL EXTERIOR WALLS TO ENSURE AGAINST WATER INFILTRATION. ALL AREAS SPECIFIED IN IRC R703.8 SHALL BE ADDRESSED AS SPECIFIED.

AN APPROVED WATER RESISTIVE BARRIER SHALL BE APPLIED TO ALL EXTERIOR SHEATHING. EITHER TYPE I #15 ROOF FELT OR OTHER LISTED AND APPROVED HOUSEWRAP WILL SATISFY THIS REQUIREMENT. INSTALLATION, LAPS, JOINTS AND SEAMS SHALL BE INSTALLED IN ACCORDANCE WITH IRC R703.2 OR MANUFACTURER'S INSTALLATION INSTRUCTIONS.

THE BUILDING THERMAL ENVELOPE IN THESE DRAWINGS ARE ASSUMED TO BE CLIMATE ZONE 5. THE THERMAL ENVELOPE SHALL BE SEALED IN ACCORDANCE WITH IRC IIO2.4.I.I. INSULATION R-VALUES (WHEN INSTALLED PRESCRIPTIVELY) SHALL BE INSTALLED IN ACCORDANCE WITH THE TABLE BELOW. WHEN PRESCRIPTIVE INSTALLATION IS NOT PRACTICAL A RESCHECK MAY ACCOMPANY THESE PLANS AS AN ALTERNATIVE FOR THE BUILDING OFFICIAL'S APPROVAL.

INSULATION AND FENESTRATION REQUIREMENTS		
CLIMATE ZONE	5 EXCEPT MARINE	
FENESTRATION U-FACTOR	0.32	
SKYLIGHT U-FACTOR	0.55	
GLAZED FENESTRATION SHGC	NR	
CEILING R-VALUE	49	
WOOD FRAME WALL R-VALUE	20	
MASS WALL R-VALUE	13 / 17	
FLOOR R-VALUE	30	
BASEMENT WALL R-VALUE	IO CONTINUOUS OR 13 CAVITY	
SLAB R-VALUE AND DEPTH	IO, 4 FT	
CRAWL SPACE WALL R-VALUE	15-19	

#### SAFETY:

ALL HANDRAILS AND GUARDRAILS ARE TO BE INSTALLED IN ACCORDANCE WITH R3II AND R3I2. SMOKE ALARMS SHALL BE LOCATED AND INSTALLED ACCORDING TO IRC. R3I4.

CARBON MONOXIDE ALARMS, WHEN REQUIRED, SHALL BE LOCATED AND INSTALLED IN ACCORDANCE WITH IRC R315.

GLAZING IN HAZARDOUS LOCATIONS, AS SPECIFIED IN IRC R308, SHALL BE ASSEMBLED AND IDENTIFIED WITH A MANUFACTURER'S DESIGNATION SPECIFYING WHO APPLIED THE DESIGNATION AND THE STANDARD WITH WHICH IT COMPLIES, ALTERNATIVE CERTIFICATION MAY BE CONSIDERED BY THE BUILDING OFFICIAL.

DWELLING/ GARAGI	E FIRE SEPARATION
FROM RESIDENCE AND ATTICS	½" GYP APPLIED TO GARAGE SIDE
FROM ALL HABITABLE ROOMS ABOVE GARAGE	%" TYPE X GYP BOARD
STRUCTURES SUPPORTING FLOOR/ CEILING ASSEMBLIES USED FOR SEPARATION	½" GYP BOARD
GARAGES LOCATED LESS THAN 3 FEET FROM A DWELLING UNIT ON THE SAME LOT	½" GYP BOARD APPLIED TO INTERIOR SIDE C EXTERIOR WALLS THAT ARE WITHIN THIS AREA
	•

## FOR USE ON ANY OTHER PROJECT OR LOCATION.

THESE PLANS ARE NOT LICENSED

WESTPORT, CONNECTICUT 06880

LICENSE
THIS HOME PLAN IS LICENSED TO BE
USED ONE TIME ONLY FOR THE

FOLLOWING PROJECT:

HAVAS RESIDENCE 9 LAKEVIEW ROAD


COPYRIGHT NOTICE:


THIS HOME PLAN IS PROTECTED UNDER THE UNITED STATES COPYRIGHT LAW. WHEN PURCHASING A HOME PLAN FROM US, YOU HAVE BEEN LICENSED THE RIGHT TO BUILD ONE RESIDENCE. THIS PLAN MAY NOT BE COPIED, RESOLD, OR USED FOR THE CONSTRUCTION OF MORE THAN ONE RESIDENCE WITHOOUT THE EXPRESS WRITTEN PERMISSION OF TMVAVRA ASSOCIATES P.C.. TMVAVRA ASSOCIATES P.C. RETAINS ALL RIGHTS, TITLE, AND OWNERSHIP OF THE ORIGINAL DESIGN AND DOCUMENTS, AS WELL AS ANY DERIVATIVE VERSION OF THE PLANS.


DISCLAIMER AND CONSTRUCTION WARNING:


THESE PLANS HAVE BEEN PREPARED TO MEET GENERALLY ACCEPTED


PROFESSIONAL STANDARDS AND PRACTICES IN EFFECT AT THE TIME THEY WERE CREATED. THESE PLANS HAVE BEEN DEVELOPED WITHOUT KNOWLEDGE OR REFERENCE TO A SPECIFIC SITE OR GEOGRAPHICAL AREA. BECAUSE LOCAL AND STATE BUILDING REGULATIONS VARY WIDELY AND ARE SUBJECT TO CHANGE, CONFORMANCE OF THESE PLANS MEETING THE REQUIREMENTS OF EACH JURISDICTION IS NOT POSSIBLE. IT IS THE PURCHASER AND THEIR BUILDERS RESPONSIBILITY TO KNOW AND BUILD WITH CURRENT CODES AND REGULATIONS GOVERNING THE PROJECT. THE USE OF THESE PLANS IS EXPRESSLY CONDITIONED UPON THE PURCHASERS OBLIGATION AND AGREEMENT TO STRICTLY COMPLY WITH ALL APPLICABLE CODES, ORDINANCES, REGULATIONS AND REQUIREMENTS INCLUDING IF MANDATED THE SEAL OF A N ARCHITECT REGISTERED IN THE JURISDICTION OR STATE. IT IS ALSO THE RESPONSIBILITY OF THE PURCHASER AND OR THEIR BUILDER TO PROVIDE ANY INFORMATION REQUIRED BY THEIR LOCAL JURISDICTION THAT IS NOT CONTAINED IN THESE DRAWINGS. BEFORE STARTING CONSTRUCTION IT IS THE RESPONSIBILITY OF THE PURCHASER TO CHECK AND BE RESPONSIBLE FOR ALL DIMENSIONS AND OTHER DETAILS. IT IS THE RESPONSIBILITY OF THE PURCHASER TO OBTAIN ANY STRUCTURAL, LAND USE ,ENERGY OR OTHER REQUIRED ANALYSIS, ENGINEERING CALCULATIONS, AND ANY OTHER SPECIFICATIONS THAT MAY BE REQUIRED IN THE JURISDICTION WHERE THE PROJECT IS TO BE BUILT. TOPOGRAPHIC AND SUBSURFACE CONDITIONS SHOULD BE VERIFIED AND FOUNDATION AND FRAMING PLANS ADJUSTED ACCORDINGLY, AND THE MATERIAL AND EQUIPMENT MANUFACTURER'S INSTRUCTIONS MUST BE FOLLOWED. CODES GOVERN OVER DRAWINGS, AND DIMENSIONS GOVERN OVER SCALE. IT IS SUGGESTED THAT A LOCAL ARCHITECT BE RETAINED TO REVIEW AND MAKE ANY NECESSARY CHANGES TO ENSURE THE PLANS MEET THE ABOVE REQUIREMENTS. ANY USE OF THIS INFORMATION WITHOUT ADAPTATION TO LOCAL CODES AND REQUIREMENTS, STANDARDS, SITE CONDITIONS, AND OTHER FACTORS IS AT THE PURCHASERS SOLE RISK. TMVAVRA ASSOCIATES, P.C. DISCLAIMS ALL WARRANTIES, EXPRESSED OR IMPLIED, INCLUDING MERCHANTABILITY OR FITNESS OF PURPOSE. PLAN PURCHASER AGREES THAT TMVAVRA ASSOCIATES P.C. SHALL NOT BE LIABLE FOR DIRECT, INCIDENTAL, SPECIAL, CONSEQUENTIAL, OR INDIRECT DAMAGES OF ANY KIND, INCLUDING, BUT NOT LIMITED TO, LOSS OF ANTICIPATED PROFITS, BUSINESS OPPORTUNITY, OR OTHER ECONOMIC LOSS ARISING OUT OF USE OF THE PLANS. TMVAVRA ASSOCIATES P.C. ASSUMES NO RESPONSIBILITY FOR CHANGES MADE TO THESE PLANS BY OTHERS. THE PURCHASER AGREES TO DEFEND AND INDEMNIFY TMVAVRA ASSOCIATES P.C. AND/OR ITS ASSIGNS FOR ALL CLAIMS, COSTS, LOSSES, OR DAMAGES RESULTING FROM THE USE OF THESE PLANS AND INFORMATION.

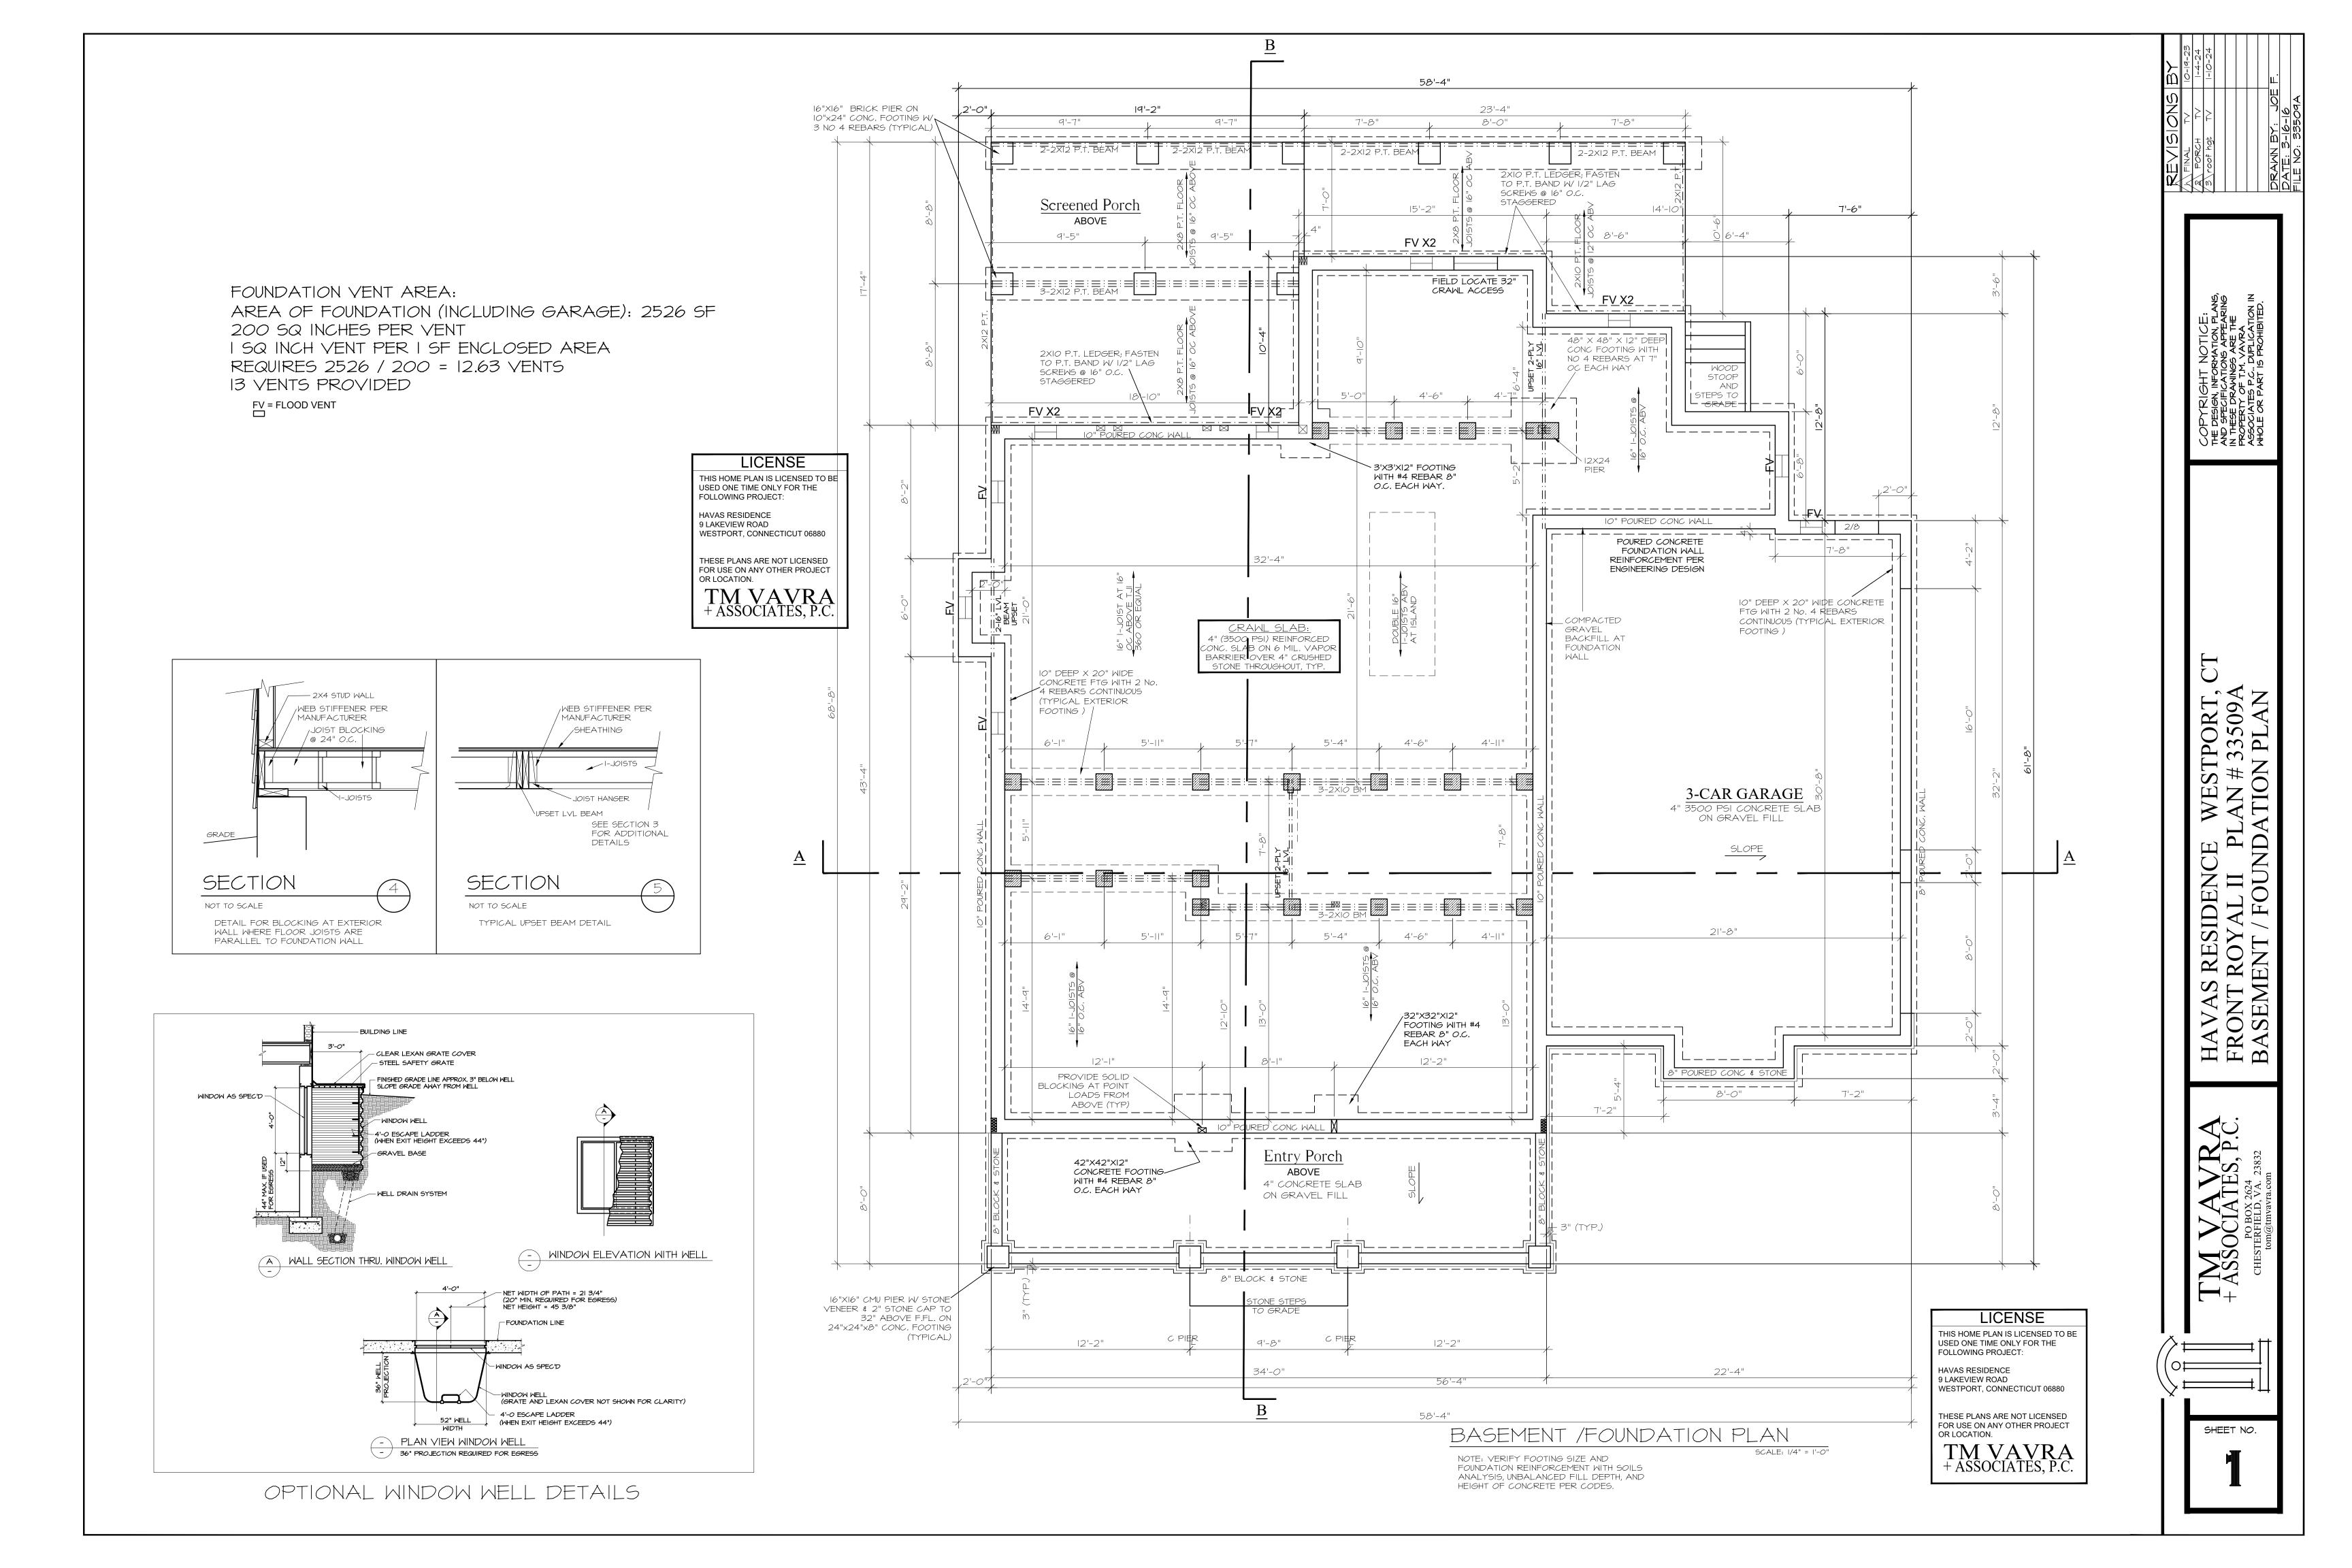


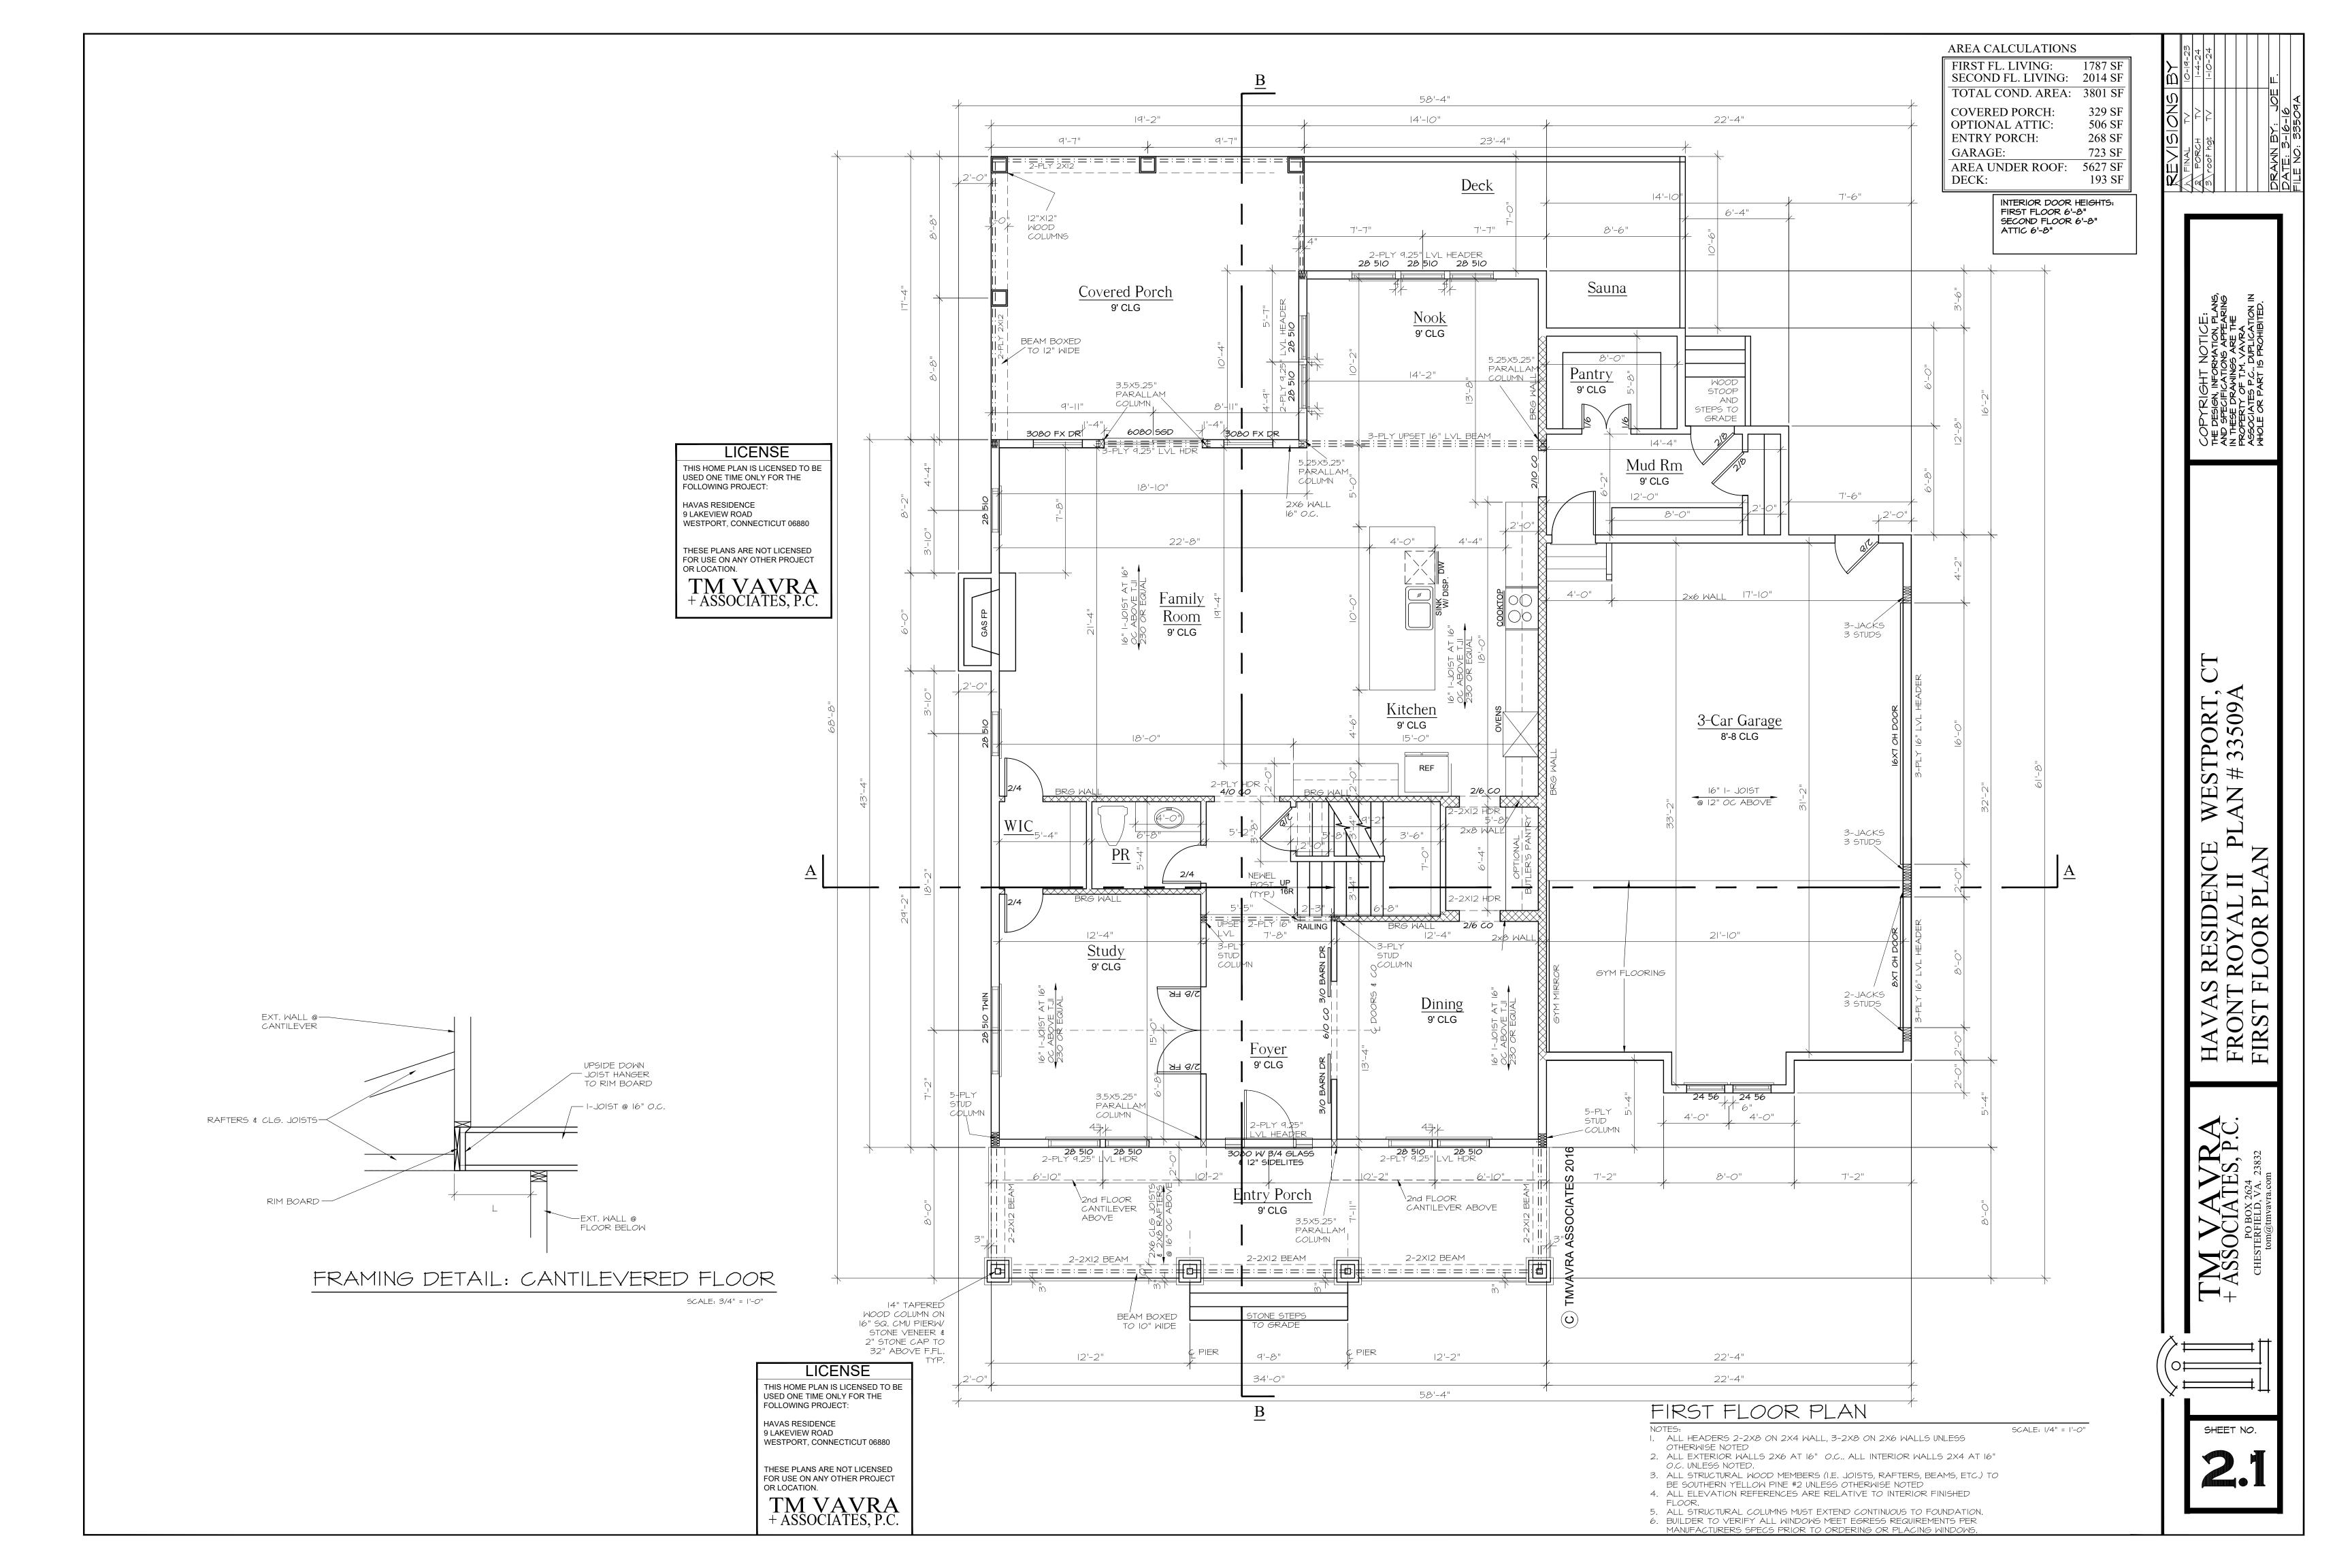

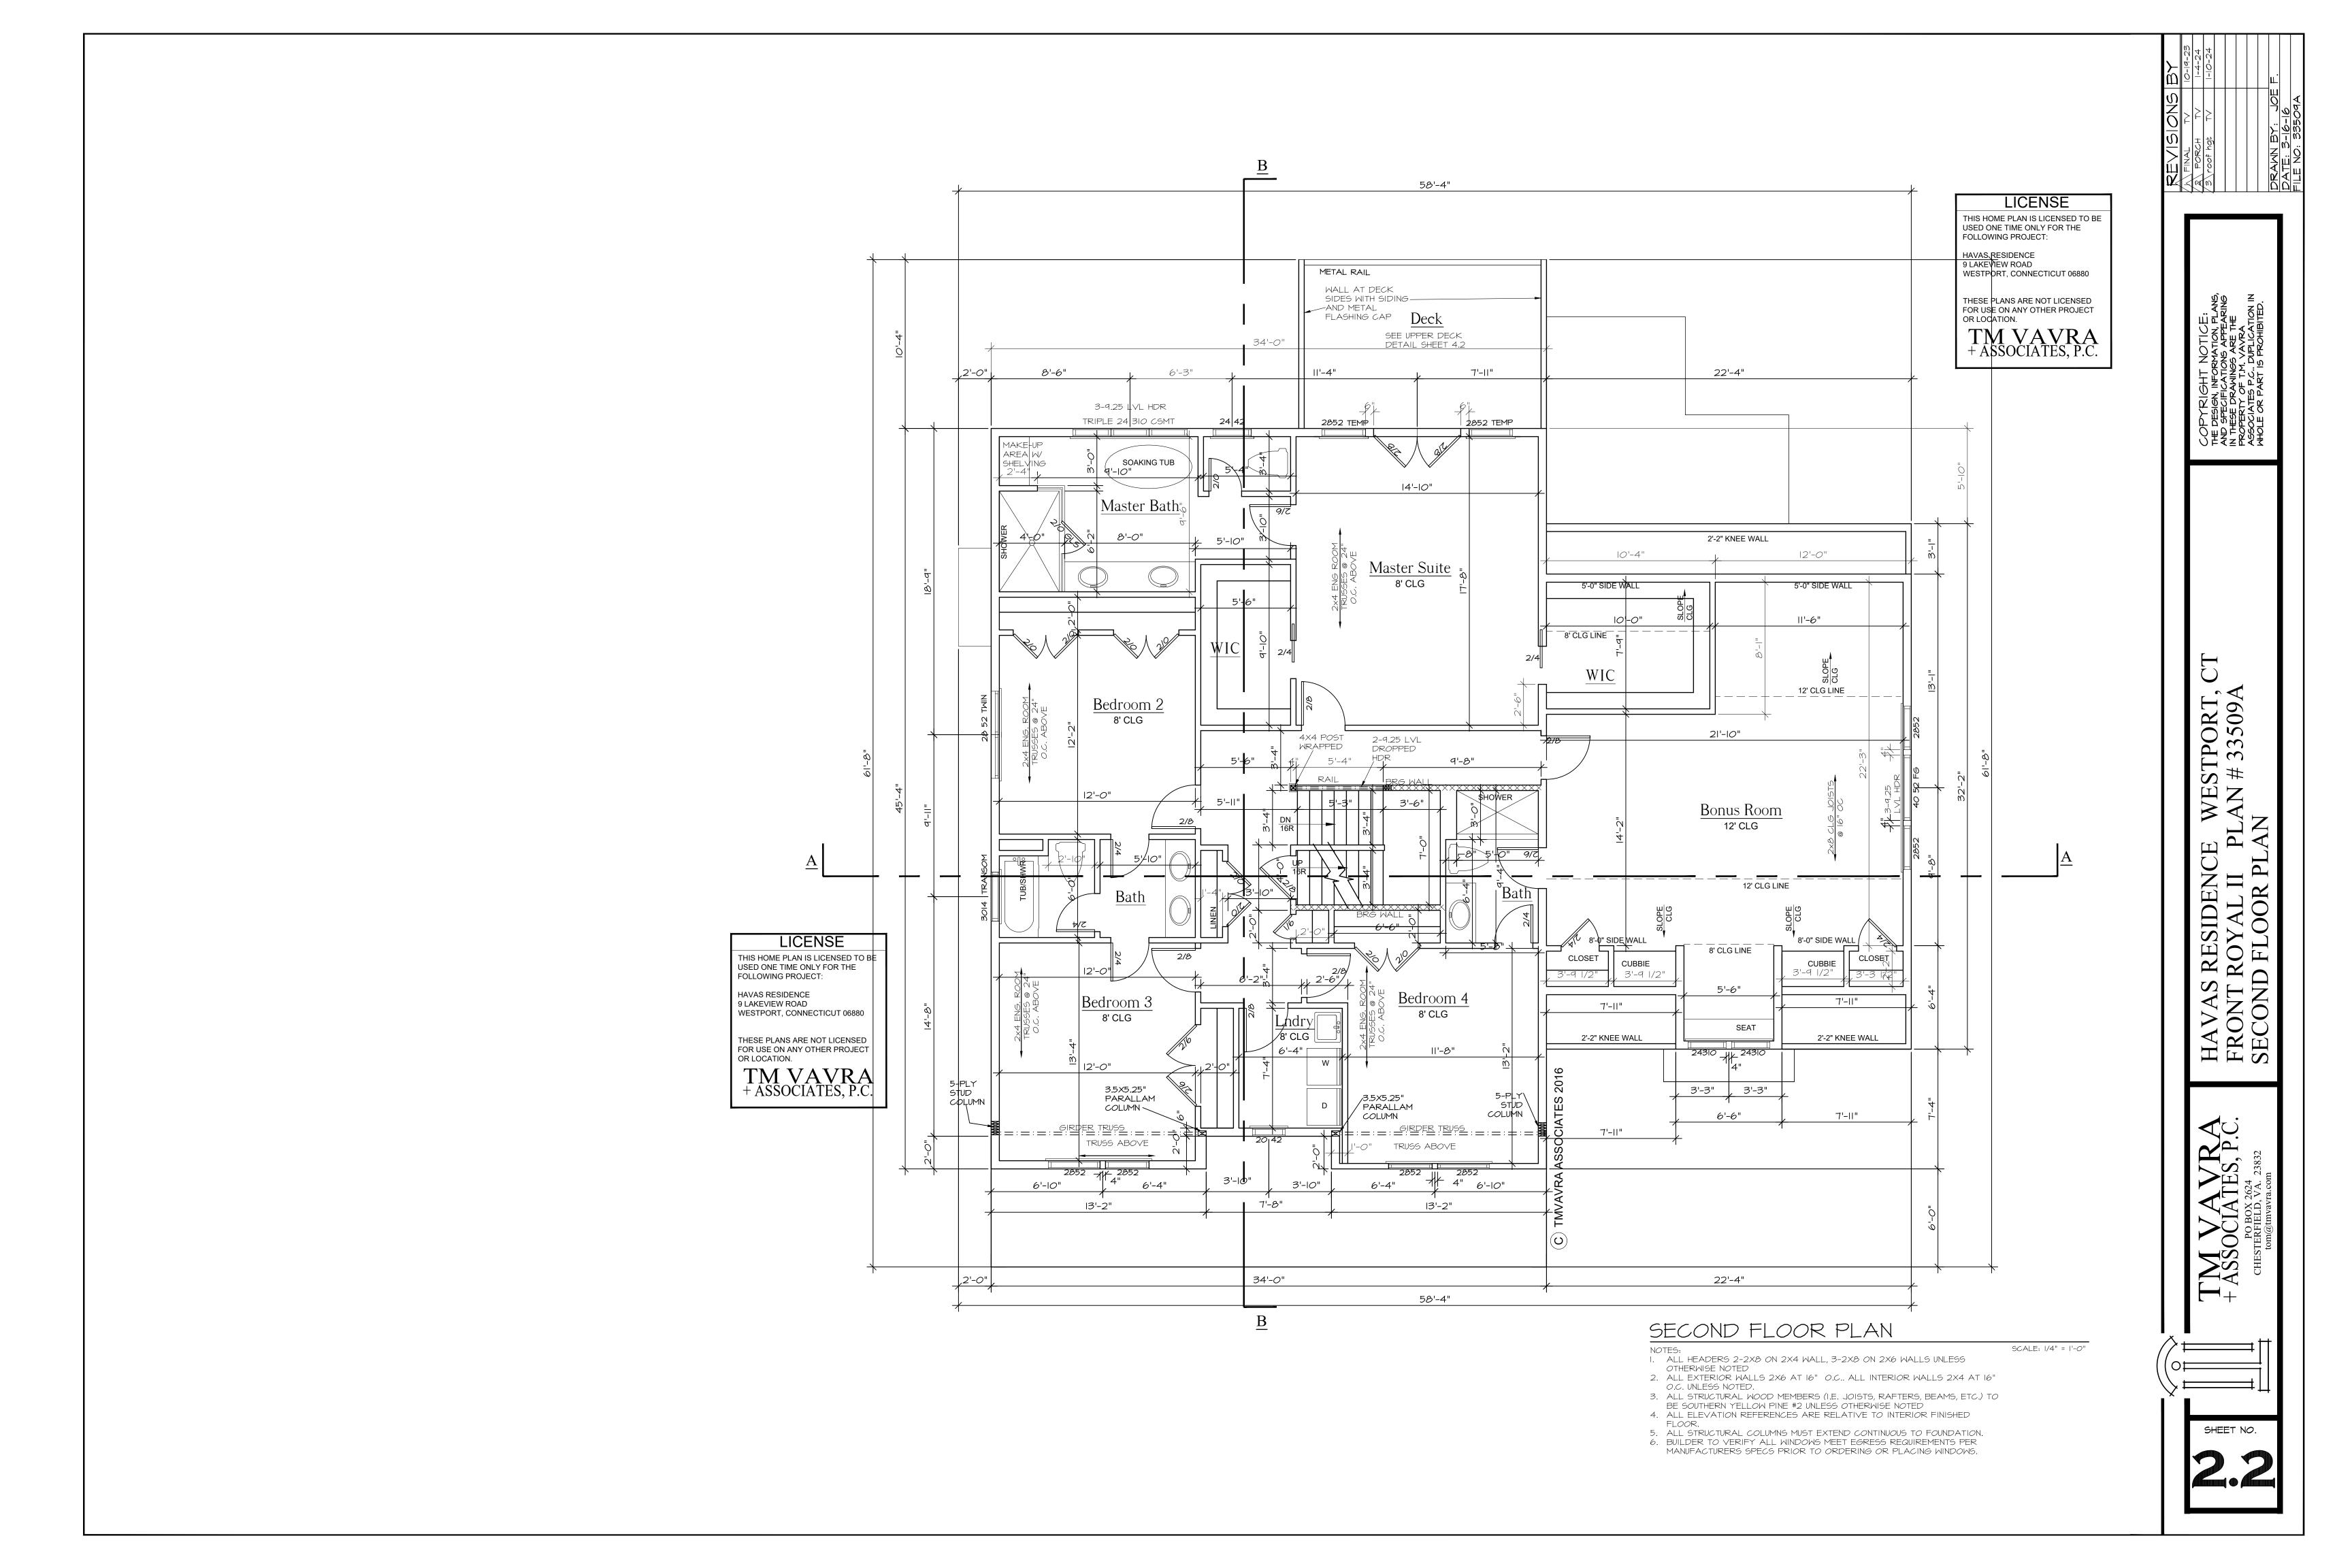

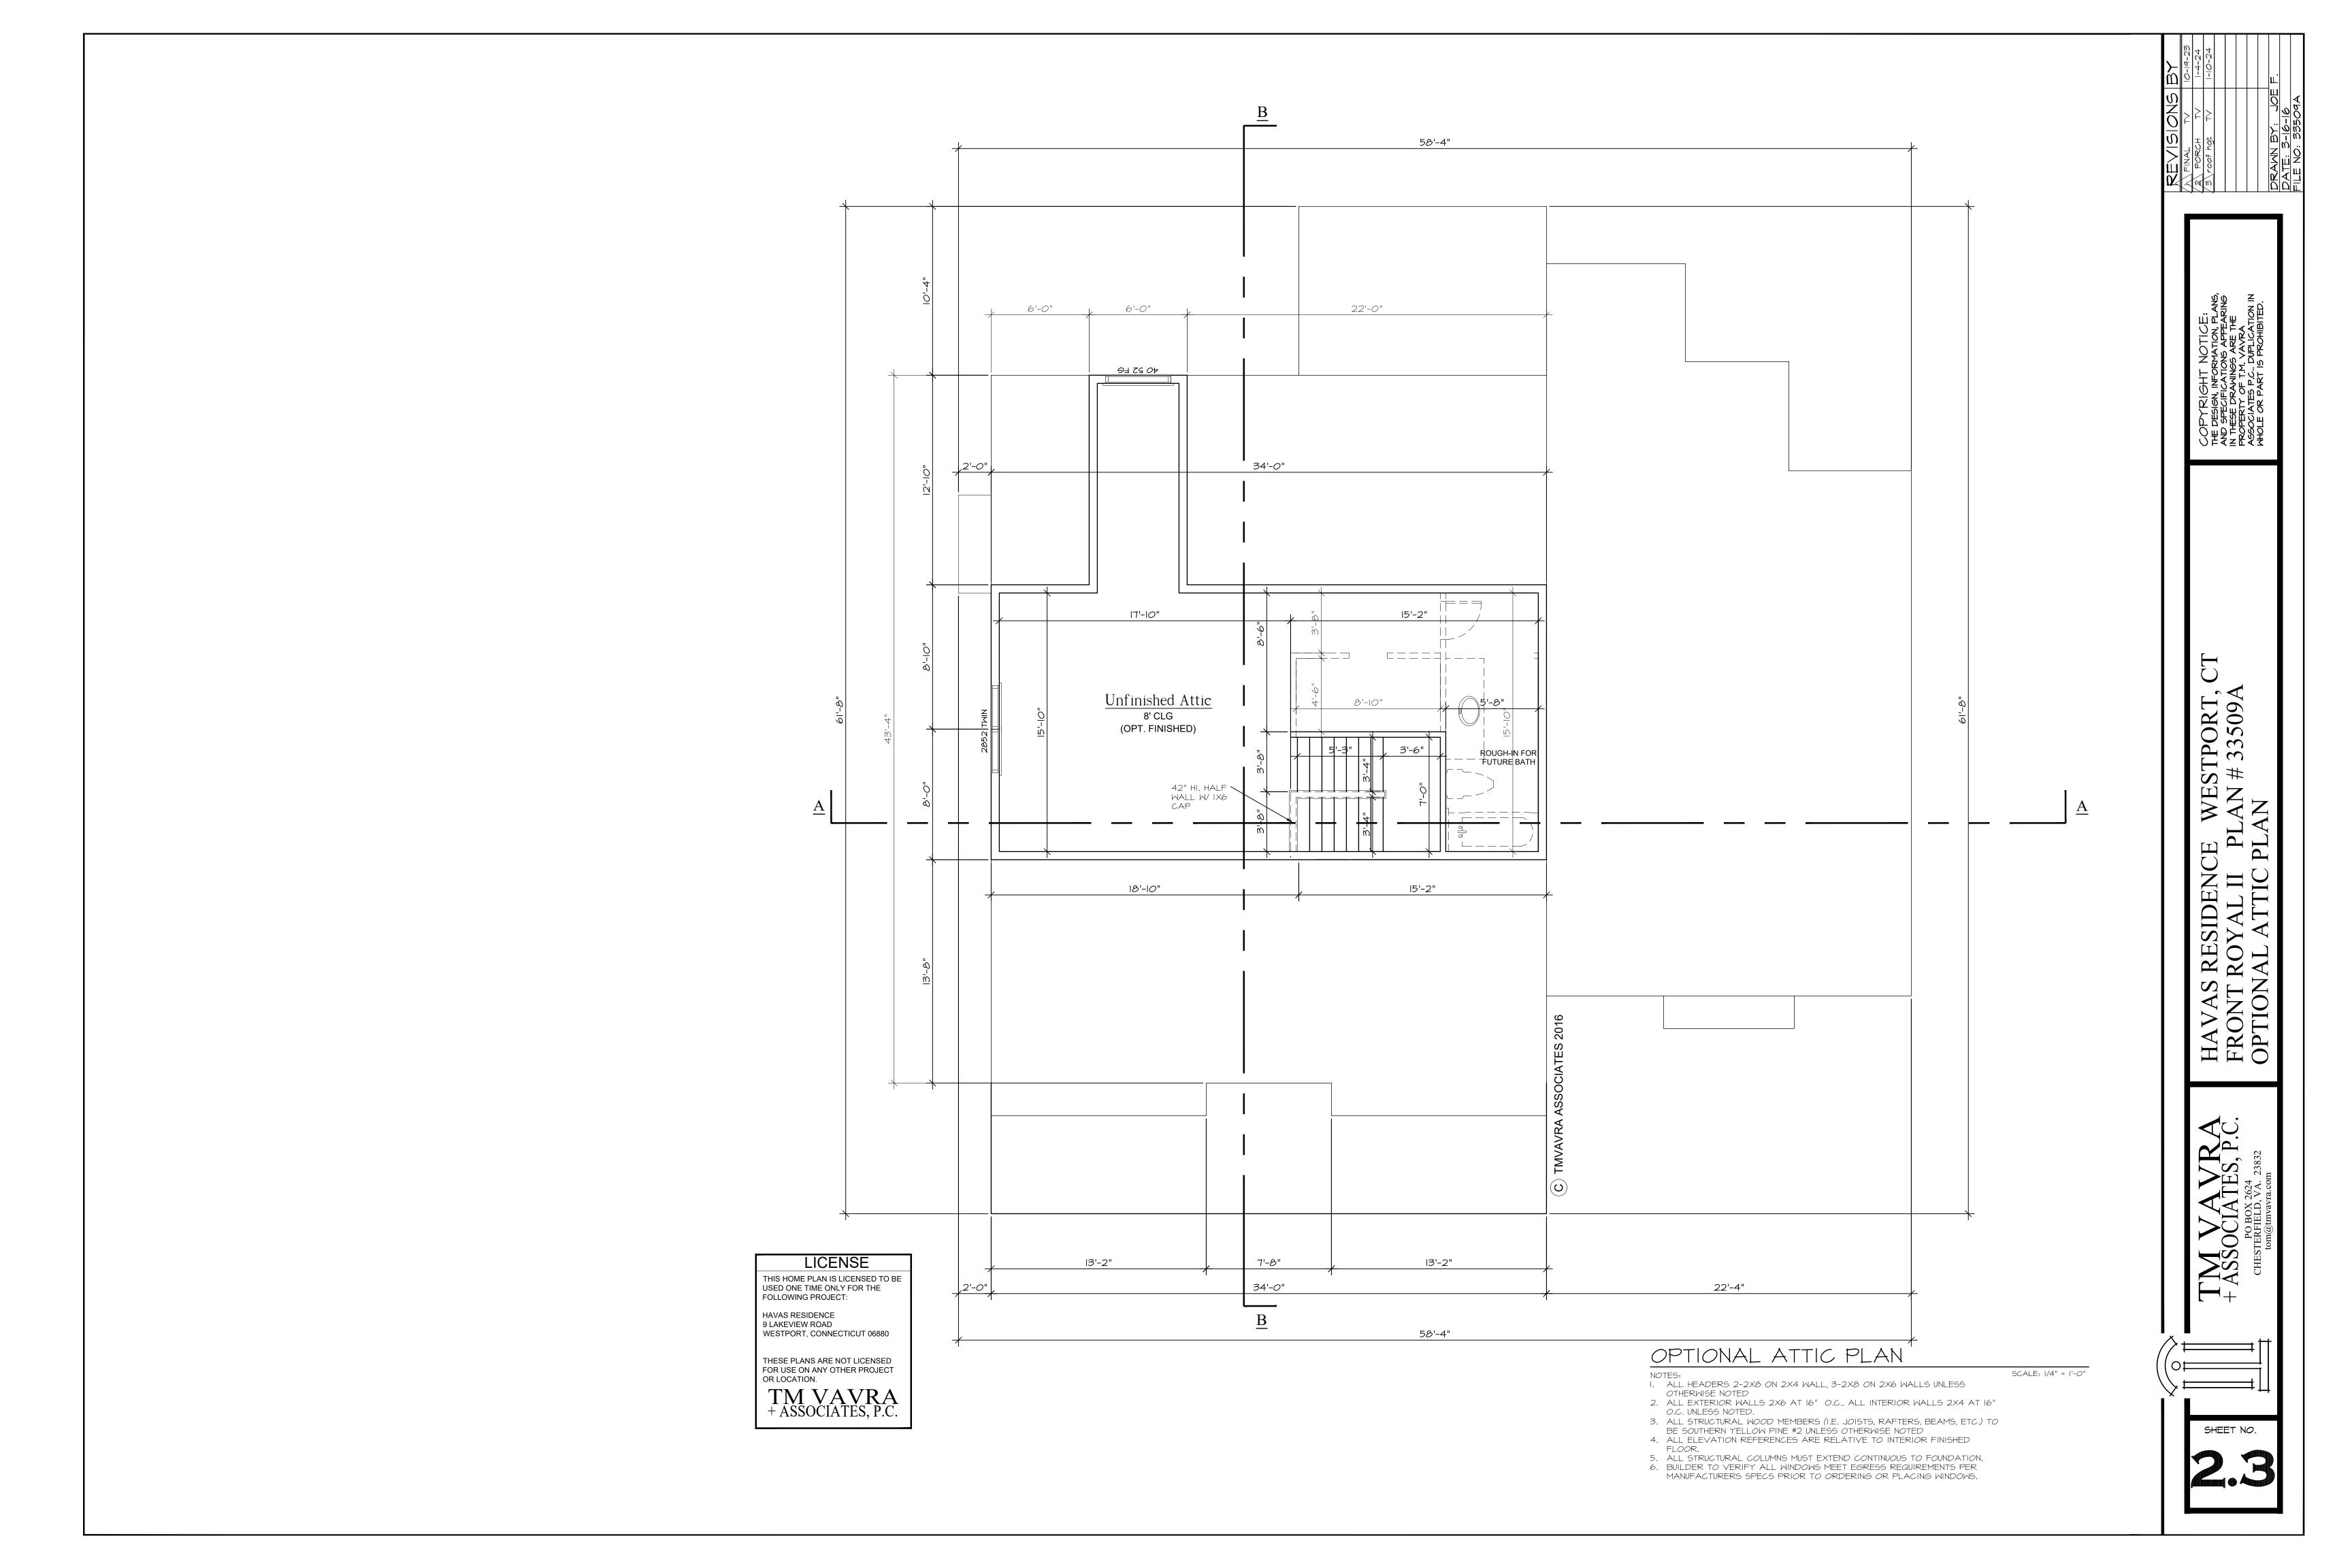


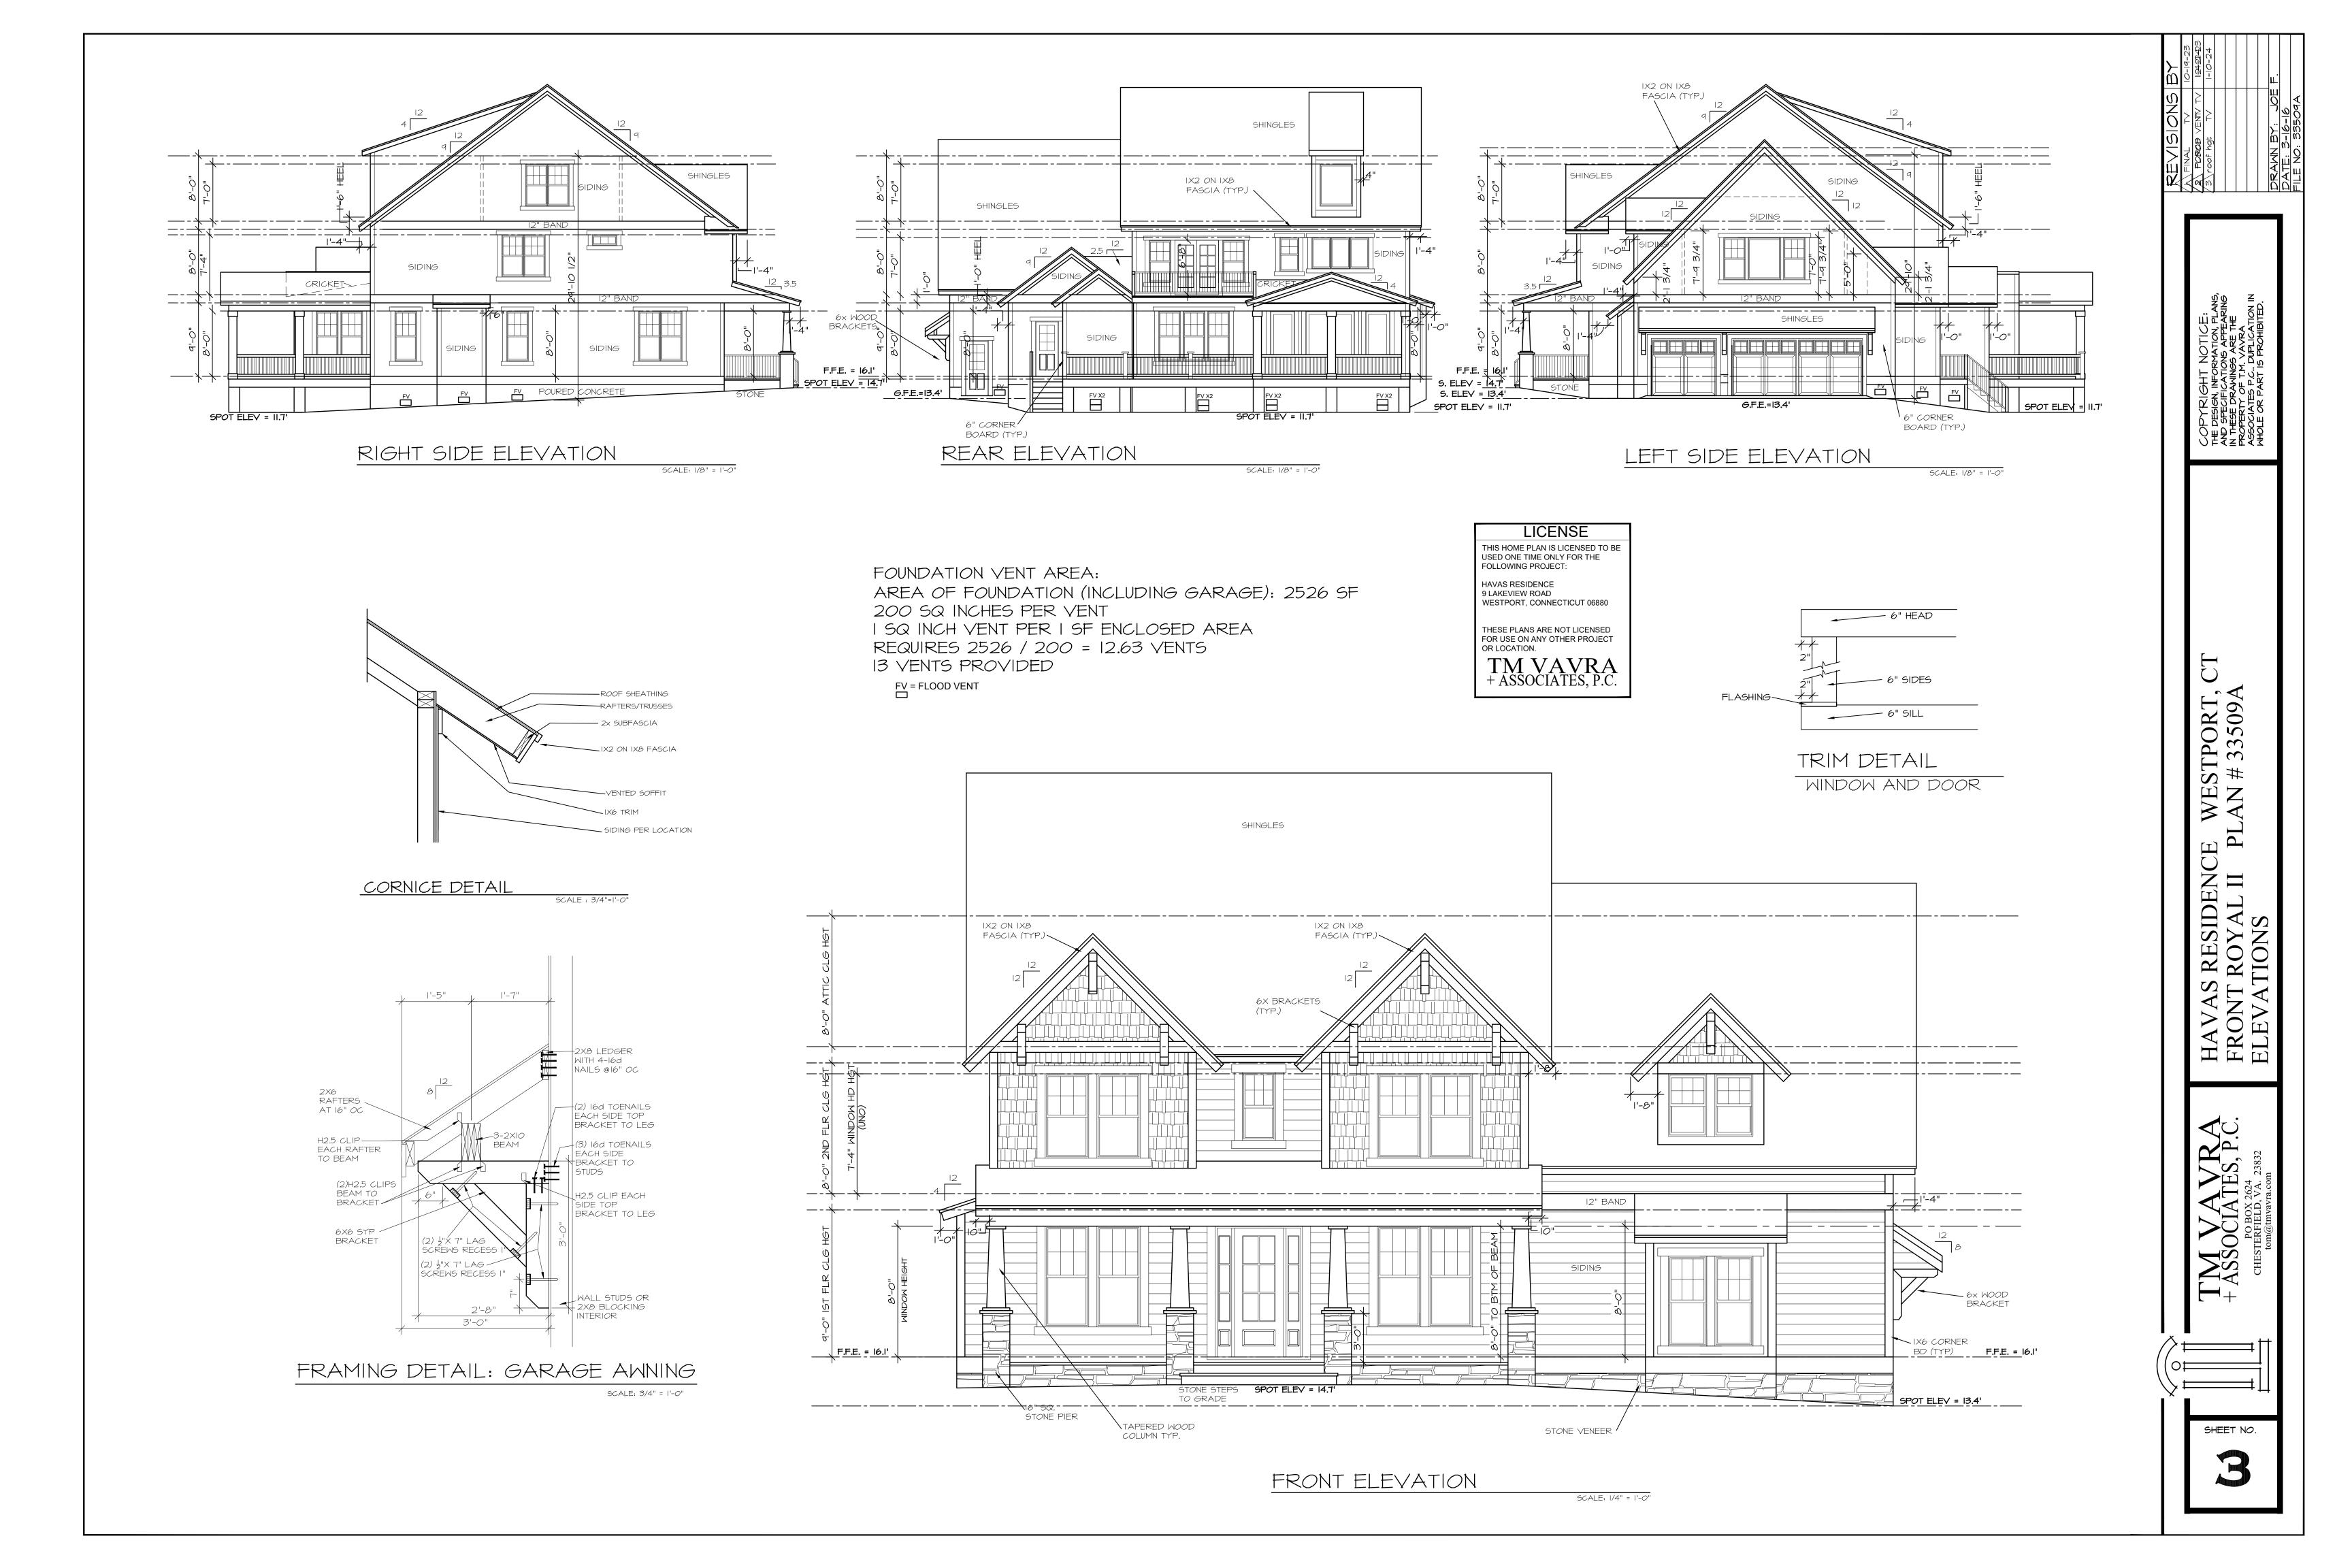

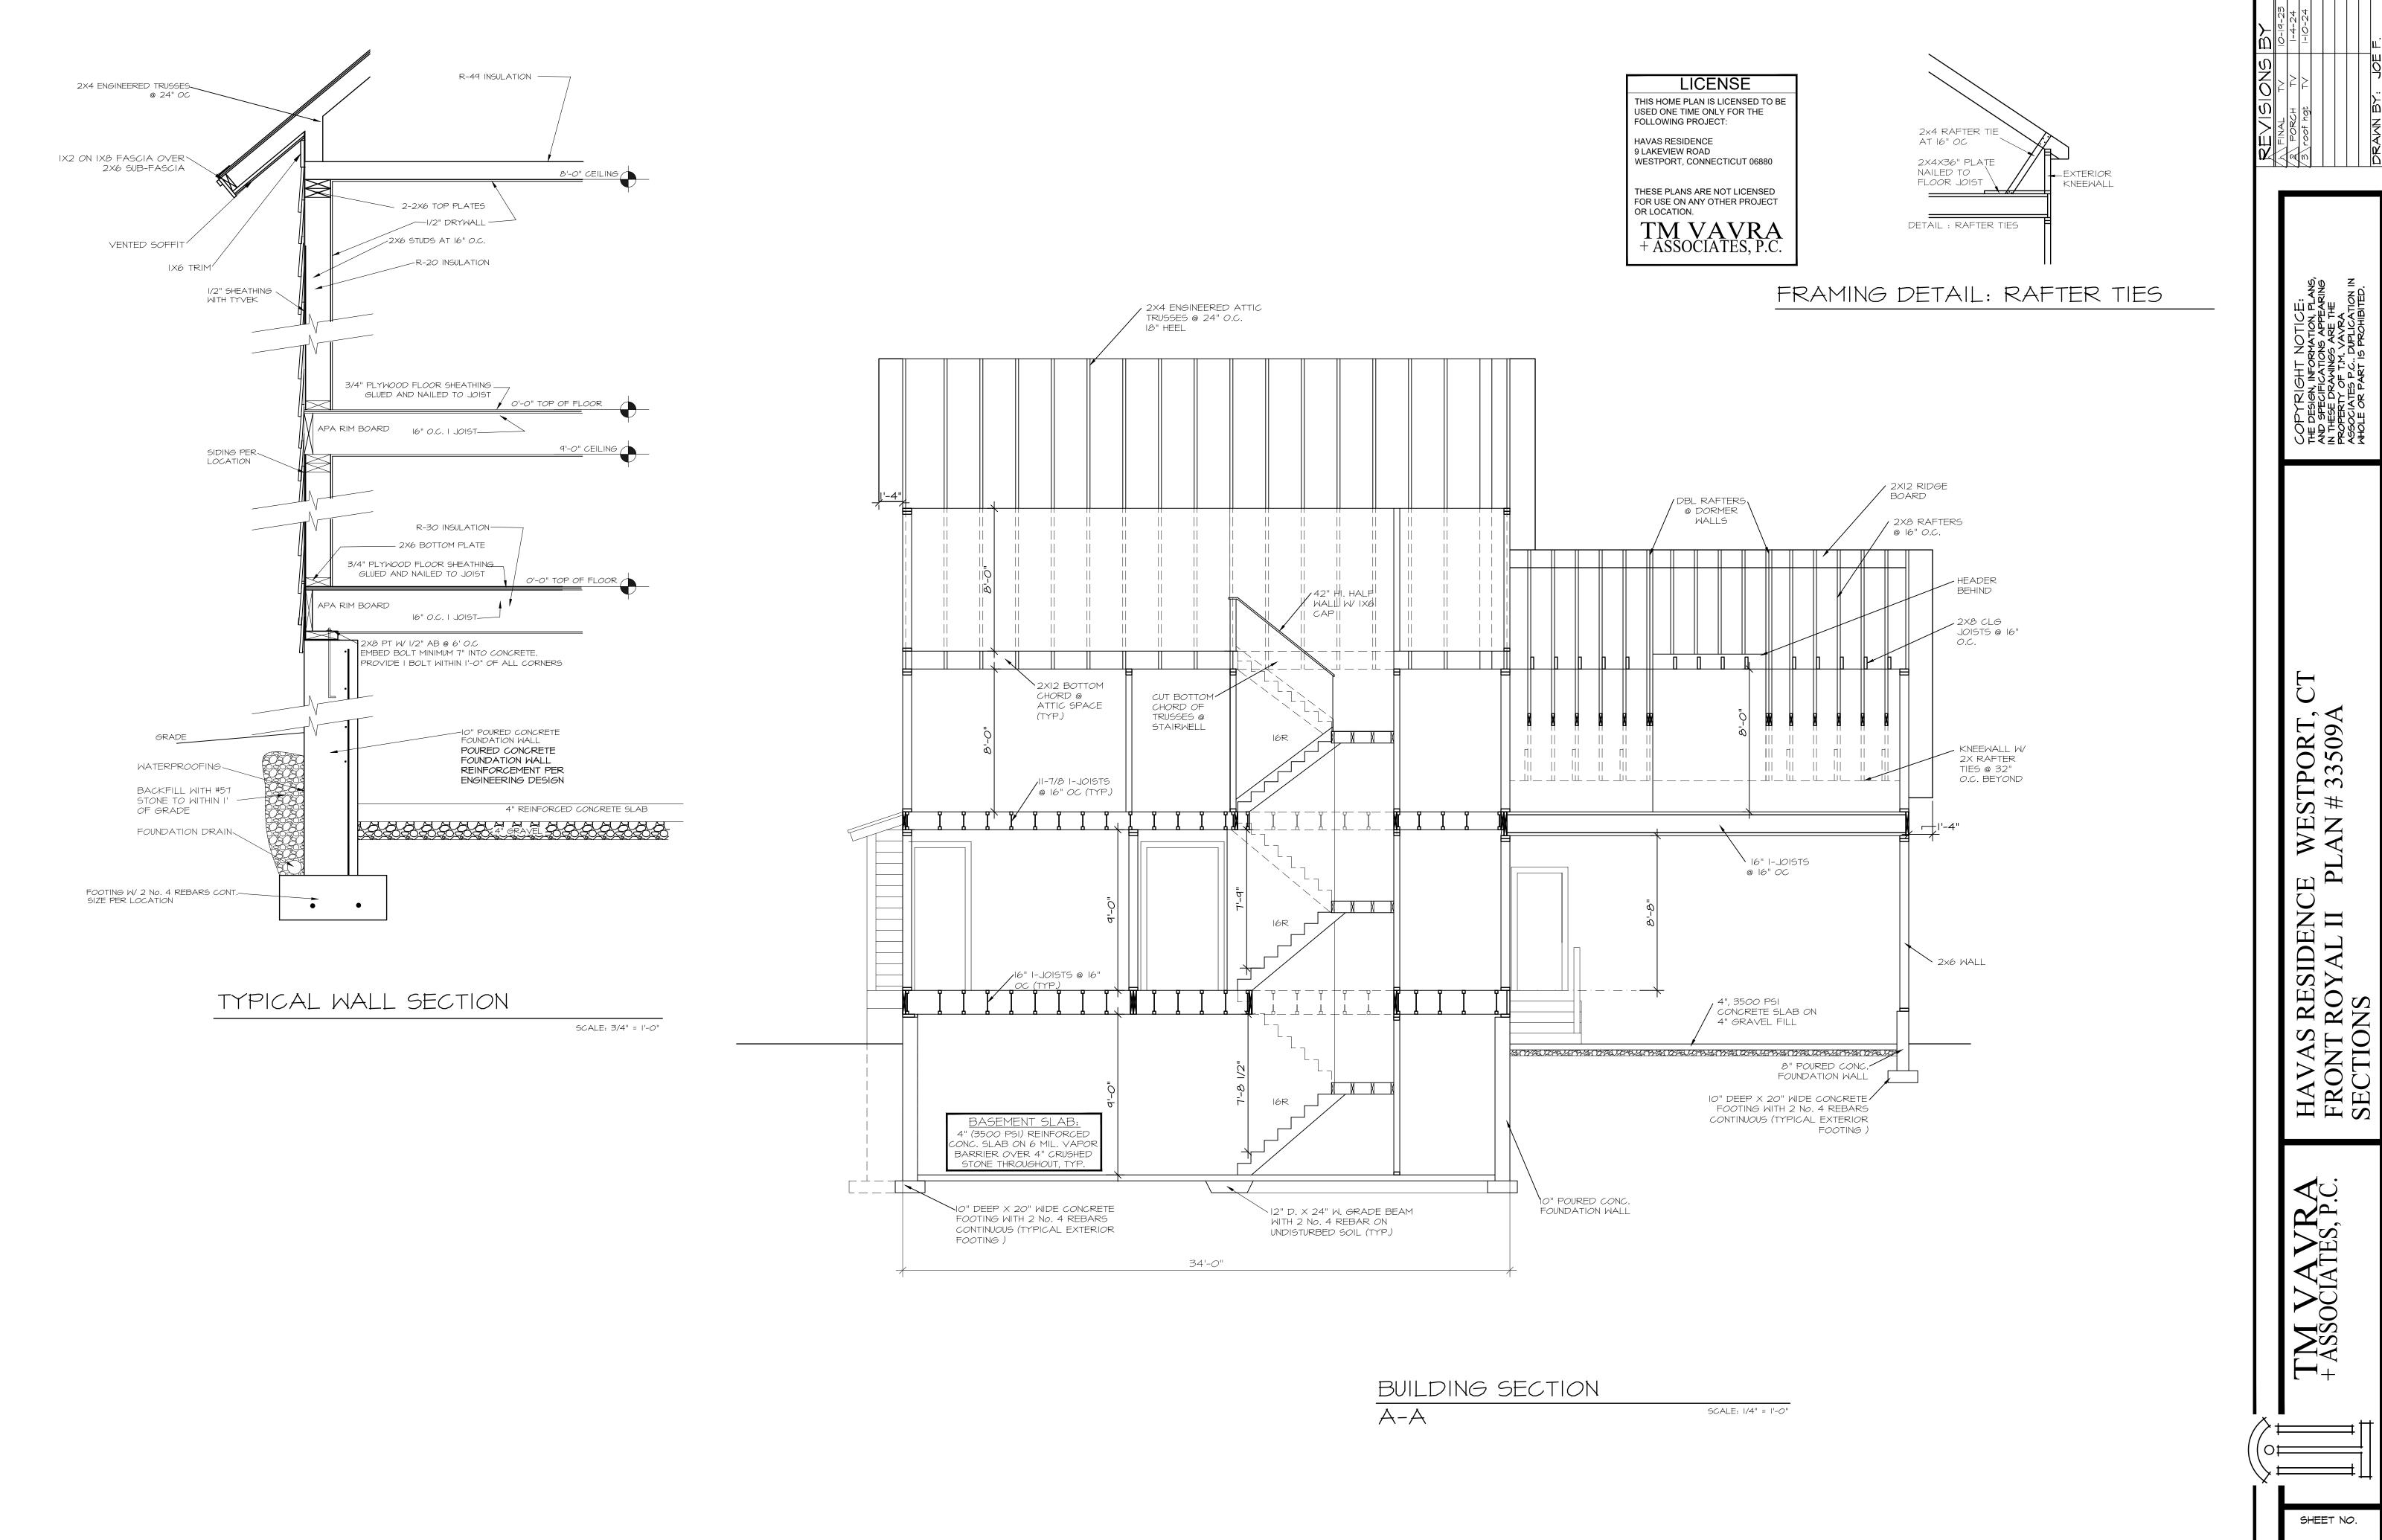

STPORT. # 33509 ROYAL II


SHEET NO.

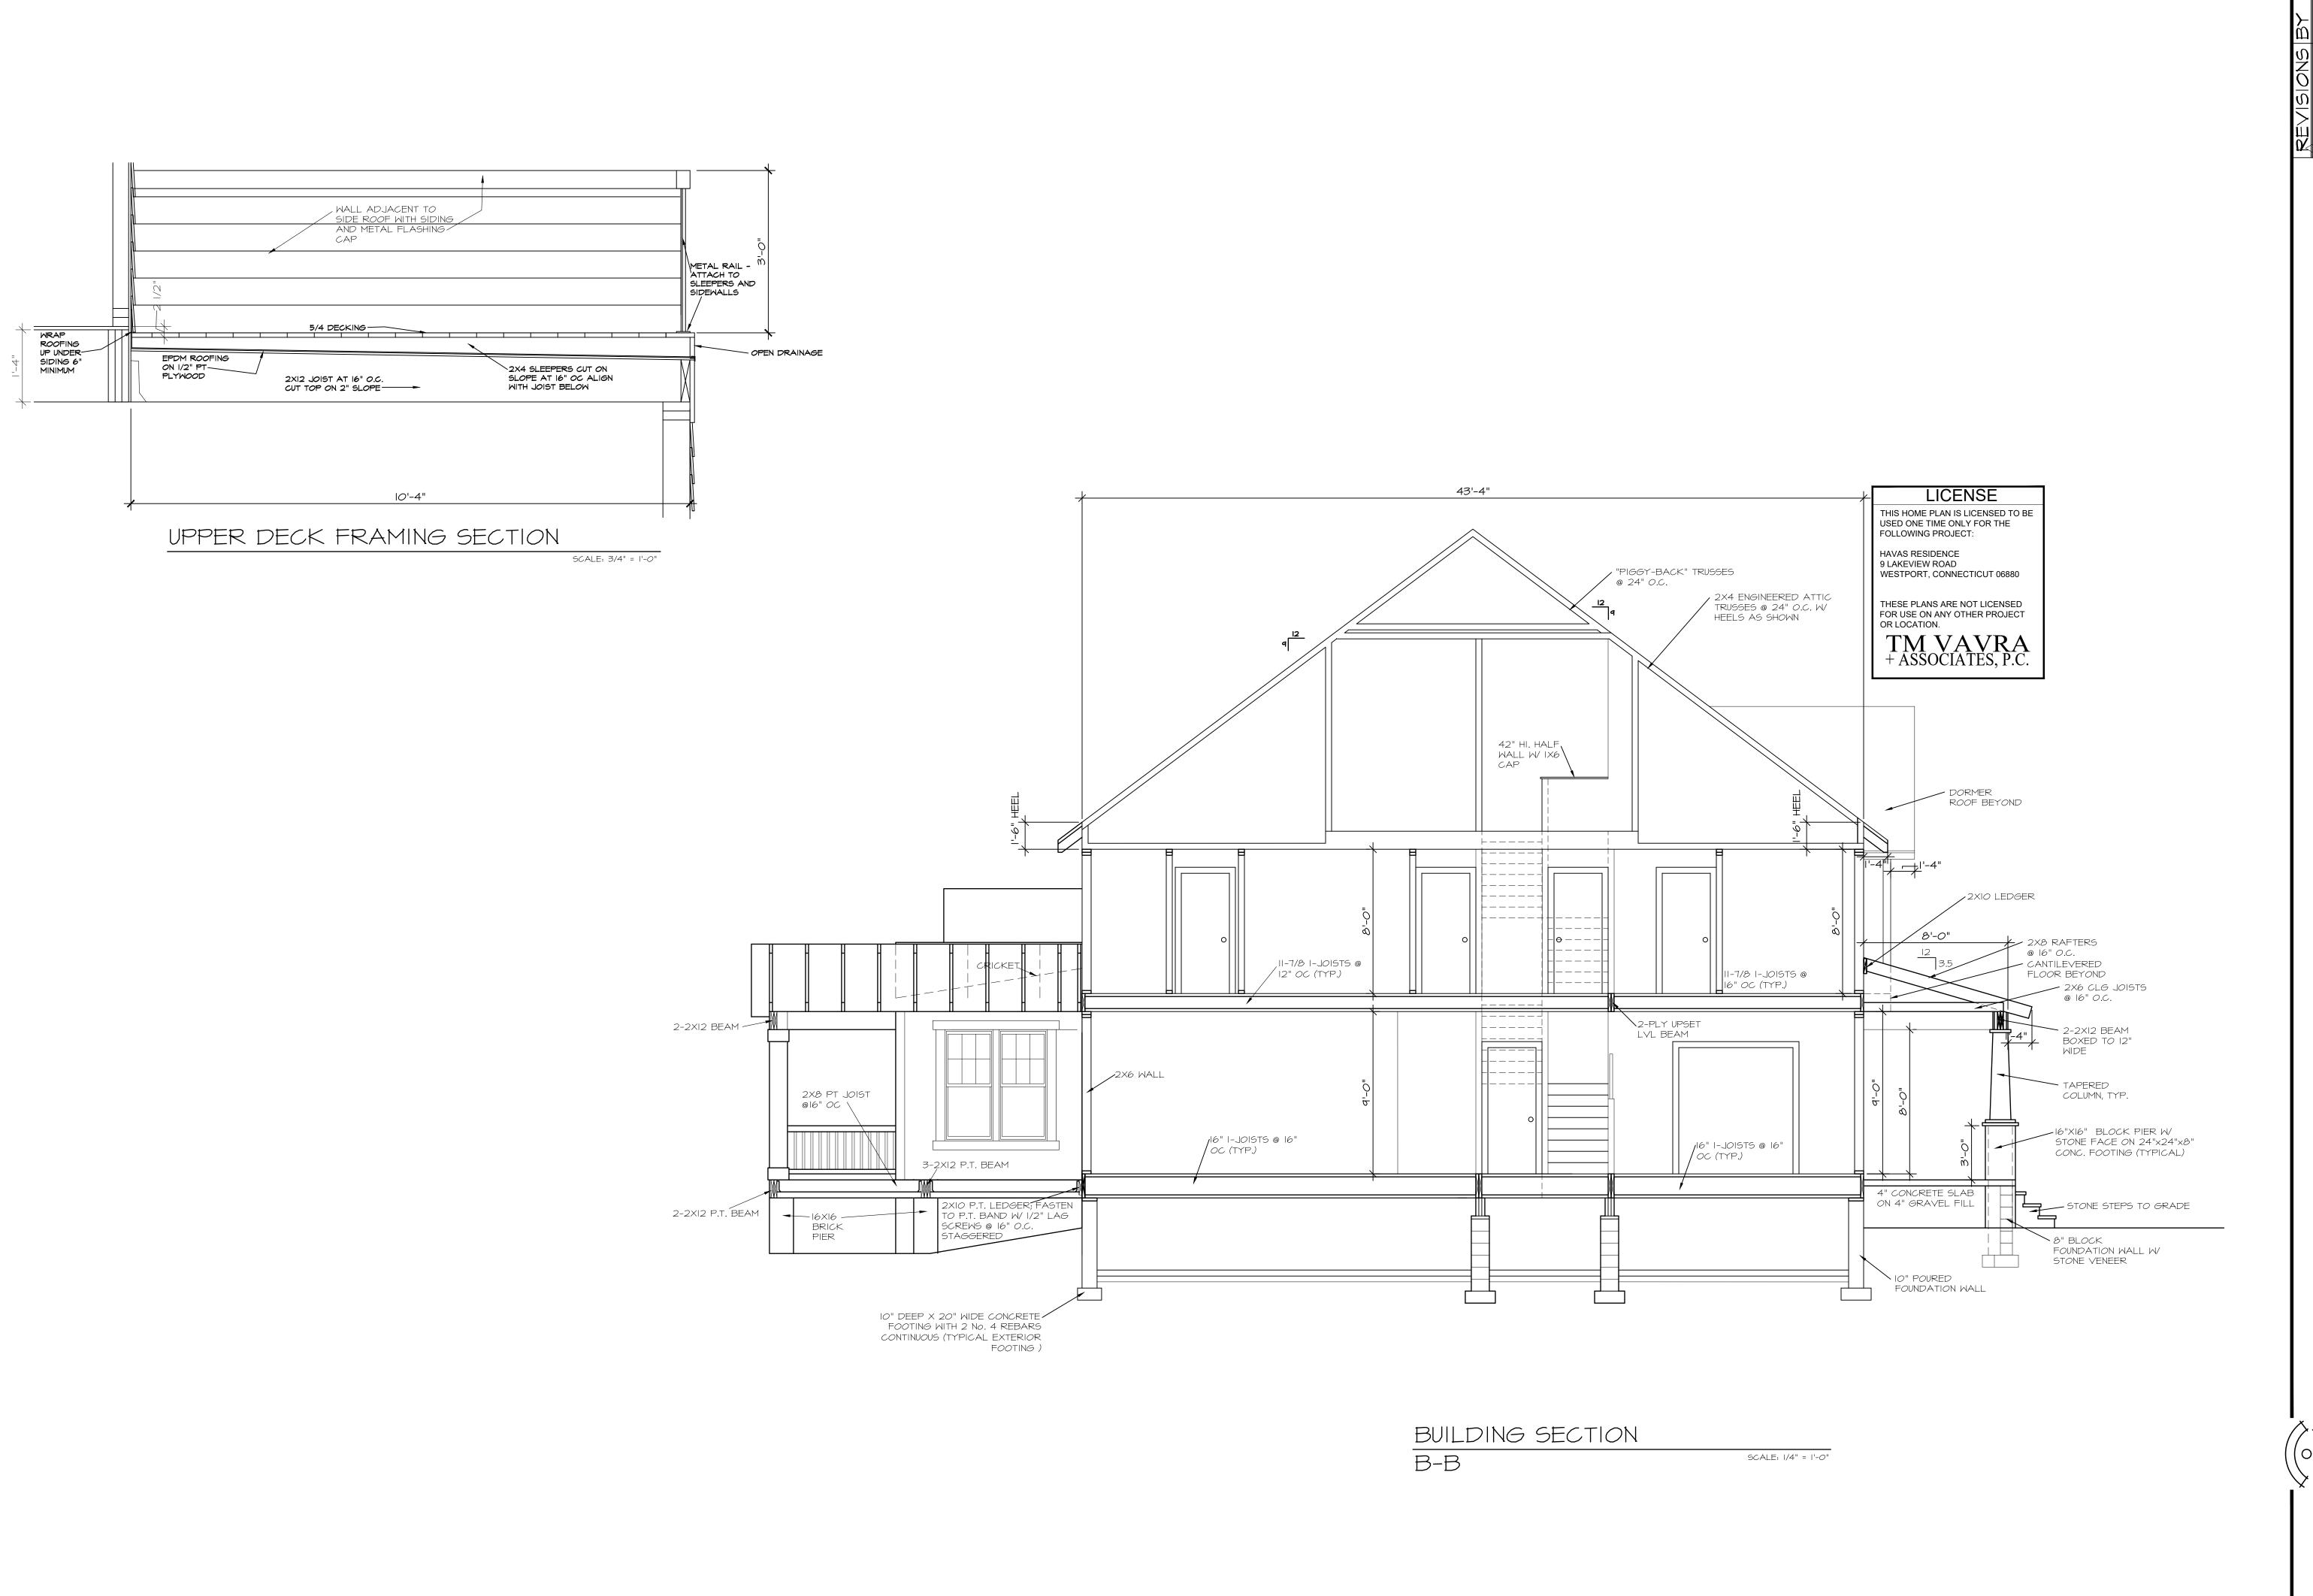

HAVAS RESIDENCE WESTPORT, CT FRONT ROYAL II PLAN # 33509A SECTIONS

M VAVRA SSOCIATES, P.C.

SHEET NO.

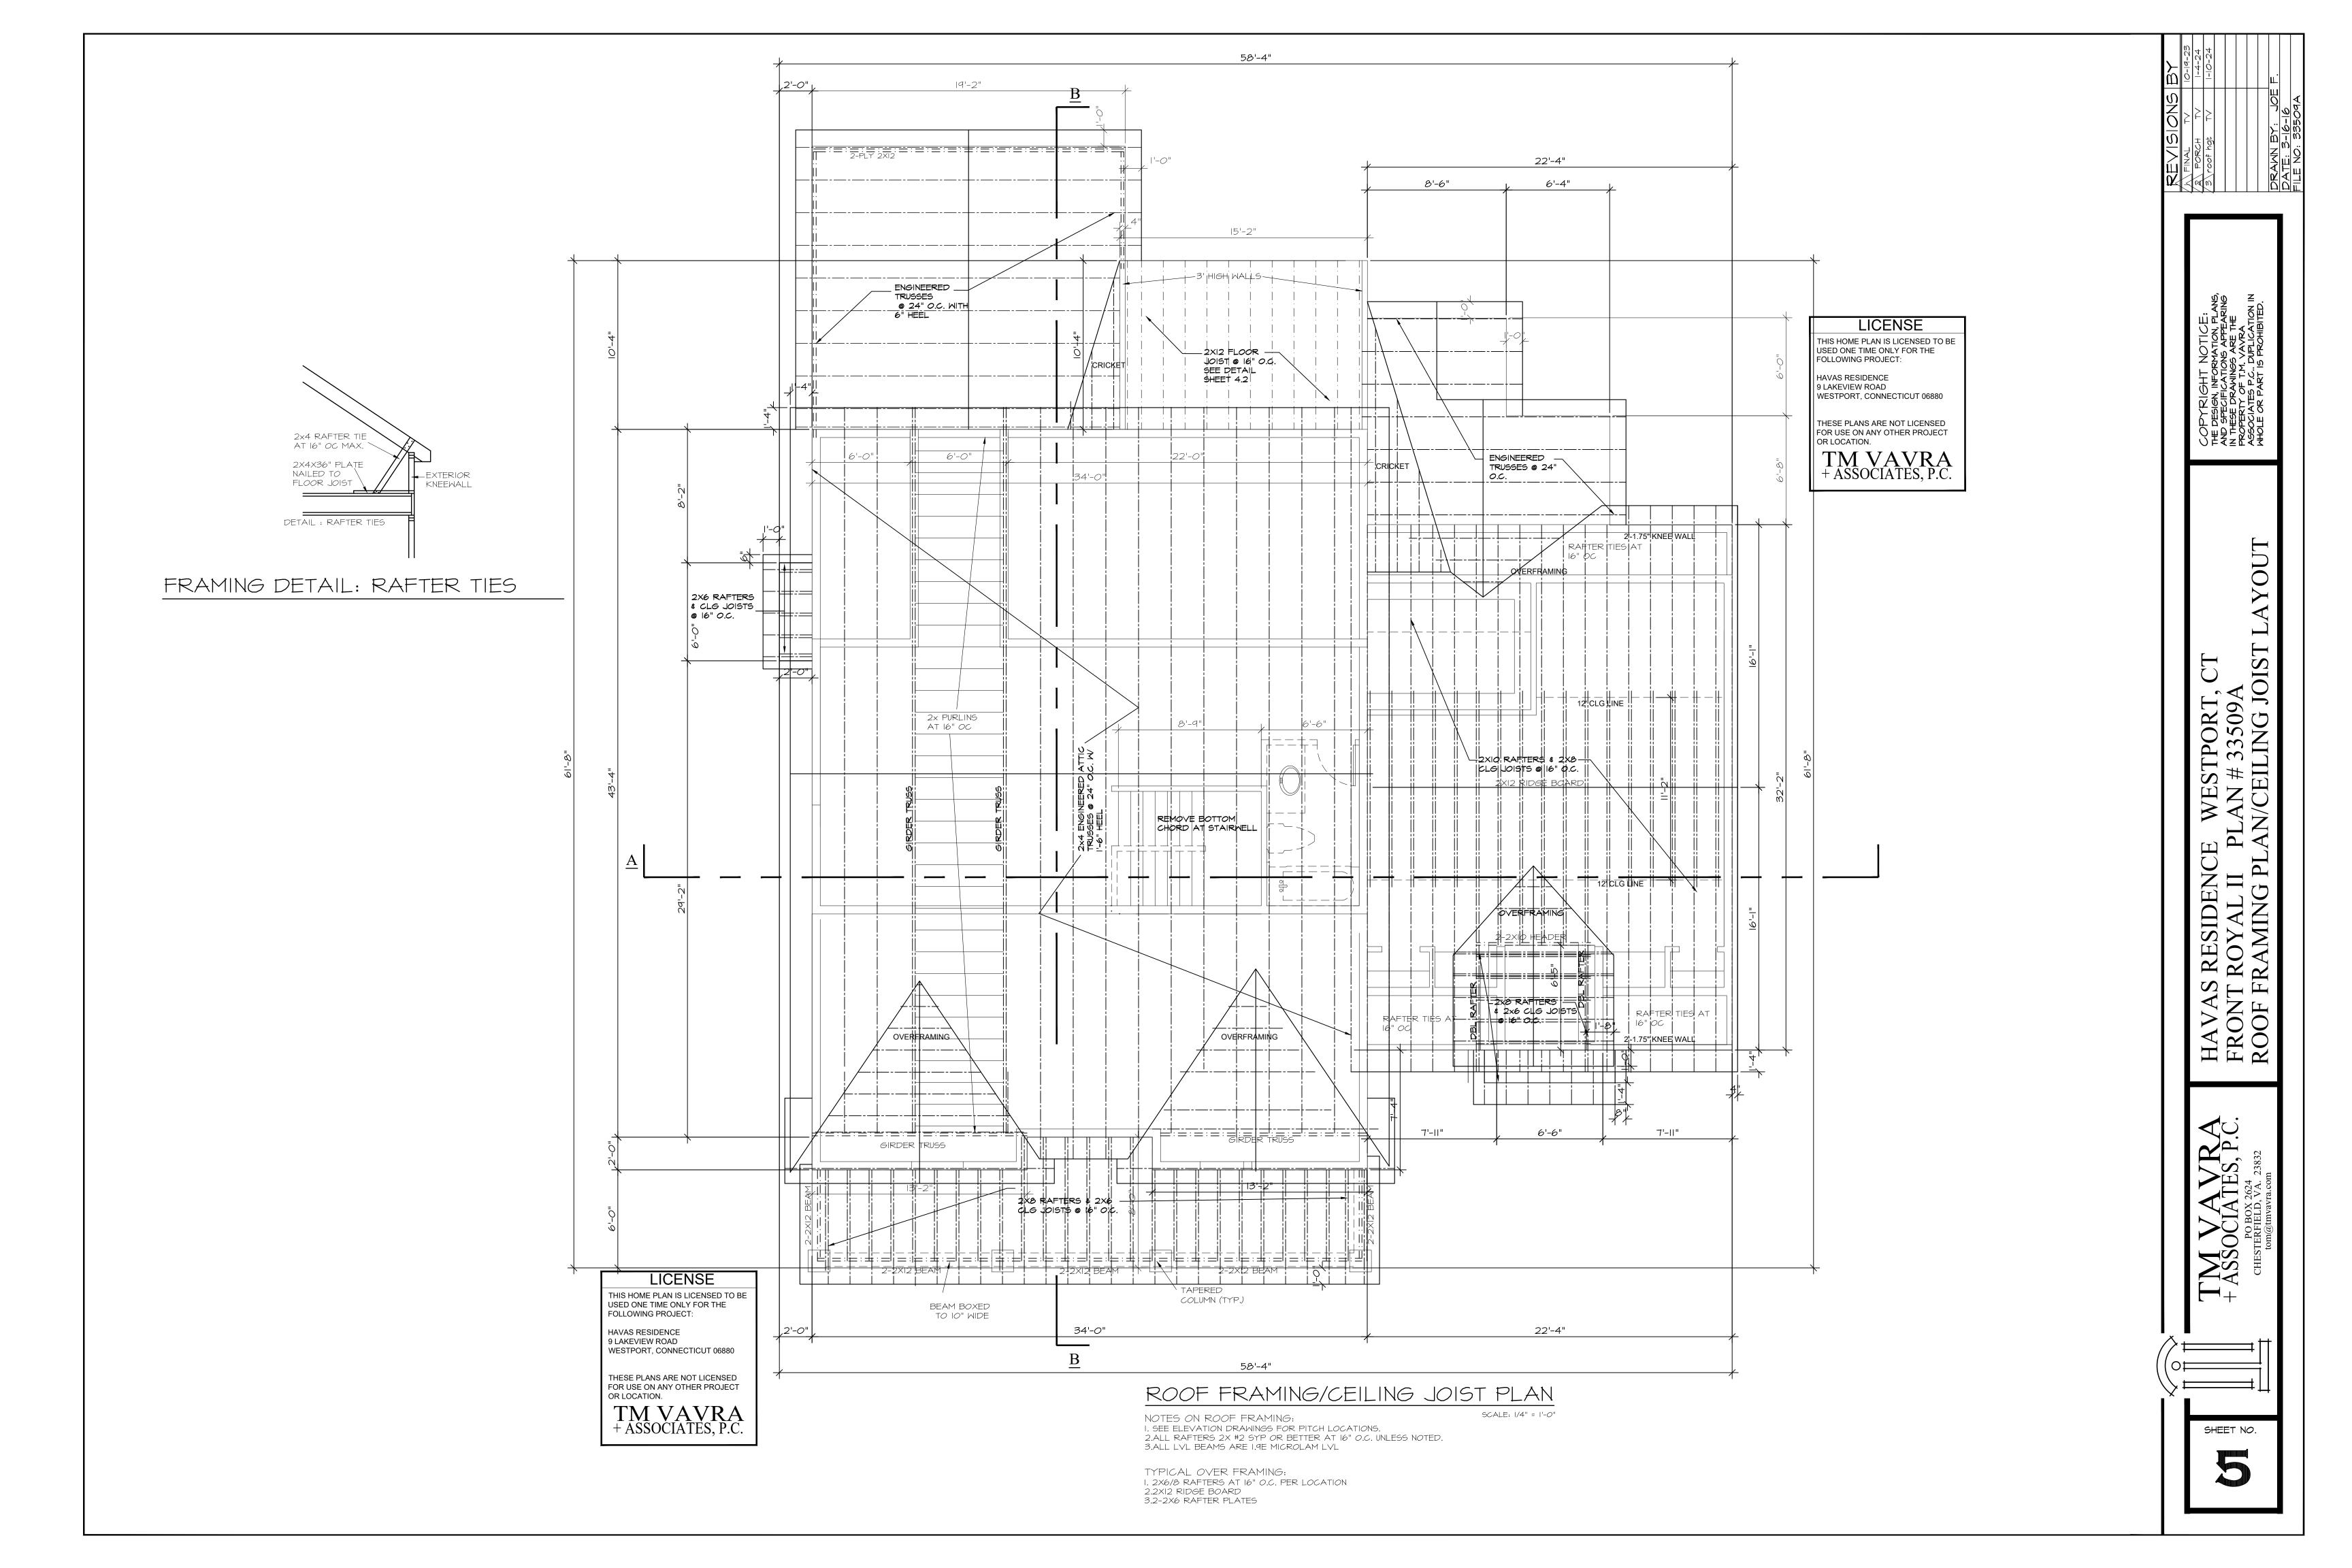

	ELECTRICAL LEGEND	
SYM	DESCRIPTION	
\$	SINGLE POLE SWITCH	
\$3	THREE WAY SWITCH	
\$4	FOUR WAY SWITCH	
<del>(</del>	DIMMER SWITCH	
\$ <sub>R</sub>	REOSTAT SWITCH (SPEED CONTROL)	
\$ <sub>DS</sub>	DOOR SWITCH	
$\wedge$	SURFACE MTD. LIGHT FIXTURE	
<del></del>	CEILING FAN	
$\Phi$	RECESSED LIGHT FIXTURE	
₩	EXHAUST FAN FIXTURE	
<del>-</del>	FLUORESCENT LIGHT FIXTURE	
ф	DUPLEX RECEPTACLE IIOV	
	DUPLEX CEILING OUTLET 110V	
	DUPLEX FLOOR OUTLET 110V	
	SWITCH WIRED DUPLEX RECEPT.	
	220V RECEPTACLE	
	FLOOD LIGHT WATER PROOF	
<u> </u>	JUNCTION BOX	
LAD	LOCATE AS DIRECTED BY OWNER	
MP	WATER PROOF	
	ELECTRIC METER	
<b>◄</b>	PHONE OUTLET	
<sup>→</sup> T.√.	CABLE T.Y. OUTLET	
	DOOR CHIME	
	UNDER CABINET LIGHTING	
_p_	PLUGMOLD 110V	
<del>ф</del>	WALL MOUNTED LIGHT FIXTURE	
	EXHAUST FAN/LIGHT FIXTURE	
	WP ELEC. DISCONNECT	
600	GARAGE DOOR OPENER	
<del>  4</del> 2"	DUPLEX RECEPTACLE, GROUND FAULT INDICATOR	
SD	SMOKE DETECTOR	

## GENERAL ELECTRICAL NOTES

- I) ALL ELECTRICAL WORK SHALL CONFORM TO ALL LOCAL, STATE, AND FEDERAL CODES INCLUDING THE CURRENT EDITION OF THE STANDARD ELECTRICAL CODE
- 2) PROVIDE ELEC./BATTERY BACK-UP SMOKE DETECTORS. LOCATE AS DIRECTED BY LOCAL ELECTRICAL CODE & NATIONAL ELECTRICAL CODE.
- 3) ELECTRICAL CONTRACTOR TO CONFORM TO LOCAL PHONE SERVICE PROVIDER REQUIREMENTS FOR TELEPHONE EQUIPMENT INSTALLATION.
- 4) ALL OPENINGS REQUIRED BY ELECTRICAL CONTRACTOR TO BE CLOSED TO MATCH FINISH AND FIRE RATED BY ELECTRICAL CONTRACTOR.
- 5) ALL OUTLET BOXES FOR RECEPTACLES, TV ANTENNAS, OR TELEPHONE JACKS IN RATED WALLS
- 6) ALL BATHROOM AND KITCHEN OUTLETS TO BE G.F.I. TYPE.
- 7) ELECTRICAL CONTRACTOR TO VERIFY ALL HVAC UNIT CONNECTIONS WITH HVAC CONTRACTOR PRIOR TO INSTALLATION.

LICENSE THIS HOME PLAN IS LICENSED TO BE

USED ONE TIME ONLY FOR THE

WESTPORT, CONNECTICUT 06880

THESE PLANS ARE NOT LICENSED FOR USE ON ANY OTHER PROJECT OR LOCATION.

FOLLOWING PROJECT:


HAVAS RESIDENCE

- 8) ALL METERS, METER CENTERS AND DISCONNECTS TO BE APPROVED BY LOCAL POWER COMPANY.
- 9) CO-ORDINATE ALL CONDUIT RUNS AND EQUIPMENT INSTALLATION WITH OTHER TRADES TO AVOID CONFLICTS PRIOR TO FABRICATION, INSTALLATION AND ERECTION.
- 10) PROVIDE ELECTRICITY TO ALL EQUIPMENT, FIXTURES, ETC. NOT SPECIFICALLY NOTED OR SHOWN.

MUST BE METAL OR U.L. RATED FOR USE IN ONE HOUR CONSTRUCTION.

- ||) INSTALLATION HEIGHTS ABOVE FINISH FLOOR UNLESS OTHERWISE NOTED:
  - WALL HUNG TELEPHONE 56" A.F.F. TELEPHONE JACKS 18" A.F.F. LIGHT SWITCHES RECEPTACLES 18" A.F.F.

TELEVISION JACKS 18" A.F.F.

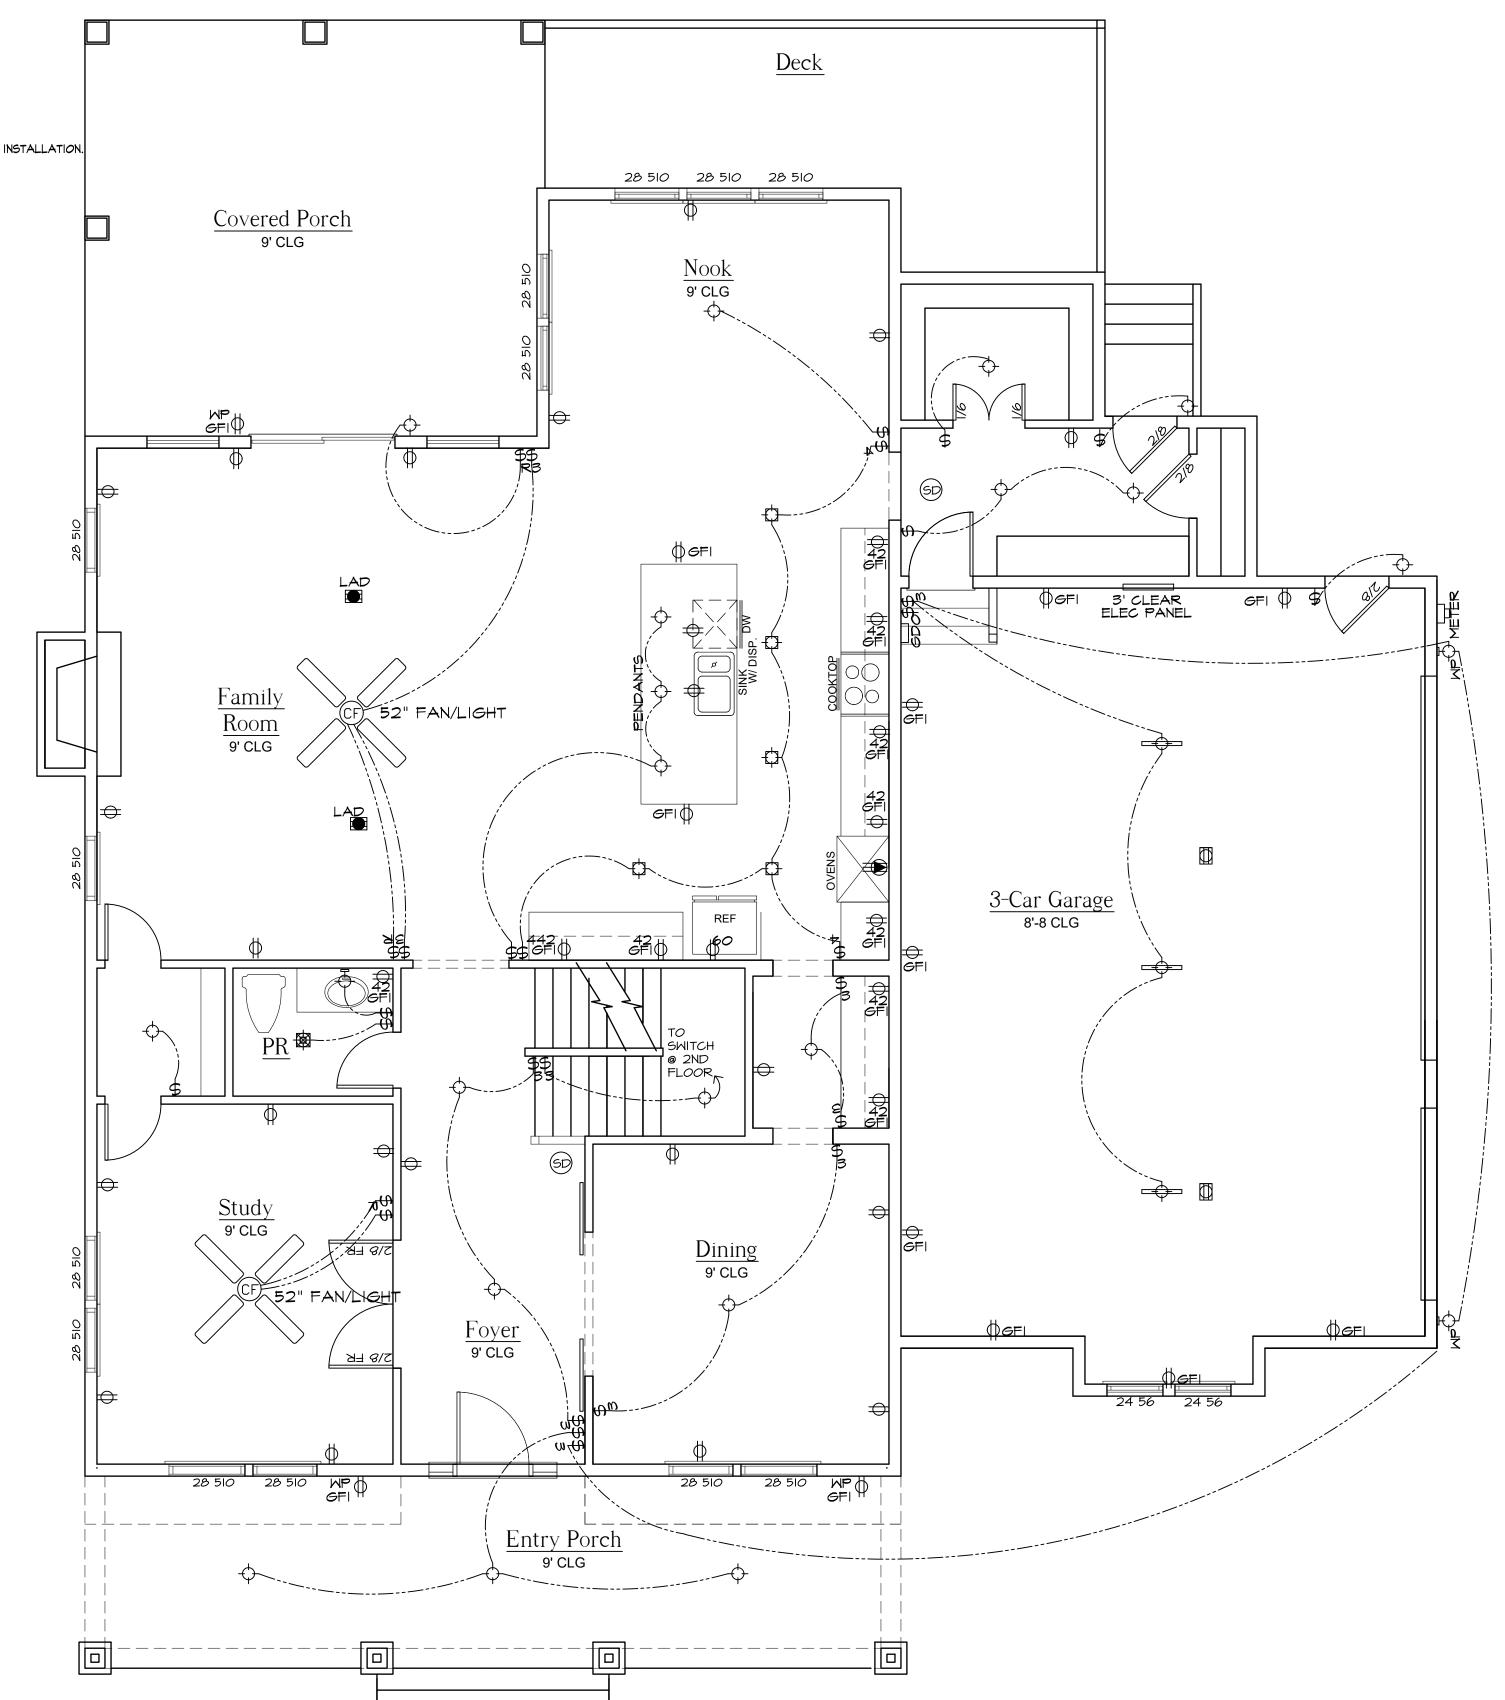

FIRST FLOOR ELECTRICAL PLAN

SCALE: 1/4" = 1'-0"

LICENSE

THIS HOME PLAN IS LICENSED TO BE USED ONE TIME ONLY FOR THE

WESTPORT, CONNECTICUT 06880

THESE PLANS ARE NOT LICENSED

FOR USE ON ANY OTHER PROJECT

TM VAVRA + ASSOCIATES, P.C.

FOLLOWING PROJECT:

HAVAS RESIDENCE 9 LAKEVIEW ROAD

OR LOCATION.

SHEET NO.


6.

	ELECTRICAL LEGEND
SYM	DESCRIPTION
\$	SINGLE POLE SWITCH
\$3	THREE WAY SWITCH
\$4	FOUR WAY SWITCH
\$0	DIMMER SWITCH
\$ <sub>R</sub>	REOSTAT SWITCH (SPEED CONTROL)
\$ <sub>DS</sub>	DOOR SMITCH
$\Diamond$	SURFACE MTD. LIGHT FIXTURE
<b>X</b> 27 741	CEILING FAN
ф	RECESSED LIGHT FIXTURE
₩	EXHAUST FAN FIXTURE
$\rightarrow$	FLUORESCENT LIGHT FIXTURE
ф	DUPLEX RECEPTACLE IIOV
	DUPLEX CEILING OUTLET IIOV
	DUPLEX FLOOR OUTLET 110V
•	SWITCH WIRED DUPLEX RECEPT.
	220V RECEPTACLE
	FLOOD LIGHT WATER PROOF
	JUNCTION BOX
LAD	LOCATE AS DIRECTED BY OWNER
WP	WATER PROOF
	ELECTRIC METER
<b>◄</b>	PHONE OUTLET
<b>→</b> T. <b>∨</b> .	CABLE T.V. OUTLET
	DOOR CHIME
	UNDER CABINET LIGHTING
—P—	PLUGMOLD IIOV
фı	WALL MOUNTED LIGHT FIXTURE
	EXHAUST FAN/LIGHT FIXTURE
	WP ELEC. DISCONNECT
600	GARAGE DOOR OPENER
SFI-42"	DUPLEX RECEPTACLE, GROUND FAULT INDICATOR
(SD)	SMOKE DETECTOR

## GENERAL ELECTRICAL NOTES

- ALL ELECTRICAL WORK SHALL CONFORM TO ALL LOCAL, STATE, AND FEDERAL CODES INCLUDING THE CURRENT EDITION OF THE STANDARD ELECTRICAL CODE
- 2) PROVIDE ELEC./BATTERY BACK-UP SMOKE DETECTORS. LOCATE AS DIRECTED BY LOCAL ELECTRICAL CODE & NATIONAL ELECTRICAL CODE.
- 3) ELECTRICAL CONTRACTOR TO CONFORM TO LOCAL PHONE SERVICE PROVIDER REQUIREMENTS FOR TELEPHONE EQUIPMENT INSTALLATION.
- 4) ALL OPENINGS REQUIRED BY ELECTRICAL CONTRACTOR TO BE CLOSED TO MATCH FINISH AND FIRE RATED BY ELECTRICAL CONTRACTOR.
- 5) ALL OUTLET BOXES FOR RECEPTACLES, TV ANTENNAS, OR TELEPHONE JACKS IN RATED WALLS MUST BE METAL OR U.L. RATED FOR USE IN ONE HOUR CONSTRUCTION.
- 6) ALL BATHROOM AND KITCHEN OUTLETS TO BE G.F.I. TYPE.
- 7) ELECTRICAL CONTRACTOR TO VERIFY ALL HVAC UNIT CONNECTIONS WITH HVAC CONTRACTOR PRIOR TO INSTALLATION.
- 8) ALL METERS, METER CENTERS AND DISCONNECTS TO BE APPROVED BY LOCAL POWER COMPANY.
- 9) CO-ORDINATE ALL CONDUIT RUNS AND EQUIPMENT INSTALLATION WITH OTHER TRADES TO AVOID CONFLICTS PRIOR TO FABRICATION, INSTALLATION AND ERECTION.
- (O) PROVIDE ELECTRICITY TO ALL EQUIPMENT, FIXTURES, ETC. NOT SPECIFICALLY NOTED OR SHOWN.
- ||) INSTALLATION HEIGHTS ABOVE FINISH FLOOR UNLESS OTHERWISE NOTED:


WALL HUNG TELEPHONE 56" A.F.F.
TELEPHONE JACKS 18" A.F.F.
LIGHT SWITCHES 48" A.F.F.
RECEPTACLES 18" A.F.F.
TELEVISION JACKS 18" A.F.F.

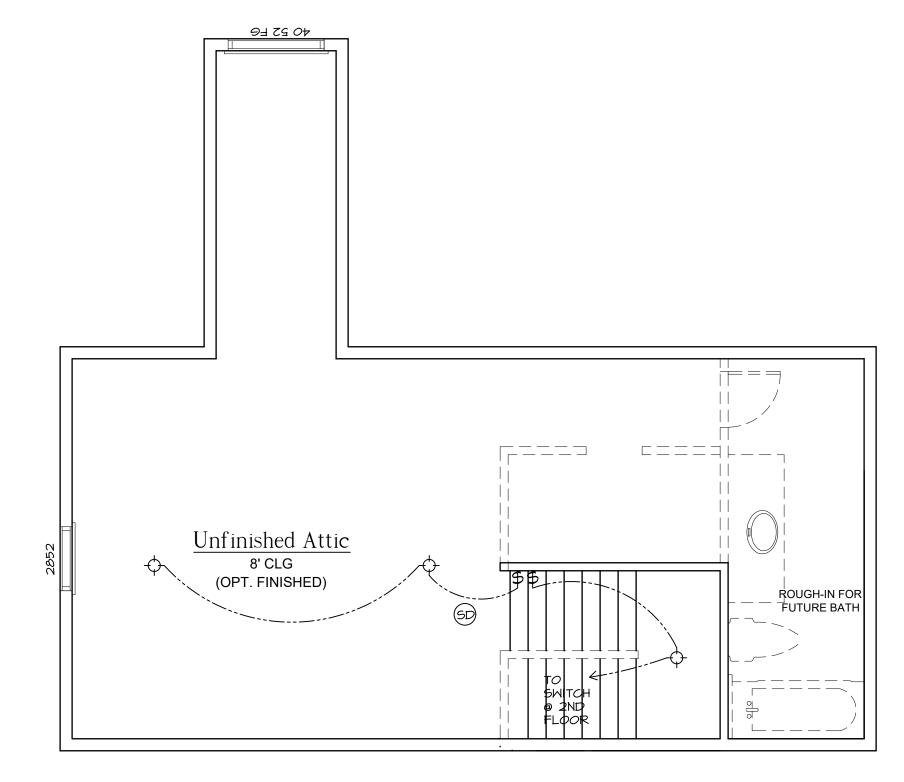



OPT. ATTIC ELECTRICAL PLAN

SCALE: 1/4" = 1'-0"

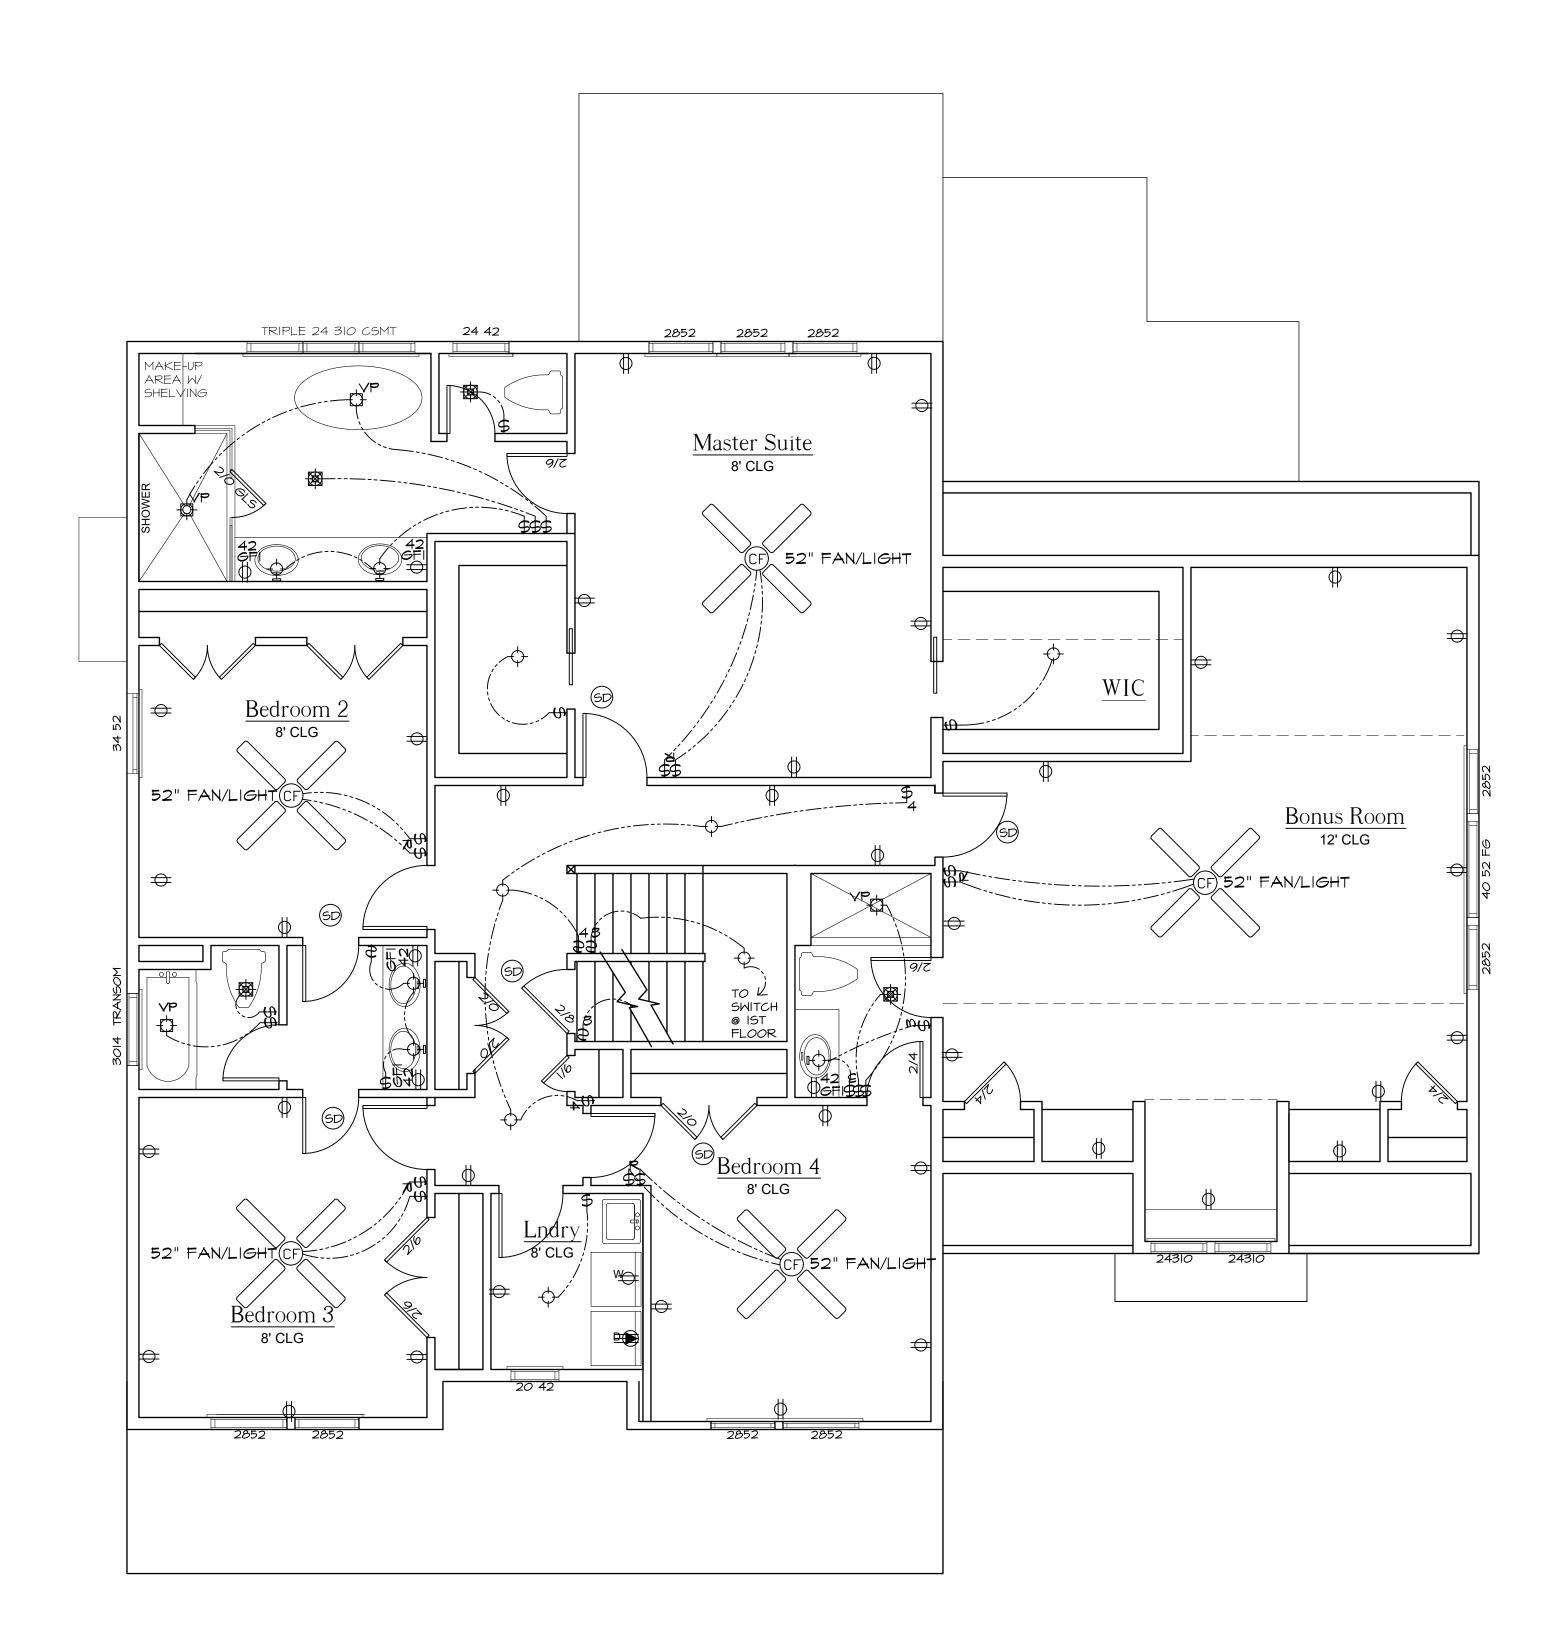

SECOND FLOOR ELECTRICAL PLAN

SCALE: 1/4" = 1'-0"

COPT RIGHT NOTICE:
THE DESIGN, INFORMATION, PLANS,
AND SPECIFICATIONS APPEARING
IN THESE DRAWINGS ARE THE
PROPERTY OF T.M. VAVRA
ASSOCIATES P.C., DUPLICATION IN
WHOLE OR PART IS PROHIBITED.

HAVAS RESIDENCE WESTPORT, CT FRONT ROYAL II PLAN # 33509A SECOND FLOOR & OPT ATTIC ELECTRICAL

SHEET NO.