Village District Overlay (VDO) Zone Westport Center §36;

The purpose of this Village District Overlay (VDO) is to protect the distinctive character, landscape, and historic structures and development pattern within this Village District while encouraging a mixed use, walkable district that is attractive to residents, employees, and visitors. New construction or substantial rehabilitation in the Village District should be compatible with the existing character of the district and reinforce both the existing development patterns and connections to the Saugatuck River. (See copy of Westport Regulations §36-2 attached 9pgs)

JOINT COMMITTEE REVIEW and RECOMMENDATION

PROPERTY ADDRESS:	Parker Harding Plaza, Westport, C	T 06880
OWNER OF RECORD: _	Town of Westport	Daytime Tel #: 203 341 1120
OWNER'S ADDRESS: _	110 Myrtle Avenue, Westport, CT (06880E-mail:_pratkiewich@westportct.gov
APPLICANT'S NAME (if of the applicant is unable to obtain APPLICANT'S ADDRESS	440 M. H. A OT	tion signed by the property owner with this application, as per §43-3.3.
Property Owner's S	Signature I	Legal Representative Signature (As authorized by owner)
□ Joint Committee Review a □ Compliance Alternative for the design principles but is □ Site Plan Approval by the formulate of the design principles but is □ Site Plan Approval by the formulation to Joint Committee of the plan Approval by the formulation complete of the plan Approv	Planning and Zoning Commission Review and Recommendation Meeting, plant and the following required materials to Historice, describing the project, including construction to style or how the improvements vary, a ration of the Historic Resources Inventory Form if the of Site Plan (11" x 17"). To find Existing Style of the Building and so of scaled Building Plans, including Existing Cottens of the project of the original Building ete sets of photos showing the original Building	ease submit the following: (Call for Meeting dates) ic District Commission Office, Room108 203-341-1184. In details, proposed materials and how the improvements are male of why the variation should be, approved under Sec 36-2.2.
	the Proposed Building within context of its sun other material deemed appropriate by applica-	rroundings. ant to enable the Joint Committee to evaluate the design.
	onic Version of ALL your submitted materials to	
Joint Committee Recom	mendations to P&Z Commission are;	

Date:

Joint Committee Chair's Signature:

Parker Harding Redevelopment Narrative

The Public Works Department is proposing to redevelop Parker Harding Plaza through our "Reconnect the Riverfront" initiative. In its present state, there are many deficiencies that we are proposing to address, including but not limited to the following:

ADA Compliance

Fire Code/Fire Access

Pedestrian safety and visibility

Poor circulation and traffic flow

Lack of any flood mitigation

Lack of any sustainability measures

Limited Landscaping and green space

Substandard parking and travel lane dimensions for most of the parking spaces

And most importantly, very limited Riverfront access for residents and visitors alike, instead giving priority to vehicles, parking, and roadway.

The site sits fully within the Village District Overlay, (VDO), zone and as such must meet the VDO standards. It is the intent to address all of the above deficiencies as well as to comply with the VDO Design Principles and Design Standards.

There are no buildings being modified under this project so our compliance speaks mainly to pavers, pavement treatment, parking, landscaping, lighting, rain gardens, and waterfront treatments.

<u>Pavers:</u> The project proposes to utilize the Westport standard Whitaker-Greer brick pavers that have been utilized throughout the downtown area, along building frontages and in walkways leading from the buildings to the waterfront.

Pavement treatment: Where the walkways transition to decorative crosswalks crossing the parking area or roadways, the crosswalks will utilize the stamped thermoplastic inlay material that we have used on crosswalks on Main Street and Elm Street. The material is called TrafficScape, made by Ennis-Flint of Thomasville, NC. The color is "Sienna" and is consistent with the color of the above-mentioned Whitaker-Greer brick The use of this material is specifically indicated as its coefficient of thermal expansion is similar to that of asphalt, so that cracking in the underlying pavement due to differential expansion or contraction will not occur, making it more sustainable over the long term. The material is extremely durable, lasting approximately 10 years or more under traffic conditions.

The rest of the paved parking areas will be conventional asphalt pavement.

<u>Parking:</u> The main parking lot is proposed to be modified from the existing conditions by creating a consistent 25-foot wide, two-way access lane between two rows of perpendicular parking. All ADA requirements and fire code requirements are met or exceeded. The parking area is separated from the

Parker Harding Redevelopment Narrative

one-way cut through road by a landscaped buffer. Pedestrian bump outs are also landscaped at the pedestrian crossings.

<u>Landscaping</u>: Landscaping will utilize native plants and trees throughout the project and will integrate plantings into the various rain gardens along the waterfront. A planting schedule is provided. Plantings in the rain gardens and along the waterfront will be salt-tolerant to be sustainable and recoverable after flood events. Plantings and landscaping will be utilized to define and separate the parking area, cutthrough road, and waterfront area.

Local artwork will also be placed throughout the waterfront area and rotated periodically for variety. We will work with the Westport Arts Council to provide appropriate spaces for different varieties of art compatible with the outdoor environment.

<u>Lighting:</u> The primary lighting along paved sidewalks will utilize the Lumec L80 lighting heads that are used through out Main St and the downtown area. At waterfront landings a combination of Arne Catenary fixtures and MP LO1 in-sidewalk up lights will add some variety and enhancement to the landing areas where the pedestrian walkways meet the waterfront.

<u>Rain Gardens:</u> Rain Gardens are utilized between the green space adjacent to the boardwalk and the cut-through road to separate the two. These will also provide an opportunity for infiltration of storm water and biotreatment of stormwater. In addition to plantings the rain garden will be lined with inlaid stone as well as random hand placed protruding stones.


<u>Waterfront Treatments</u>: Along the waterfront three new treatments will be introduced that will differentiate the waterfront from the parking area and roadway, but also compliment the surface treatments specified in the Design Standards. Exposed aggregate concrete will be used to transition from the concrete sidewalks that exist both North and South of the plaza, to an Ipe boardwalk that will be the main feature along the waterfront. The boardwalk will vary in width but will be no less than 13 feet wide to provide enough room for several groups of people to comfortably pass each other in both directions. Along the water side of the Boardwalk will be a 42-inch cable rail fence with an Ipe cap. The cap will be angled at 15 degrees to prevent it from becoming a drink rail, and to provide an opportunity for some interpretive placards along the walk.

We feel that the proposed plan meets or exceeds compliance with section 36-2.3.4 of the VDO regulations, and request that the Joint committee of the ARB-HDC give a positive recommendation to the Planning and Zoning Commission for the project overall.

RECONNECTING THE RIVERFRONT: PARKER HARDING PLAZA VILLAGE DISTRICT OVERLAY ZONE SUBMISSION PACKAGE

PARKER HARDING PLAZA TOWN OF WESTPORT, FAIRFIELD COUNTY, CONNECTICUT

SHEET NUMBER	DRAWING TITLE	DATE	LAST REVISED
CS001	SITE COVER SHEET	09/14/2023	LAGI KLVIOLD
VL101-VL102	PROPERTY & TOPOGRAPHIC SURVEY	12/06/2022	
CS002	MASTER LEGEND & NOTES	09/14/2023	
CS1002	OVERALL SITE PLAN	09/14/2023	
CS100 CS101	SITE PLAN I	09/14/2023	_
		09/14/2023	_
CS102	SITE PLAN II	· · ·	
CS501	SITE DETAILS I	09/14/2023	_
CS502	SITE DETAILS II	09/14/2023	_
CS503	SITE DETAILS III	09/14/2023	_
CS504	SITE DETAILS IV	09/14/2023	
CG100	OVERALL GRADING & DRAINAGE PLAN	09/14/2023	_
CG101	GRADING & DRAINAGE PLAN I	09/14/2023	_
CG102	GRADING & DRAINAGE PLAN II	09/14/2023	-
CG501	GRADING & DRAINAGE DETAILS I	09/14/2023	_
CU100	OVERALL UTILITY PLAN	09/14/2023	-
CU101	UTILITY PLAN I	09/14/2023	-
CU102	UTILITY PLAN II	09/14/2023	_
CU501	UTILITY DETAILS I	09/14/2023	_
CU502	UTILITY DETAILS II	09/14/2023	_
CE100	OVERALL SOIL EROSION & SEDIMENT CONTROL PLAN	09/14/2023	-
CE501	SOIL EROSION & SEDIMENT CONTROL DETAILS I	09/14/2023	_
CE502	SOIL EROSION & SEDIMENT CONTROL DETAILS I	09/14/2023	_
LP100	OVERALL PLANTING PLAN	09/14/2023	_
LP101	PLANTING PLAN I	09/14/2023	_
LP102	PLANTING PLAN II	09/14/2023	_
LP501	PLANTING NOTES & DETAILS	09/14/2023	_
LL100	OVERALL SITE LIGHTING PLAN	09/14/2023	_
LL101	SITE LIGHTING PLAN I	09/14/2023	_
 LL102	SITE LIGHTING PLAN II	09/14/2023	_
LL501	SITE LIGHTING NOTES & DETAILS	09/14/2023	

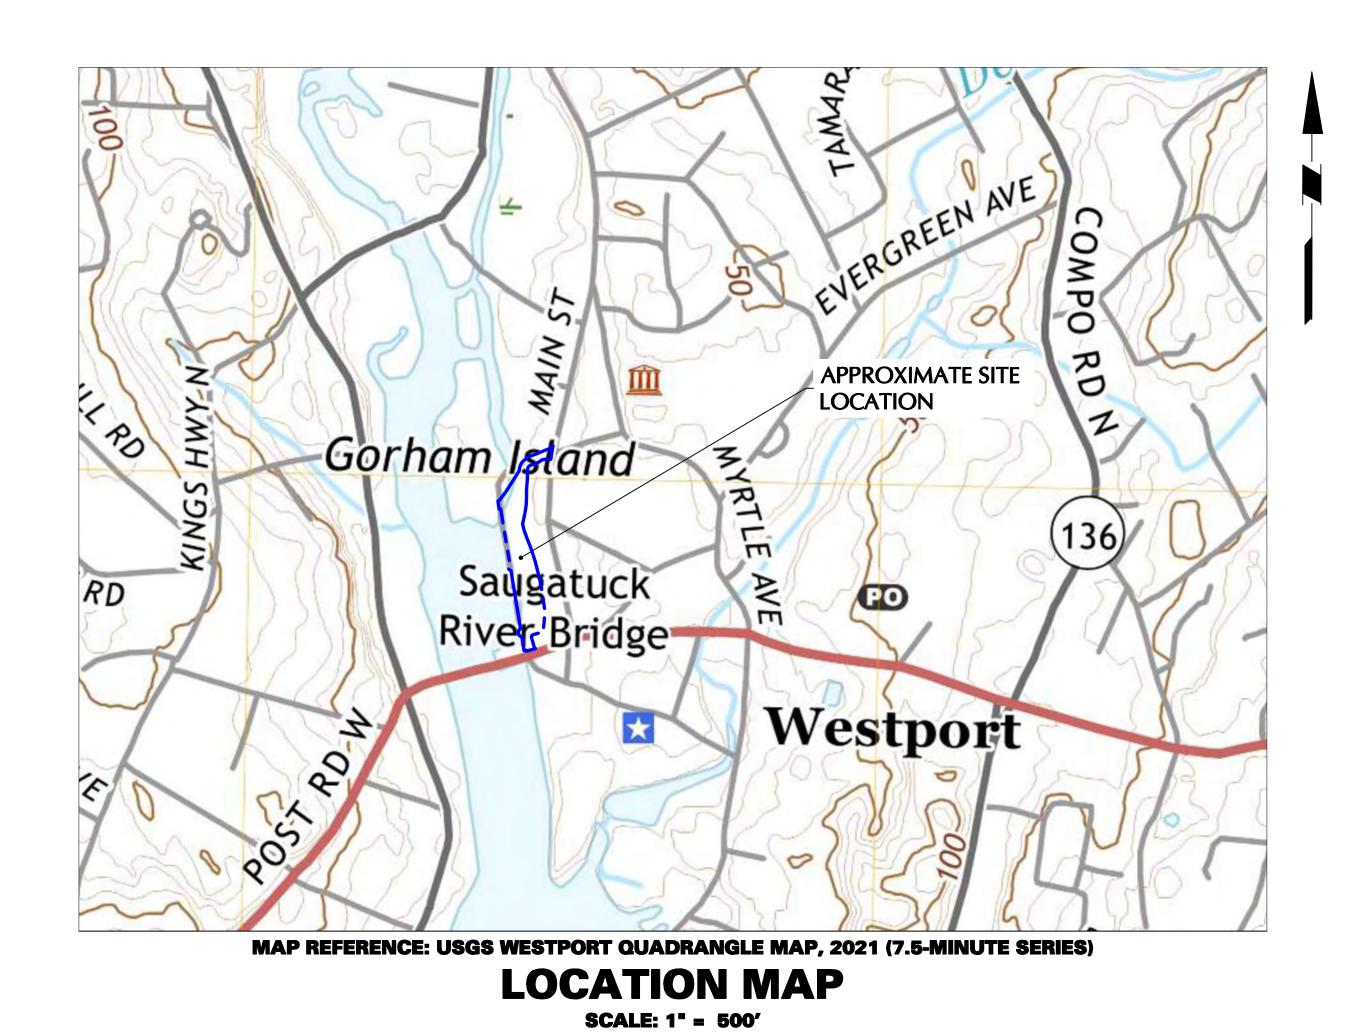



OWNER
TOWN OF WESTPORT
110 MYRTLE AVE
WESTPORT, CT 06880
PHONE: (203) 341-1000

CIVIL ENGINEER, TRAFFIC ENGINEER,
GEOTECHNICAL ENGINEER, &
LANDSCAPE ARCHITECT
LANGAN ENGINEERING &
ENVIRONMENTAL SERVICES, INC
C/O: DAVID GAGNON
555 LONG WHARF DRIVE
NEW HAVEN, CT 06511
PHONE: (203) 562-5771

RELEASE DATES		
DATE	ISSUED FOR	
09/14/2023	CONSERVATION DEPARTMENT & FLOOD AND EROSION CONTROL BOARD SUBMISSION	
09/22/23	VILLAGE DISTRICT OVERLAY REVIEW	



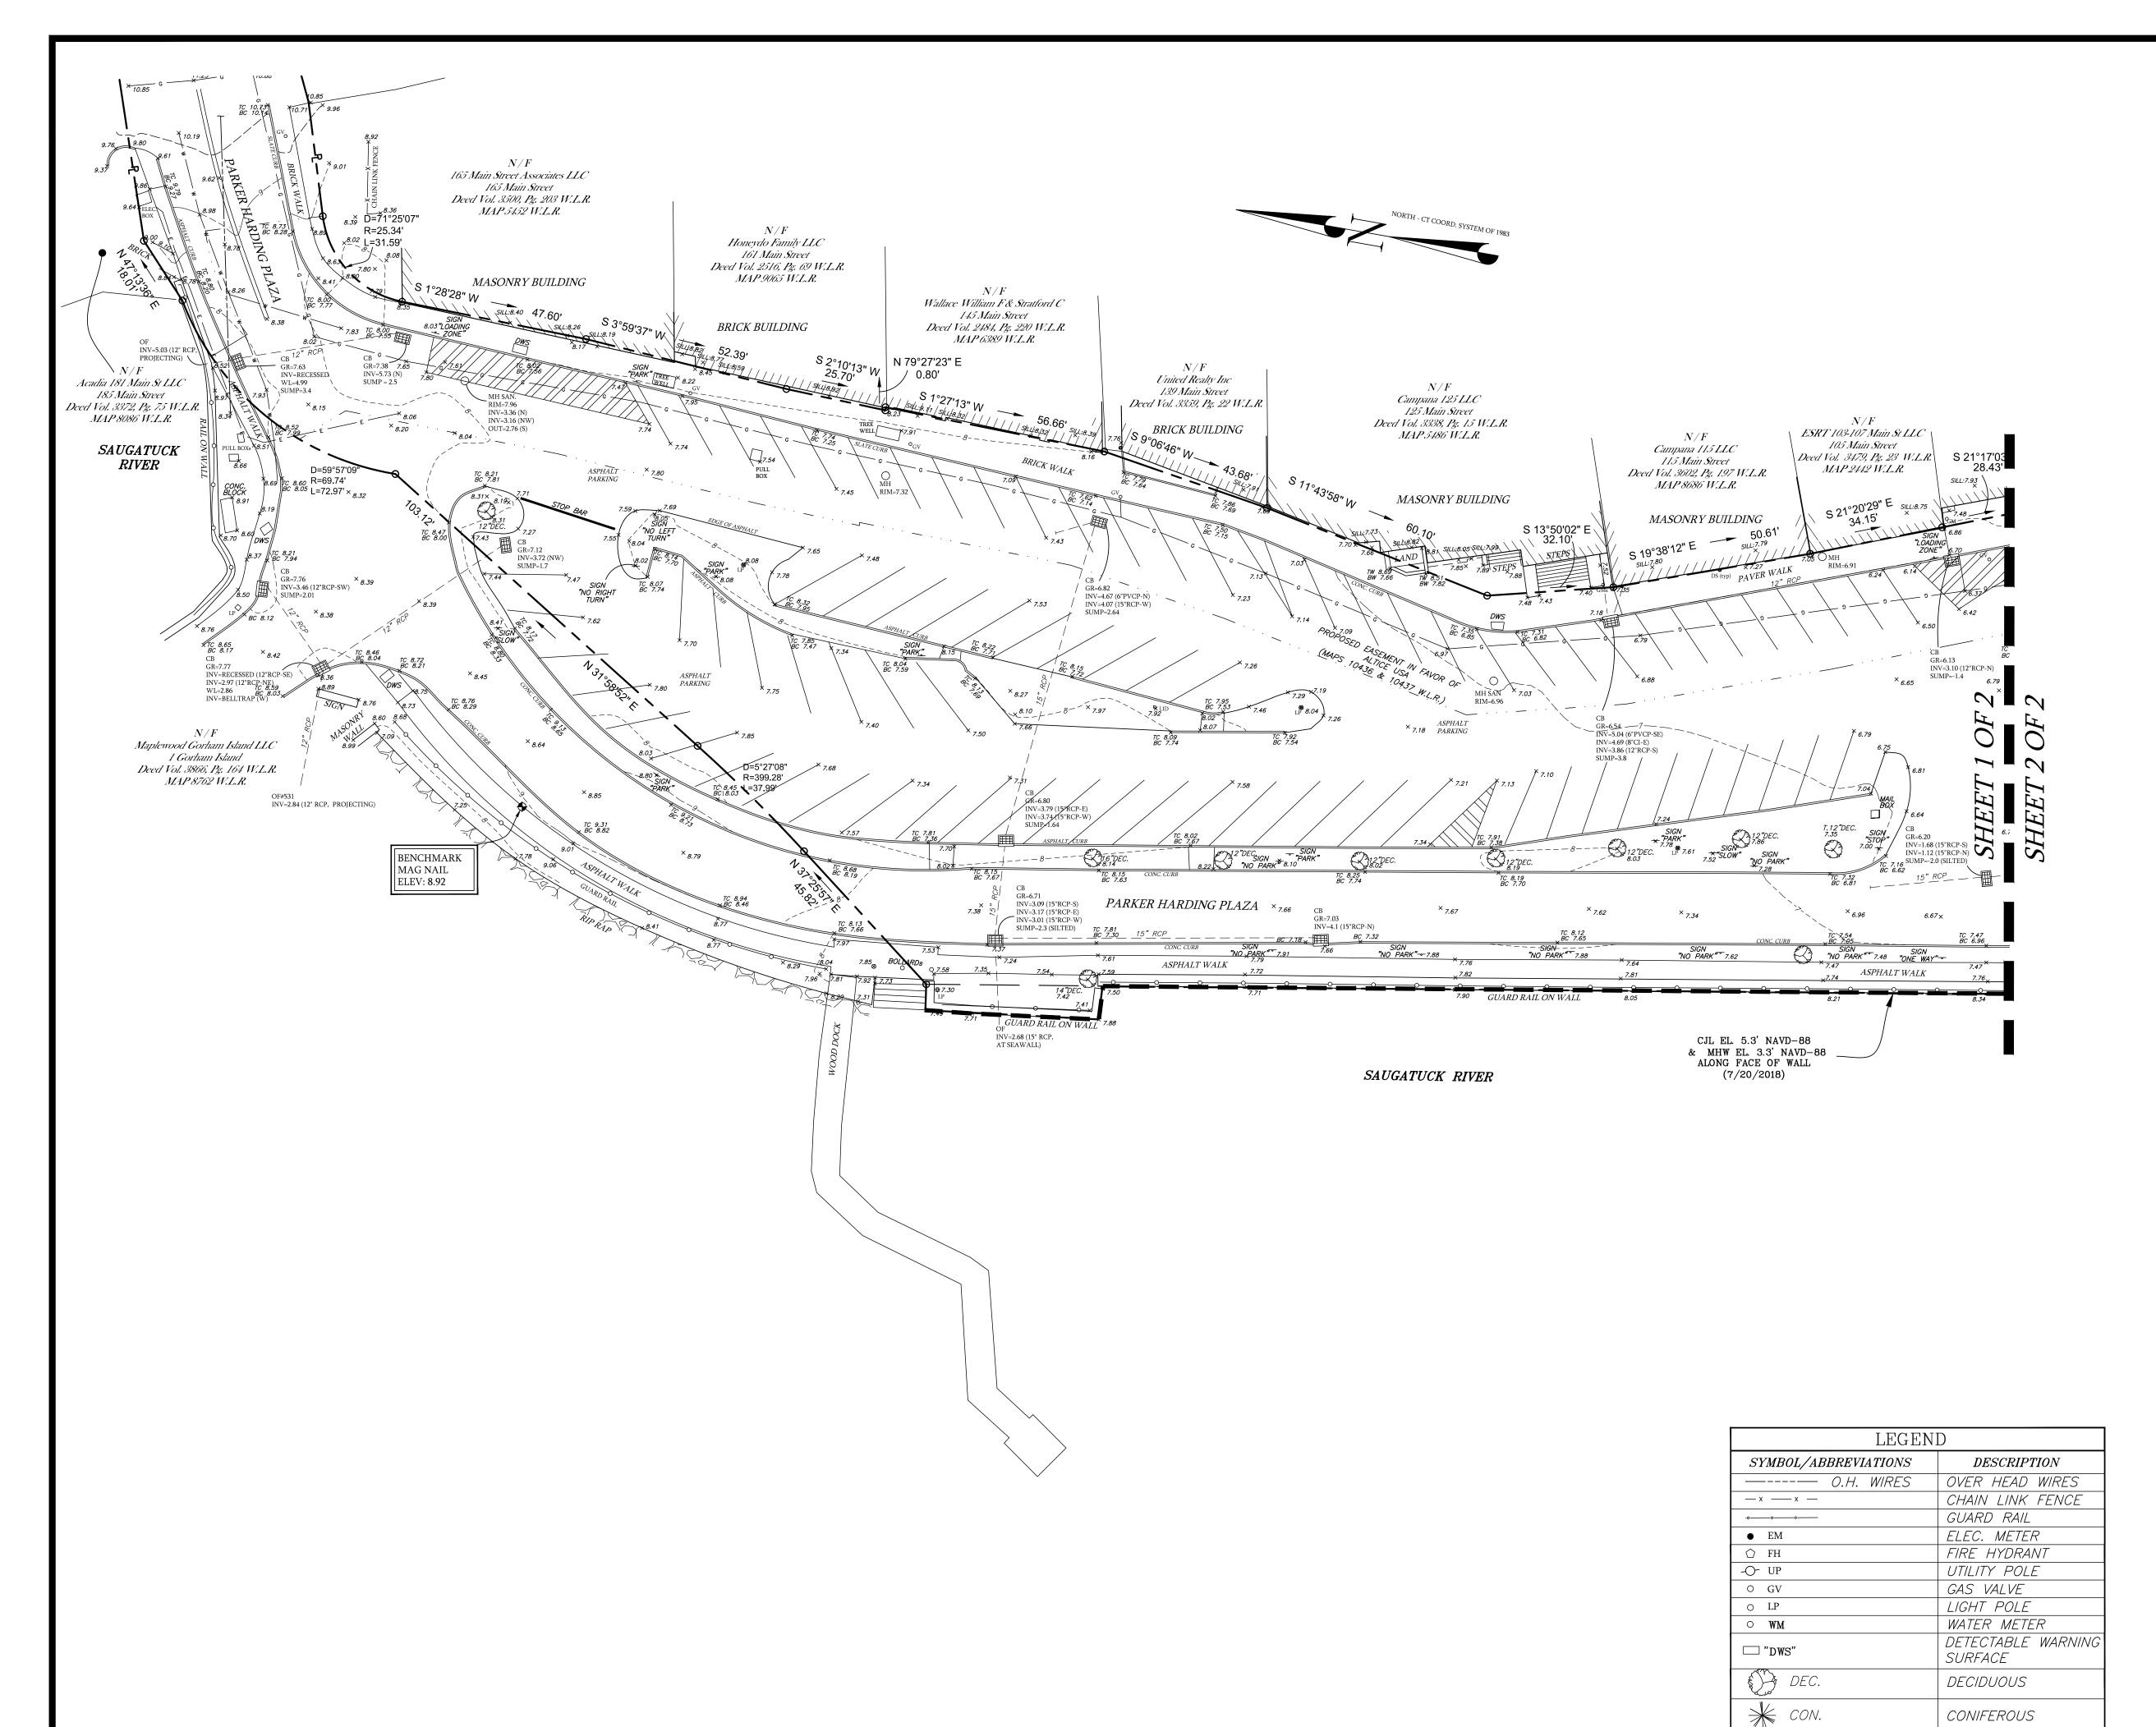

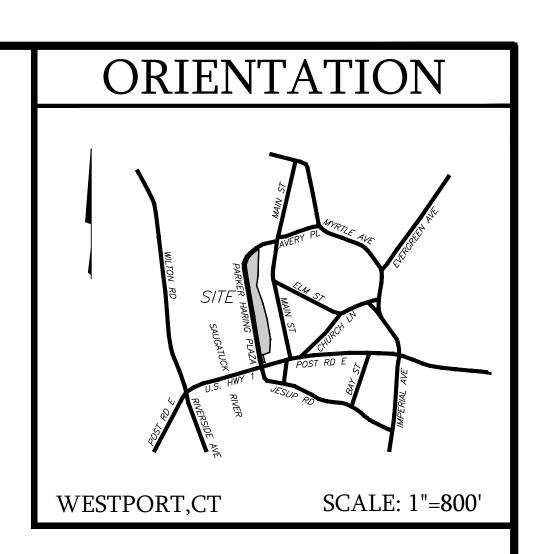

NOTES:

- This survey has been prepared in accordance with Sections 20-300b-1 thru 20-300b-20 of the Regulations of Connecticut State Agencies and the "Standards for Surveys and Maps in the State of Connecticut" as adopted by the Connecticut Association of Land Surveyors, Inc. as a Limited Property and Topographic Survey the Boundary Determination Category of which is a Resurvey conforming to Horizontal Accuracy Class A-2 and the locations and elevations of which conform to Topographic Accuracy Class T-2. It is intended to depict boundaries, locations and elevations of improvements and topographic features on a portion of Parker Harding Plaza.
- Reference is made to instruments of record as labeled hereon.
- Reference is made to maps 3192, 3748, 3624, 10436 and 10437 of the Westport Land Records
- Reference is made to deeds of record Bk 3866, Pg. 164 and Bk. 119, Pg. 194 W.L.R.
- Elevations depicted hereon are based on North American Vertical Datum of 1988(NAVD-88).
- Bearings depicted hereon area based on Connecticut State Coordinate System NAD'83.
- Subject area lies within a Special Flood Hazard Area Zone AE with a BFE 10 as depicted on FEMA Flood Insurance Rate Map Community Panel No. 09001C0413G Map Effective July 8, 2013.
- Location, extent and sizes of underground utilities depicted hereon must be considered approximate and may not be complete. Utilities were compiled partly from field measurements and municipal records. Consult with the appropriate utility company or agency prior to construction.
- Property may be subject to Riparian rights of others in and to any brook, stream or pond abutting or passing through the parcel.
- Wetlands, if any, are not depicted hereon.


DED.

DEAD TREE

LIMITED PROPERTY & TOPOGRAPHIC SURVEY **DEPICTING** PARKER HARDING PLAZA WESTPORT, CT PREPARED FOR TOWN OF WESTPORT

DATE: 12/06/2022 JOB NO. 093 1"=20' BIMAR 70 & BEREC KY To my knowledge and belief this map is substantially 203.857.4110 This document is valid only if they bears the signature an seal of the designated licensed professional than the alterations or addition to this document shall that contents null and void.

LAND SURVEYING 10 HIGH CIRCLE LANE FAIRFIELD, CT 06825 LAND SURVEYING CIVIL ENGINEERING

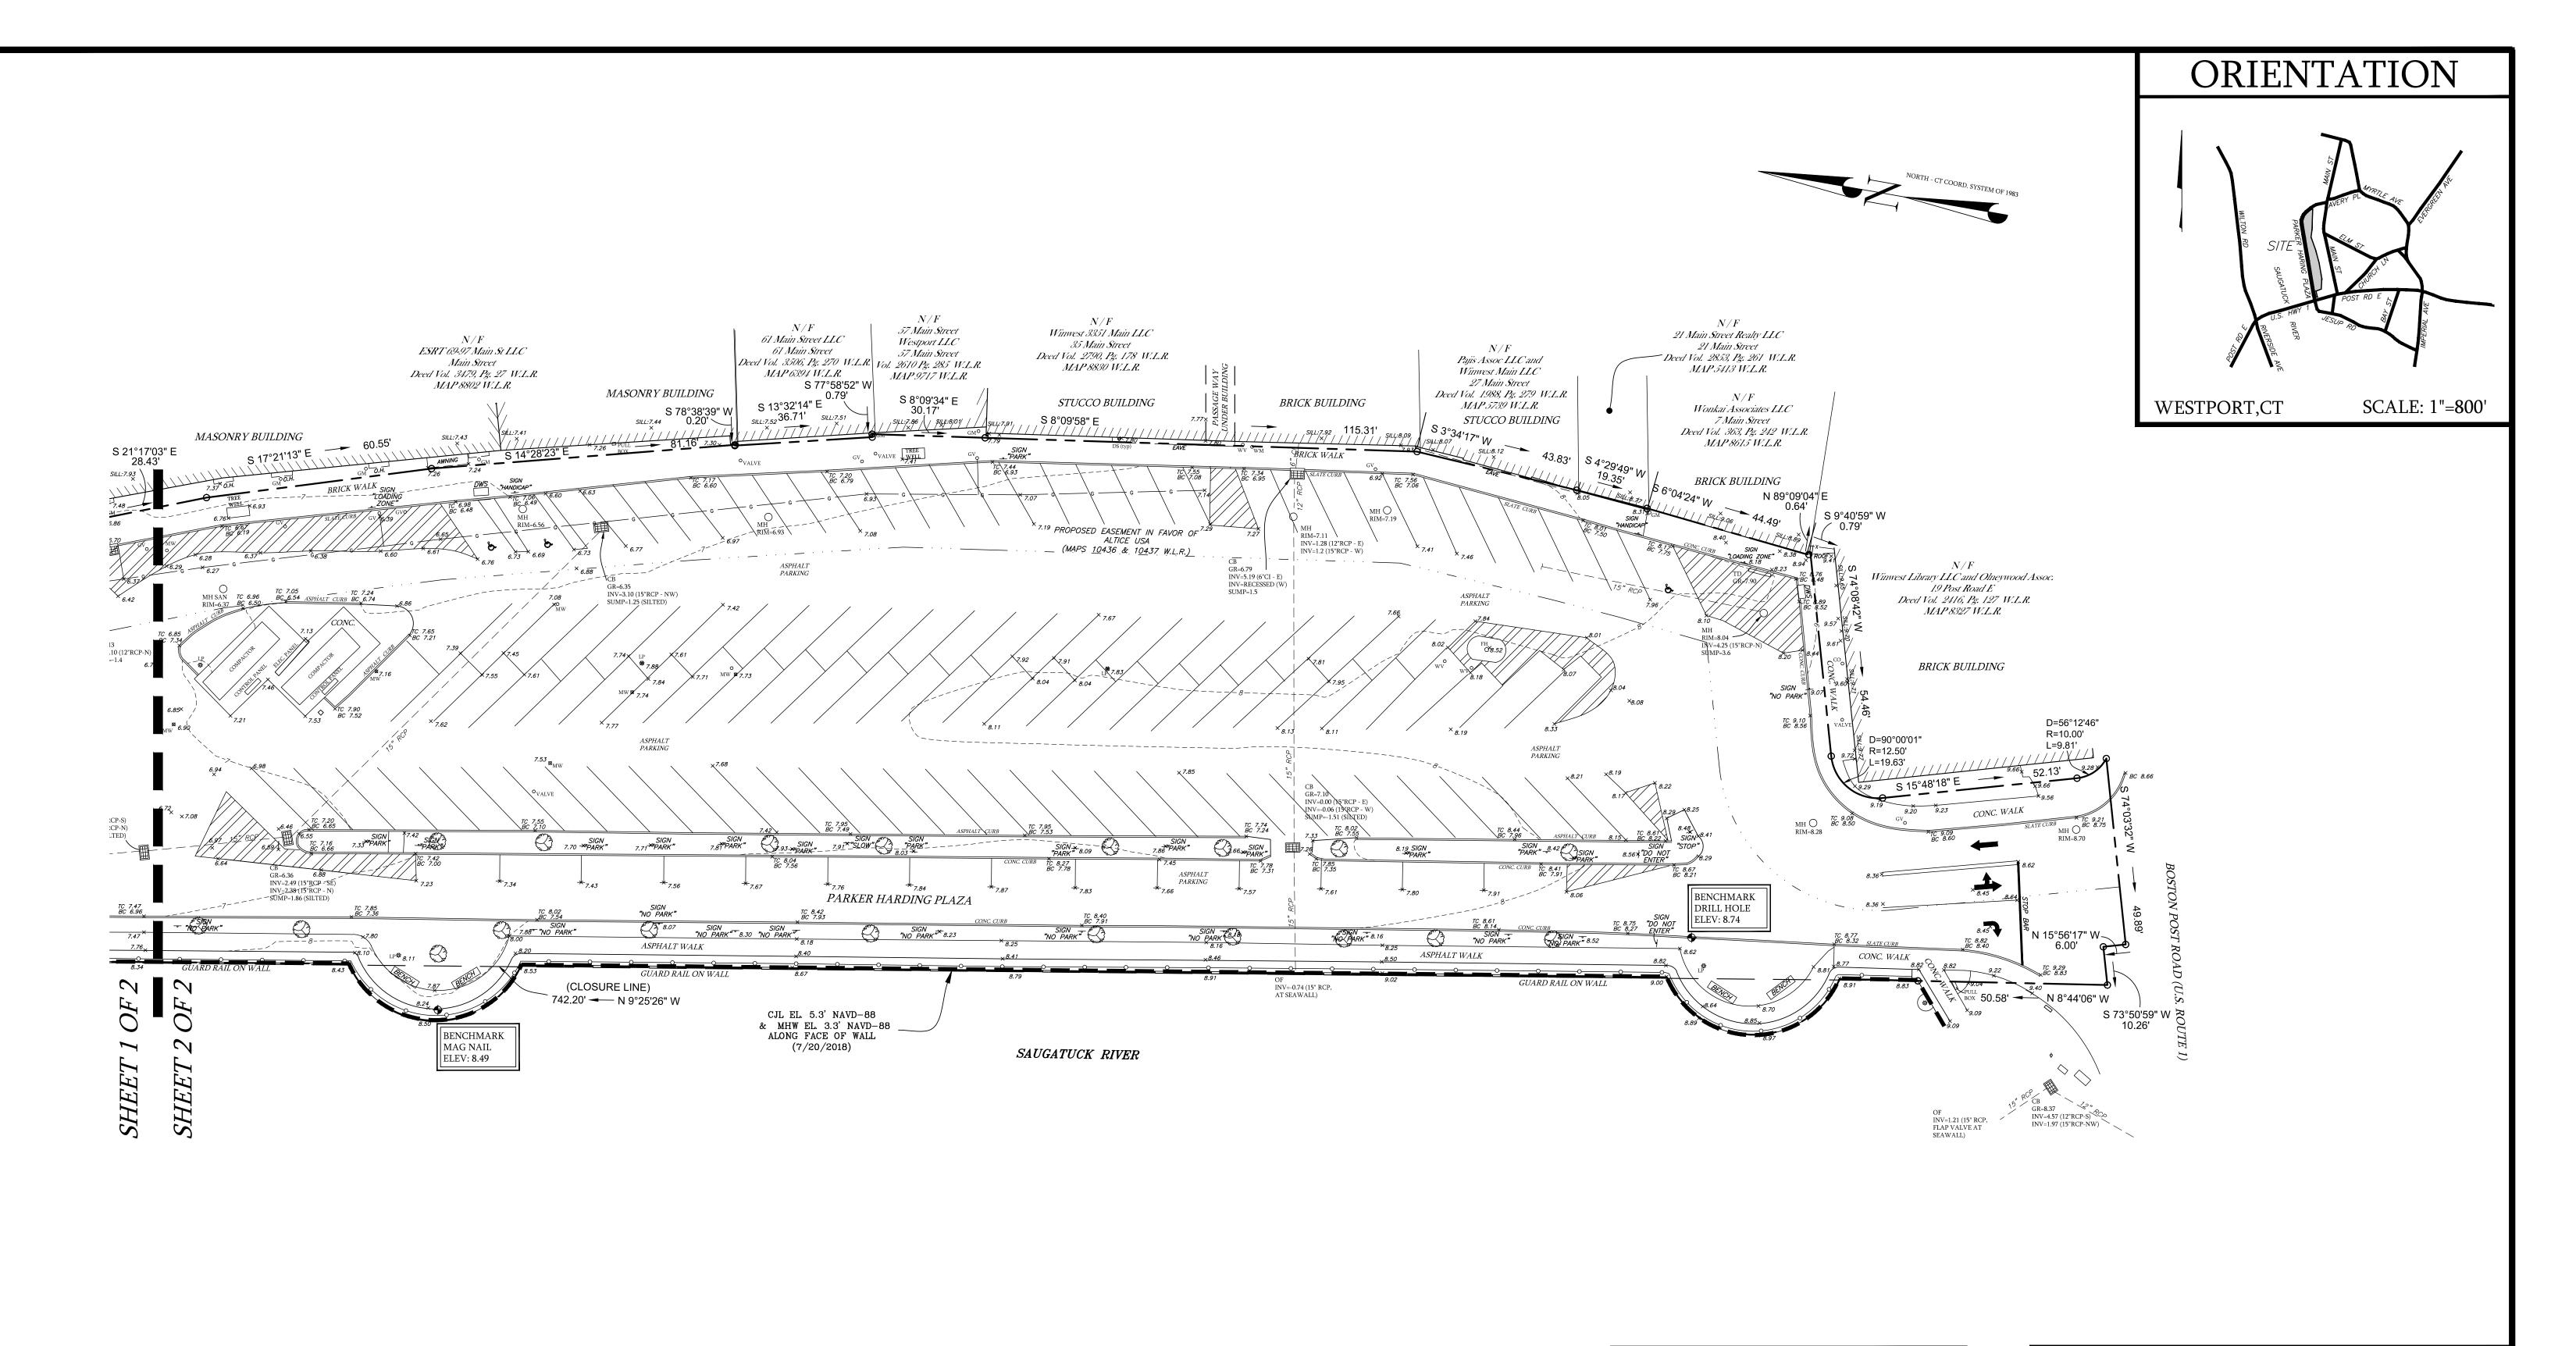

LEGEND		
SYMBOL/ABBREVIATIONS	DESCRIPTION	
— O.H. WIRES	OVER HEAD WIRES	
_xx _	CHAIN LINK FENCE	
-00	GUARD RAIL	
• EM	ELEC. METER	
	FIRE HYDRANT	
-O- UP	UTILITY POLE	
O GV	GAS VALVE	
O LP	LIGHT POLE	
O WM	WATER METER	
□ "DWS"	DETECTABLE WARNING SURFACE	
DEC.	DECIDUOUS	
* CON.	CONIFEROUS	
DED.	DEAD TREE	

LIMITED PROPERTY & TOPOGRAPHIC SURVEY DEPICTING PARKER HARDING PLAZA WESTPORT, CT

PREPARED FOR

TOWN OF WESTPORT

DATE: 12/06/2022 JOB NO. 093	0 20 40
SEE SHEET ROW 1 OF 2 FOR NOTES & CERTIFICATION	BIMAR70 & EREC LKY 10 HIGH CIRCLE LANE FAIRFIELD, CT 06825 203.857.4110 LAND SURVEYING CIVIL ENGINEERING PERMITTING
This document is valid only if they bears the signature and seal of the designated licensed professional. Unauthorized alterations or addition to this document shall make the contents null and void.	ROW 2 of 2

DEMOLITION NOTES

GENERAL:

- 1. THE CONTRACTOR SHALL INSPECT THE SITE THOROUGHLY AND FIELD-VERIFY THE LOCATION AND DEPTH OF ALL EXISTING UTILITIES. SOME UNDERGROUND UTILITIES MAY BE LOCATED DIFFERENTLY THAN SHOWN ON THIS PLAN. IN ADDITION, THERE MAY BE EXISTING UNDERGROUND UTILITIES PRESENT THAT ARE NOT SHOWN ON THIS PLAN. ALL CONTRACTORS USING THESE PLANS FOR DEMOLITION OR CONSTRUCTION SHALL CONFIRM | ALL UTILITIES IN THE FIELD TO ESTABLISH LOCATIONS, SIZES, MATERIALS, AND ELEVATIONS. ANY DISCREPANCIES SHALL IMMEDIATELY BE BROUGHT TO THE ATTENTION OF THE ENGINEER AND THE CONSTRUCTION MANAGER.
- 2. THE CONTRACTOR IS RESPONSIBLE FOR CONTACTING "CALL BEFORE YOU DIG," EXCAVATING THE HOLES, AND PREPARING ANY ADDITIONAL RESEARCH OR INVESTIGATIONS REQUIRED IN ORDER TO ENSURE THAT PROPOSED UTILITIES TO REMAIN ARE PROTECTED FROM DAMAGE DURING DEMOLITION. ANY DAMAGE TO EXISTING UTILITIES TO REMAIN IS REQUIRED TO BE REPAIRED BY THE CONTRACTOR.
- 3. THE CONTRACTOR SHALL NOTIFY AND OBTAIN ALL SHUTOFFS FOR ALL APPLICABLE UTILITIES PRIOR TO THE COMMENCEMENT OF DEMOLITION.
- STORM DRAINAGE THROUGHOUT CONSTRUCTION. THE CONTRACTOR SHALL FIELD LOCATE AND PROPERLY DISCONNECT APPROPRIATE LATERALS TO LIVE MAINS

4. THE CONTRACTOR SHALL LOCATE/CONFIRM ALL DRAINAGE INFRASTRUCTURE AND MAINTAIN ADEQUATE

- PRIOR TO DEMOLITION AND IN ACCORDANCE WITH UTILITY COMPANY STANDARDS. 6. THE CONTRACTOR SHALL MAINTAIN THE SAFETY AND PROTECTION OF BOTH PEDESTRIANS AND MOTORISTS. IT IS THE CONTRACTOR'S RESPONSIBILITY TO TAKE ALL NECESSARY PRECAUTIONARY AND PROTECTIVE
- MEASURES, INCLUDING SIGNS, LIGHTS, BARRIERS, FENCING AND TRAFFIC FLAGMEN. 7. THE CONTARCTOR SHALL BE RESPONSIBLE FOR OBTAINING ALL NECESSARY DEMOLITION ASSOCIATED
- 8. CONTRACTOR TO PROTECT AND MAINTAIN ALL UTILITIES TO REMAIN UNTIL TEMPORARY OR PERMANENT NEW LINES ARE INSTALLED.

<u>DEMOLITION:</u>

- 9. THE CONTARCTOR SHALL REMOVE AND LEGALLY DISPOSE OF ALL STRUCTURES WITHIN THE PROJECT LIMITS INDICATED TO BE REMOVED.
- 10. THE CONTRACTOR SHALL INCLUDE IN HIS BID ALL TEMPORARY FACILITIES AND SERVICES NECESSARY TO SATISFY FEDERAL, STATE, & LOCAL REQUIREMENTS INCLUDING BUT NOT LIMITED TO BRACING, SHORING, PAVEMENT REPAIR, FENCING, PEDESTRIAN AND VEHICLE ACCESS, CONCRETE PADS, ETC.

GENERAL SITE NOTES

- BOUNDARY AND TOPOGRAPHIC INFORMATION WAS OBTAINED FROM A PLAN ENTITLED "LIMITED PROPERTY & TOPOGRAPHIC SURVEY" PREPARED BY DIMARZO & BERECZKY, DATED 12/06/22. SITE PLAN PREPARED FROM THIS CLASS A-2 SURVEY.
- THESE PLANS REPRESENT THE OVERALL SITEWORK IMPROVEMENTS REQUIRED FOR PROJECT CONSTRUCTION. THE CONTRACTOR SHALL FURNISH, INSTALL, TEST AND COMPLETE ALL WORK TO THE SATISFACTION OF THE ENGINEER AND OWNER IN ACCORDANCE WITH THE CONTRACT DOCUMENTS. THE CONTRACTOR SHALL BE SOLELY RESPONSIBLE FOR MEANS AND METHODS OF CONSTRUCTION; AS SUCH, THESE PLANS DO NOT COMPLETELY REPRESENT, NOR ARE THEY INTENDED TO REPRESENT, ALL SPECIFIC INSTRUCTIONS REQUIRED FOR SITEWORK CONSTRUCTION. THE CONTRACTOR SHALL BE RESPONSIBLE TO CONSTRUCT ALL IMPROVEMENTS DEPICTED ON THESE PLANS IN ACCORDANCE WITH ALL APPLICABLE RULES, REGULATIONS AND LAWS IN EFFECT AT THE TIME OF CONSTRUCTION.
- THE CONTRACTOR SHALL ACCEPT THE SITE AS IS. THE CONTRACTOR SHALL ASSESS CONDITIONS, AND THE KIND, QUALITY AND QUANTITY OF WORK REQUIRED. THE OWNER MAKES NO GUARANTEE IN REGARD TO THE ACCURACY OF ANY AVAILABLE INFORMATION WHICH WAS OBTAINED DURING INVESTIGATIONS. THE CONTRACTOR SHALL MAKE A THOROUGH SITE INSPECTION IN ORDER TO FIELD CHECK EXISTING SITE CONDITIONS, CORRELATE CONDITIONS WITH THE DRAWINGS AND RESOLVE ANY POSSIBLE CONSTRUCTION CONFLICTS WITH THE OWNER AND ENGINEER PRIOR TO COMMENCEMENT OF WORK. THE CONTRACTOR SHALL MAKE ADDITIONAL TOPOGRAPHIC SURVEYS HE DEEMS NECESSARY, PROVIDED THEY ARE COORDINATED WITH THE OWNER. ANY CONDITIONS DETERMINED BY THE CONTRACTOR THAT DIFFER FROM THE INFORMATION SHOWN ON THE DRAWINGS THAT ARE NOT BROUGHT TO THE ATTENTION OF THE OWNER AND ENGINEER PRIOR TO THE START OF WORK SHALL NOT BE CONSIDERED GROUNDS FOR ADDITIONAL PAYMENT OR
- CHANGES TO THE CONTRACT DURATION. OR ANY OTHER CLAIMS AGAINST THE OWNER OR OWNER'S ENGINEER. THE CONTRACTOR SHALL, WHEN THEY DEEM NECESSARY, PROVIDE WRITTEN REQUESTS FOR INFORMATION (RFIS) TO THE OWNER AND ENGINEER PRIOR TO THE CONSTRUCTION OF ANY SPECIFIC SITEWORK ITEM. THE (RFI) SHALL BE IN A FORM ACCEPTABLE TO OWNER AND ENGINEER AND SHALL ALLOW FOR A MINIMUM OF TWO WORK DAYS OR ADDITIONAL REASONABLE TIME FOR A WRITTEN REPLY. RFIS SHALL BE NUMBERED CONSECUTIVELY BY DATE SUBMITTED. THE CONTRACTOR SHALL BE SOLELY RESPONSIBLE FOR SITEWORK
- ITEMS CONSTRUCTED DIFFERENTLY THAN INTENDED OR AS DEPICTED ON THE PLANS. INFORMATION RELATED TO ELEVATIONS AND PROPOSED UTILITIES (SUCH AS ROADWAY GRADES, INVERT ELEVATIONS, RIM ELEVATIONS, GRATE ELEVATIONS, BUILDING FINISHED FLOOR ELEVATIONS, ETC.) MAY BE FOUND IN MORE THAN ONE LOCATION IN THE CONTRACT DOCUMENTS. THE CONTRACTOR SHALL SUFFICIENTLY REVIEW ALL PLANS. PROFILES AND ANY OTHER INFORMATION IN THE CONTRACT DOCUMENTS FOR CONSISTENCY PRIOR TO CONSTRUCTION. ANY INCONSISTENCIES OR DISCREPANCIES THAT ARE FOUND BY THE CONTRACTOR OR HIS ASSIGNS SHALL BE IMMEDIATELY BROUGHT TO THE ATTENTION OF THE OWNER AND ENGINEER IN WRITING. IN THE FORMAT OF AN RFI PRIOR TO CONSTRUCTION.
- THERE ARE ADDITIONAL NOTES, SPECIFICATIONS AND REQUIREMENTS CONTAINED THROUGHOUT THE PLAN SET AS WELL AS REFERENCES TO SPECIFICATIONS FROM APPLICABLE GOVERNING AUTHORITIES AND INDUSTRY STANDARDS. IT IS THE CONTRACTOR'S RESPONSIBILITY TO OBTAIN, REVIEW AND ADHERE TO ALL THESE
- THE CONTRACTOR AND/OR HIS/HER AGENTS MUST MAINTAIN (REPAIR/REPLACE), WHEN NECESSARY, THE SILTATION CONTROL UNTIL ALL DEVELOPMENT ACTIVITY IS COMPLETED AND ALL DISTURBED AREAS ARE
- PERMANENTI Y STABILIZED. HANDICAP PARKING SHALL COMPLY WITH THE CT STATE BUILDING CODE REQUIREMENTS AS OF OCTOBER 2018 OR LAST REVISED.

GRADING & DRAINAGE NOTES

- 1. STORM DRAINAGE PIPING INSTALLATION SHALL COMMENCE AT THE FURTHEST DOWNSTREAM POINT AND PROCEED UPSTREAM "IN THE DRY".
- 2. THE CONTRACTOR WILL BE REQUIRED TO CLEAN THE ENTIRE DRAINAGE SYSTEM OF ALL DEBRIS AND OBSTRUCTIONS BOTH DURING CONSTRUCTION AND AT THE END OF CONSTRUCTION PRIOR TO ACCEPTANCE. THIS SHALL INCLUDE, BUT NOT BE LIMITED TO, REMOVAL OF ALL FORMWORK FROM STRUCTURES, CONCRETE AND MORTAR DROPPINGS, CONSTRUCTION DEBRIS, AND DIRT. THE SYSTEM SHALL BE THOROUGHLY FLUSHED CLEAN AND THE CONTRACTOR SHALL FURNISH ALL NECESSARY HOSE, PUMPS, PIPE, AND OTHER EQUIPMENT THAT MAY BE REQUIRED FOR THIS PURPOSE. NO DEBRIS SHALL BE FLUSHED INTO EXISTING STORM DRAINS, WETLANDS, OR WATERCOURSES; ALL DEBRIS SHALL BE REMOVED FROM THE SYSTEM AND DISPOSED OF IN ACCORDANCE WITH ALL GOVERNING AGENCIES.
- 3. ALL MANHOLE COVERS, GRATES, INLETS, AND RIMS TO REMAIN SHALL BE ADJUSTED TO PROPOSED GRADE. 4. CONTRACTOR TO PROVIDE ALL FITTINGS AND BENDS NECESSARY TO ACCOMPLISH WORK.

CONTRACTOR NOTES

- 1. THE WORK TO $\,$ BE PERFORMED IS AS SHOWN ON THE DRAWINGS. THE CONTRACTOR IS RESPONSIBLE FOR MEANS AND METHODS OF CONSTRUCTION; AS SUCH, THESE PLANS MAY NOT COMPLETELY REPRESENT ALL SPECIFIC DETAILS OF INSTALLATION REQUIRED FOR CONSTRUCTION. CONTRACTOR IS RESPONSIBLE TO PROVIDE ALL IMPROVEMENTS REQUIRED TO ACHIEVE CONSTRUCTION DEPICTED ON THESE PLANS.
- 2. THE CONTRACTOR SHALL PROVIDE WRITTEN REQUESTS FOR INFORMATION TO THE OWNER AND OWNER'S ENGINEER PRIOR TO THE CONSTRUCTION OF ANY SPECIFIC SITEWORK ITEM IF ANY SITEWORK ITEM DEPICTED ON THE PLANS WARRANTS ADDITIONAL ENGINEERING INFORMATION REQUIRED FOR CONSTRUCTION AND IS NOT RELATED TO MEANS AND METHODS OF CONSTRUCTION. THE CONTRACTOR SHALL BE RESPONSIBLE FOR SITEWORK ITEMS INSTALLED DIFFERENTLY THAN INTENDED AS DEPICTED ON THE PLANS IN THE ABSENCE OF SUBMITTING AND RECEIVING REVIEWS AND/OR DIRECTION ON WRITTEN REQUESTS FOR INFORMATION.
- 3. THE CONTRACTOR SHALL ACCEPT THE SITE AS IS. THE CONTRACTOR SHALL MAKE AND SHALL BE DEEMED TO HAVE MADE A THOROUGH SITE INSPECTION IN ORDER TO FIELD CHECK EXISTING SITE CONDITIONS, CORRELATE CONDITIONS WITH THE DRAWINGS AND RESOLVE ANY POSSIBLE CONSTRUCTION CONFLICTS WITH THE OWNER AND OWNER'S ENGINEER PRIOR TO COMMENCEMENT OF WORK. THIS INCLUDES A TOPOGRAPHIC SURVEY OF ANY AREAS THE CONTRACTOR REQUIRES ADDITIONAL TOPOGRAPHIC INFORMATION. ANY CONDITIONS THAT DIFFER FROM THE EXISTING CONDITIONS SHOWN ON THE DRAWINGS THAT ARE NOT BROUGHT TO THE ATTENTION OF THE OWNER AND OWNER'S ENGINEER PRIOR TO THE START OF WORK SHALL NOT BE CONSIDERED GROUNDS FOR A CHANGE ORDER.
- 4. IT IS SPECIFICALLY NOTED THAT INFORMATION RELATED TO ELEVATIONS AND PROPOSED UTILITIES (SUCH AS ROADWAY GRADES, INVERT ELEVATIONS, RIM ELEVATIONS, GRATE ELEVATIONS, BUILDING FINISHED FLOOR ELEVATIONS, ETC.) MAY BE FOUND IN MORE THAN ONE LOCATION ON THE DRAWINGS. CONTRACTOR SHALL REVIEW ALL PLANS. PROFILES AND ANY INFORMATION /DATA TABLES FOR CONSISTENCY PRIOR TO CONSTRUCTION. ANY INCONSISTENCIES OR DISCREPANCIES THAT ARE FOUND SHALL IMMEDIATELY BE BROUGHT TO THE ATTENTION OF THE OWNER'S ENGINEER IN WRITING REQUESTING CLARIFICATION PRIOR TO CONSTRUCTION.
- 5. CONTRACTOR SHALL NOTE THAT THERE ARE ADDITIONAL NOTES, SPECIFICATIONS AND REQUIREMENTS CONTAINED ON SHEETS THROUGHOUT THE PLAN SET AND AVAILABLE REFERENCES TO SPECIFICATIONS FROM APPLICABLE GOVERNING AUTHORITIES AND INDUSTRY STANDARDS. IT IS THE CONTRACTOR'S RESPONSIBILITY TO OBTAIN, REVIEW AND ADHERE TO ALL APPLICABLE REQUIREMENTS
- 6. THE CONTRACTOR IS SPECIFICALLY CAUTIONED THAT THE LOCATION AND/OR ELEVATION OF EXISTING UTILITIES AS SHOWN ON THESE PLANS IS BASED ON RECORDS OF THE VARIOUS UTILITY COMPANIES AND WHERE POSSIBLE, MEASUREMENTS TAKEN IN THE FIELD. THE INFORMATION IS NOT TO BE RELIED UPON AS BEING EXACT OR COMPLETE. THE CONTRACTOR MUST CONTACT "CALL BEFORE YOU DIG" @ 1-800-922-4455 FOR THE LOCATION AND MARKING OF ALL EXISTING UTILITIES PRIOR TO ANY EXCAVATION. IT SHALL BE THE RESPONSIBILITY OF THE CONTRACTOR TO RELOCATE ALL UTILITIES WHICH CONFLICT WITH THE PROPOSED IMPROVEMENTS SHOWN ON THE PLANS.
- 7. THE CONTRACTOR SHALL FIELD VERIFY ALL EXISTING CONDITIONS, UTILITY LOCATIONS, AND INVERTS PRIOR TO CONSTRUCTION. ANY CONDITIONS FOUND TO DIFFER FROM THOSE SHOWN BY THE DRAWINGS SHALL BE IMMEDIATELY BROUGHT TO THE ATTENTION OF THE ENGINEER.
- 8. THE CONTRACTOR SHALL VISIT THE SITE AND VERIFY THE ELEVATION AND LOCATION OF ALL UTILITIES BY VARIOUS MEANS PRIOR TO BEGINNING ANY EXCAVATION. TEST PITS SHALL BE DUG A $^{-}$ ALL LOCATIONS WHERE THE PROPOSED SANITARY AND STORM PIPING WILL CROSS EXISTING UTILITIES AND THE HORIZONTAL AND VERTICAL LOCATIONS OF THE UTILITIES SHALL BE DETERMINED. THE CONTRACTOR SHALL CONTACT THE CIVIL ENGINEER IN THE EVENT OF ANY DISCOVERED OR UNFORESEEN CONFLICTS SO THAT AN APPROPRIATE MODIFICATION CAN BE MADE.
- 9. CONTRACTOR IS RESPONSIBLE FOR CONTACTING THE TOWN OF WESTPORT TO SECURE CONSTRUCTION PERMITS AND FOR PAYMENT OF FEES FOR STREET CUTS AND CONNECTIONS TO EXISTING UTILITIES.
- 10. THE CONTRACTOR SHALL ENSURE THAT ALL UTILITY PROVIDERS AND GOVERNING AUTHORITY STANDARDS FOR MATERIALS AND CONSTRUCTION METHODS ARE MET. THE CONTRACTOR SHALL PERFORM PROPER COORDINATION WITH THE RESPECTIVE UTILITY PROVIDER
- 11. THE CONTRACTOR SHALL RESTORE ANY UTILITY STRUCTURE, PIPE, UTILITY, PAVEMENT, CURBS, SIDEWALKS, DRAINAGE STRUCTURE, SWALE OR LANDSCAPED AREAS DISTURBED DURING CONSTRUCTION, TO THEIR ORIGINAL CONDITION OR BETTER TO THE SATISFACTION OF THE OWNER, TOWN OF WESTPORT AND STATE OF CONNECTICUT

ABBREVIATIONS

SWL - SINGLE WHITE LINE DYL - DOUBLE YELLOW LINE BWL - BROKEN WHITE LINE

CLF - CHAIN LINK FENCE AD - AREA DRAIN CB - CATCH BASIN

TYP - TYPICAL

N.I.C. - NOT IN CONTRACT HDPE - HIGH DENSITY POLYETHYLENE PIPE PVC - POLYVINYL CHLORIDE PIPE RI - ROOF | FADER

MH - MANHOLE CCB - CURBED CATCH BASIN (STORM INLET) INV - INVERT

LF - LINEAR FEET CO - CLEAN OUT TF - TOP OF FRAME

RCP - REINFORCED CONCRETE PIPE YD - YARD DRAIN

V.I.F. - VERIFY IN FIELD GTD - GRADE TO DRAIN LA - LANDSCAPE AREA

UTILITY NOTES

- THE CONTRACTOR IS SPECIFICALLY CAUTIONED THAT THE LOCATION AND/OR ELEVATION OF EXISTING UTILITIES AS SHOWN ON THESE PLANS IS BASED ON RECORDS OF THE VARIOUS UTILITY COMPANIES, AND WHERE POSSIBLE, MEASUREMENTS TAKEN IN THE FIELD. THE INFORMATION IS NOT TO BE RELIED UPON AS BEING EXACT OR COMPLETE. THE CONTRACTOR MUST CONTACT "CALL-BEFORE-YOU-DIG" @ 1-800-922-4455 FOR THE LOCATION AND MARKING OF ALL EXISTING UTILITIES PRIOR TO ANY EXCAVATION. IT SHALL BE THE RESPONSIBILITY OF THE CONTRACTOR TO RELOCATE ALL UTILITIES WHICH CONFLICT WITH THE PROPOSED IMPROVEMENTS SHOWN ON THE PLANS.
- THE CONTRACTOR SHALL FIELD VERIFY ALL EXISTING CONDITIONS, UTILITY LOCATIONS, AND INVERTS PRIOR TO CONSTRUCTION. ANY CONDITIONS FOUND TO DIFFER FROM THOSE SHOWN BY THE DRAWINGS SHALL BE IMMEDIATELY BROUGHT TO THE ATTENTION OF THE ENGINEER.
- BEGINNING EXCAVATION. 4. THE CONTRACTOR SHALL BE RESPONSIBLE FOR ALL PAVEMENT REPAIRS REQUIRED AS A RESULT OF

THE CONTRACTOR SHALL BE RESPONSIBLE FOR NOTIFYING UTILITY COMPANIES 72 HOURS PRIOR TO

- ANY UTILITY WORK. 5. LOCATION OF SITE UTILITIES SHALL BE VERIFIED BY GENERAL CONTRACTOR THE PROPER UTILITY
- COMPANY PROVIDING SERVICE. GENERAL CONTRACTOR WILL BE RESPONSIBLE FOR ALL TAP AND TIE-IN FEES REQUIRED, AS WELL AS COST OF UNDERGROUND SERVICE CONNECTIONS TO THE BUILDING.
- 8. GENERAL CONTRACTOR SHALL HAVE APPROVAL OF ALL GOVERNING AGENCIES HAVING JURISDICTION OVER THE SYSTEM PRIOR TO INSTALLATION.

7. ALL TRENCHING, PIPE LAYING, AND BACKFILLING SHALL BE IN ACCORDANCE WITH FEDERAL OSHA


9. CONTRACTOR TO COORDINATE GAS MAIN, ELECTRIC, AND TELEPHONE INSTALLATION WITH THE APPROPRIATE UTILITY COMPANIES. 10. CONTRACTOR SHALL MAINTAIN A MINIMUM OF 30 INCHES OF COVER FOR ALL UNDERGROUND ELECTRIC, TELEPHONE AND GAS UTILITIES.

WATER & SANITARY:

ELECTRIC, TELEPHONE, & GAS:

11. GRAVITY PIPING SHALL BE INSTALLED FROM DOWNSTREAM TO UPSTREAM, "IN THE DRY". THE CONTRACTOR IS ENCOURAGED TO BEGIN WORK AT THE MOST DOWNSTREAM POINT IN THE SYSTEM, ESPECIALLY WHEN THE NEW WORK WILL CONNECT TO AN EXISTING UTILITY DOWNSTREAM. IF THE CONTRACTOR CHOOSES NOT TO START AT THE FURTHEST DOWNSTREAM LOCATION, THEN HE IS RESPONSIBLE FOR VERIFYING THE EXACT LOCATION, ELEVATION, AND INVERT OF THE EXISTING UTILITY PRIOR TO STARTING ANY WORK AND VERIFYING THAT THE EXISTING LOCATION AND INVERT ALLOWS FOR THE CONSTRUCTION OF THE PROPOSED SYSTEM AS DESIGNED.

	LEGEND	
	EXISTING	PROPOSED
BUILDING LINE		
DOOR LOCATION		▼
CURB LINE		
PROPERTY LINE		
PARKING COUNT		8
CROSSWALK		IIIIII
PAVEMENT MARKING		≯ →
DIRECTION OF TRAVEL		♪☆
TRAFFIC SIGN		•
SIGN DESIGNATION		♦
CONCRETE SIDEWALK		, p
SAWCUT LINE		<u></u>
CONTOUR		<u>318</u>
SPOT ELEVATION	X 169.60	x ^{317.5}
STORM PIPE		
CATCH BASIN		
AREA DRAIN		
YARD DRAIN		lacktriangle
STORM MANHOLE		•
SANITARY SEWER MAIN	ssss	
SANITARY MANHOLE	S	S
CLEANOUT	0	°CO
WATER MAIN (DOMESTIC)	w w w	UWUW
FIRE PROTECTION	FP FP	———— UFW —————
FIRE HYDRANT	, WV	•
WATER GATE VALVE	o ^{WV} , ⋈	\otimes
SIAMESE CONNECTION	CIV. GV.	Y
GAS VALVE	o ^{GV} , ⋈	⊗
GAS LINE		G-
GAS METER		• <u></u>
OVERHEAD WIRES	OHW	~~~~
UTILITY POLE LIGHT POLE	→, •, ~	<u>U</u>
	×,4	ue.
UNDERGROUND ELECTRIC	— E — E — E — E	———UE———
ELECTRIC MANHOLE	<u>E</u>	
ELECTRIC/TRAFFIC VAULT		T0.E
UNDERGROUND TELECOMM	— T — T — T — T	——— T&E ————————————————————————————————
TELEPHONE MANHOLE		₩ [+]
TRANSFORMER LIMIT OF DISTURBANCE		
SILT SOCK		
PROPOSED INLET PROTECTION		
CONSTRUCTION FENCE		_××
ANTI-TRACKING PAD		
HAYBALES		
ZONE LINES		
BUILDING DOORS		▼

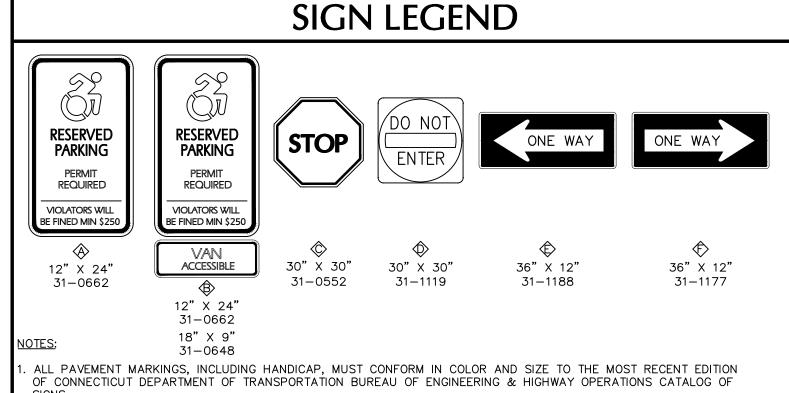

. ABOVE GRADE SIGNS FOR HANDICAP SPACES MUST MEET THE SPECIFICATIONS AS PRESCRIBED BY THE STATE

STATUTE AND THE STATE BUILDING CODE. ALL SIGNS MUST MEET THE REQUIREMENTS AND MOUNTING HEIGHT AS PUBLISHED IN THE MOST RECENT EDITION OF THE CONNECTICUT DEPARTMENT OF TRANSPORTATION BUREAU OF ENGINEERING & HIGHWAY OPERATIONS CATALOG OF SIGNS AND ITS ADDENDUMS (INC. STOP AND FIRE LANE). ALL SIGN SIZES MUST MEET THE REQUIREMENTS AS PUBLISHED IN THE MOST RECENT EDITION OF THE CONNECTICUT DEPARTMENT OF TRANSPORTATION BUREAU OF ENGINEERING & HIGHWAY OPERATIONS CATALOG OF SIGNS AND ITS

ADDENDUMS.

Date Description Revisions



LANGAN Environmental Services, Inc.

555 Long Wharf Drive New Haven, CT 06511

F: 203.789.6142 www.langan.com

CONNECTICL

RECONNECTING THE **RIVERFRONT: PARKER** HARDING PLAZA

FAIRFIELD COUNTY

Drawing Title


MASTER LEGEND &

NOTES

⊃roject No. Drawing No. 140251201 **CS**002 09/14/2023 rawn By CMD

Date: 9/14/2023 Time: 11:34 User: afedus Style Table: Langan.stb Layout: CS002 Document Code: 140251201-0502-CS002-0101

hecked By

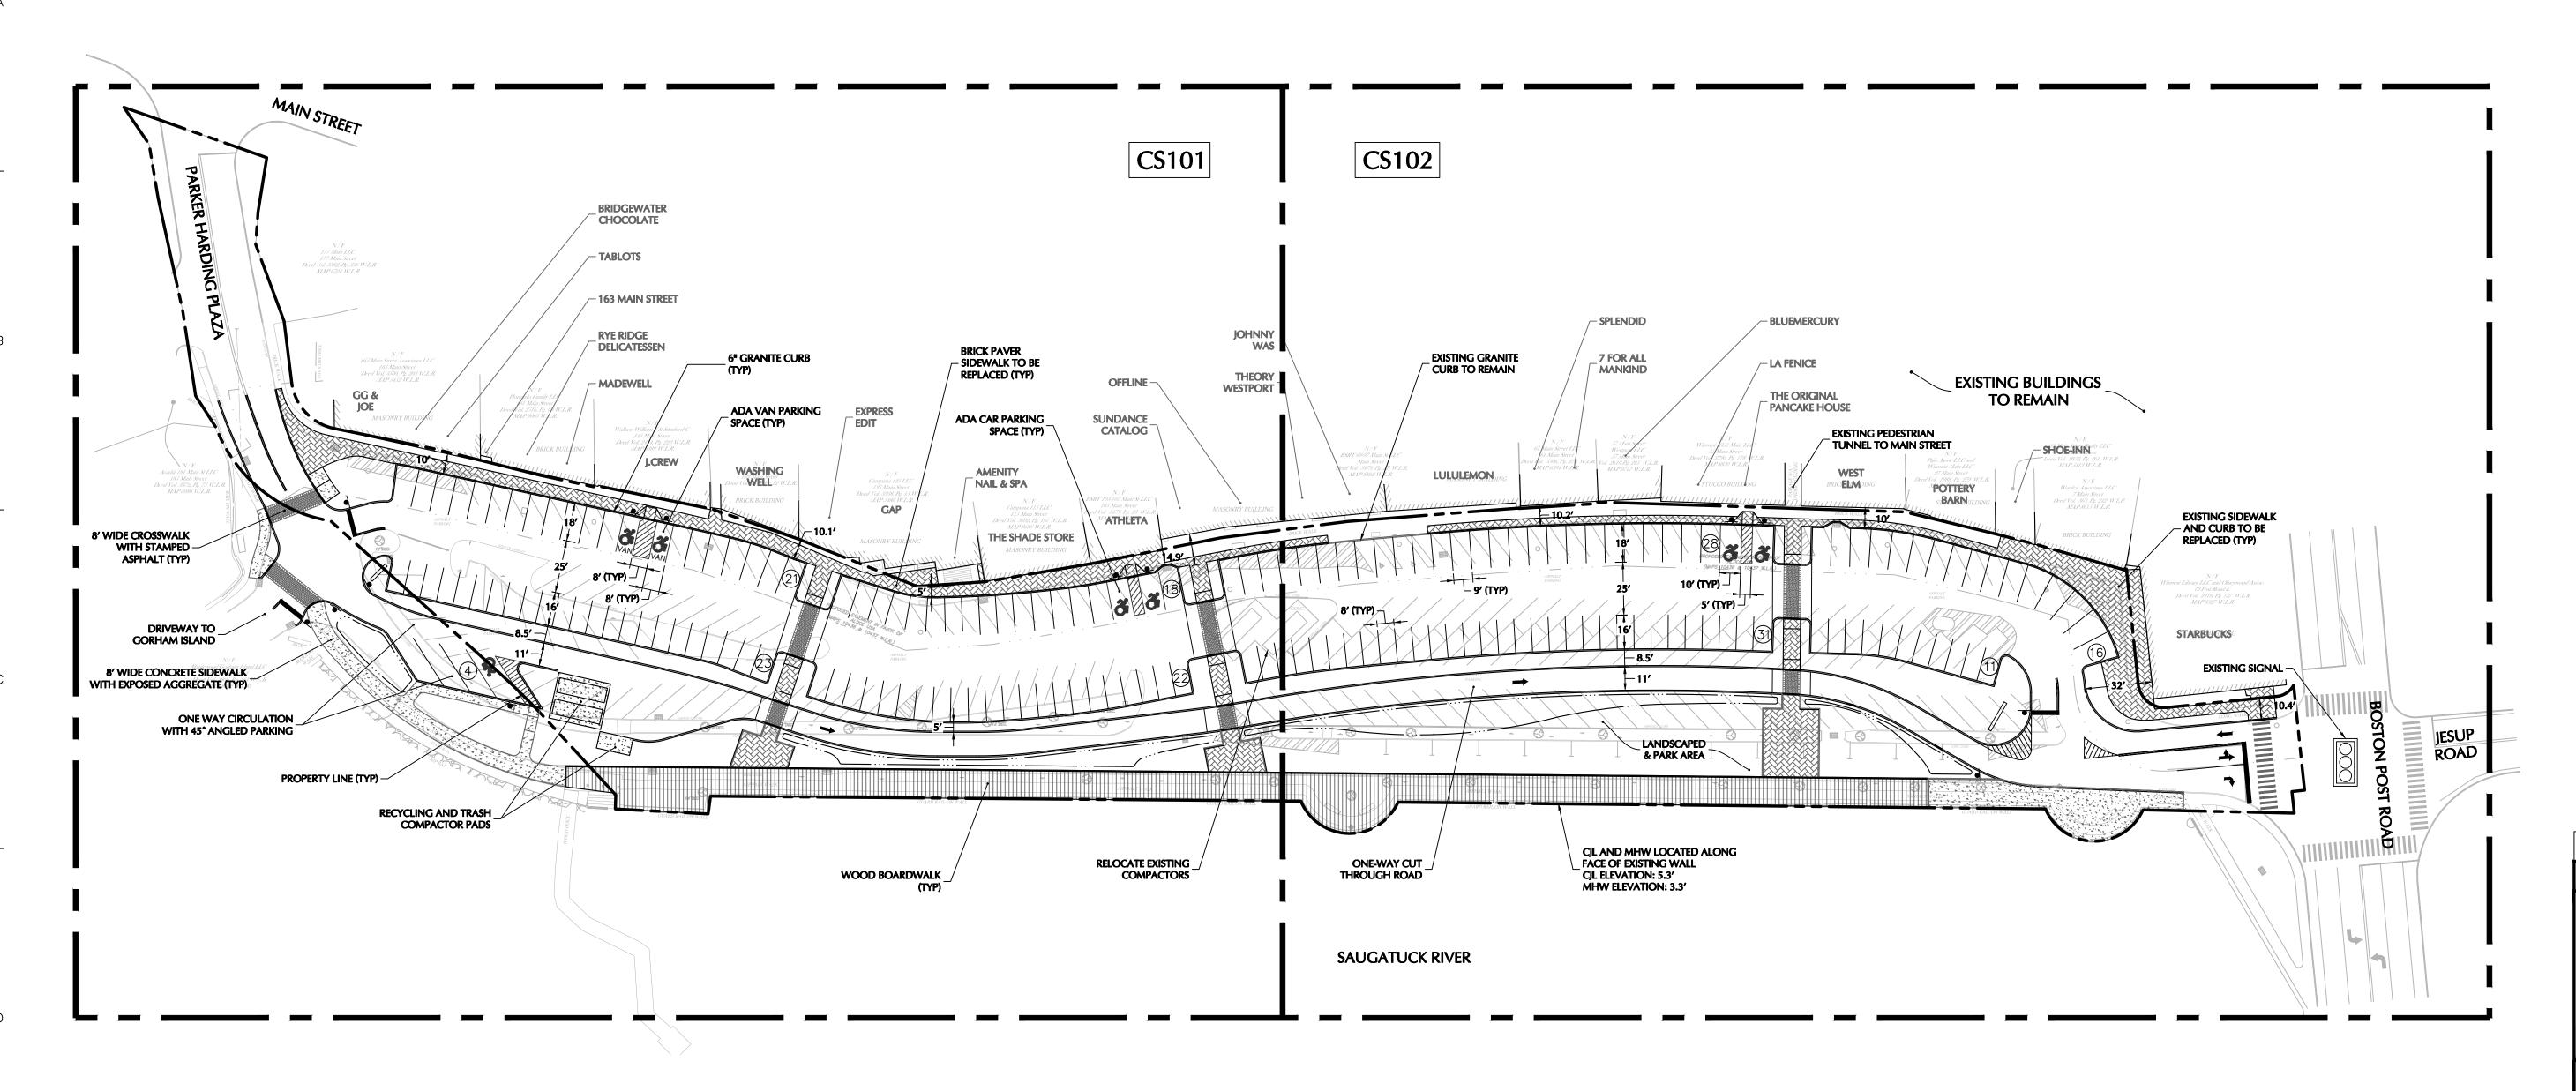

Date Description Revisions



Langan Engineering and Environmental Services, Inc.

New Haven, CT 06511

T: 203.562.5771 F: 203.789.6142 www.langan.com

555 Long Wharf Drive

RECONNECTING THE RIVERFRONT: PARKER HARDING PLAZA

CONNECTICU

FAIRFIELD COUNTY


OVERALL SITE PLAN


140251201 09/14/2023


hecked By

Drawing No. CS100


	PARKING COUNT	
	EXISTING	214
	PROPOSED	174
- [DELTA	-40

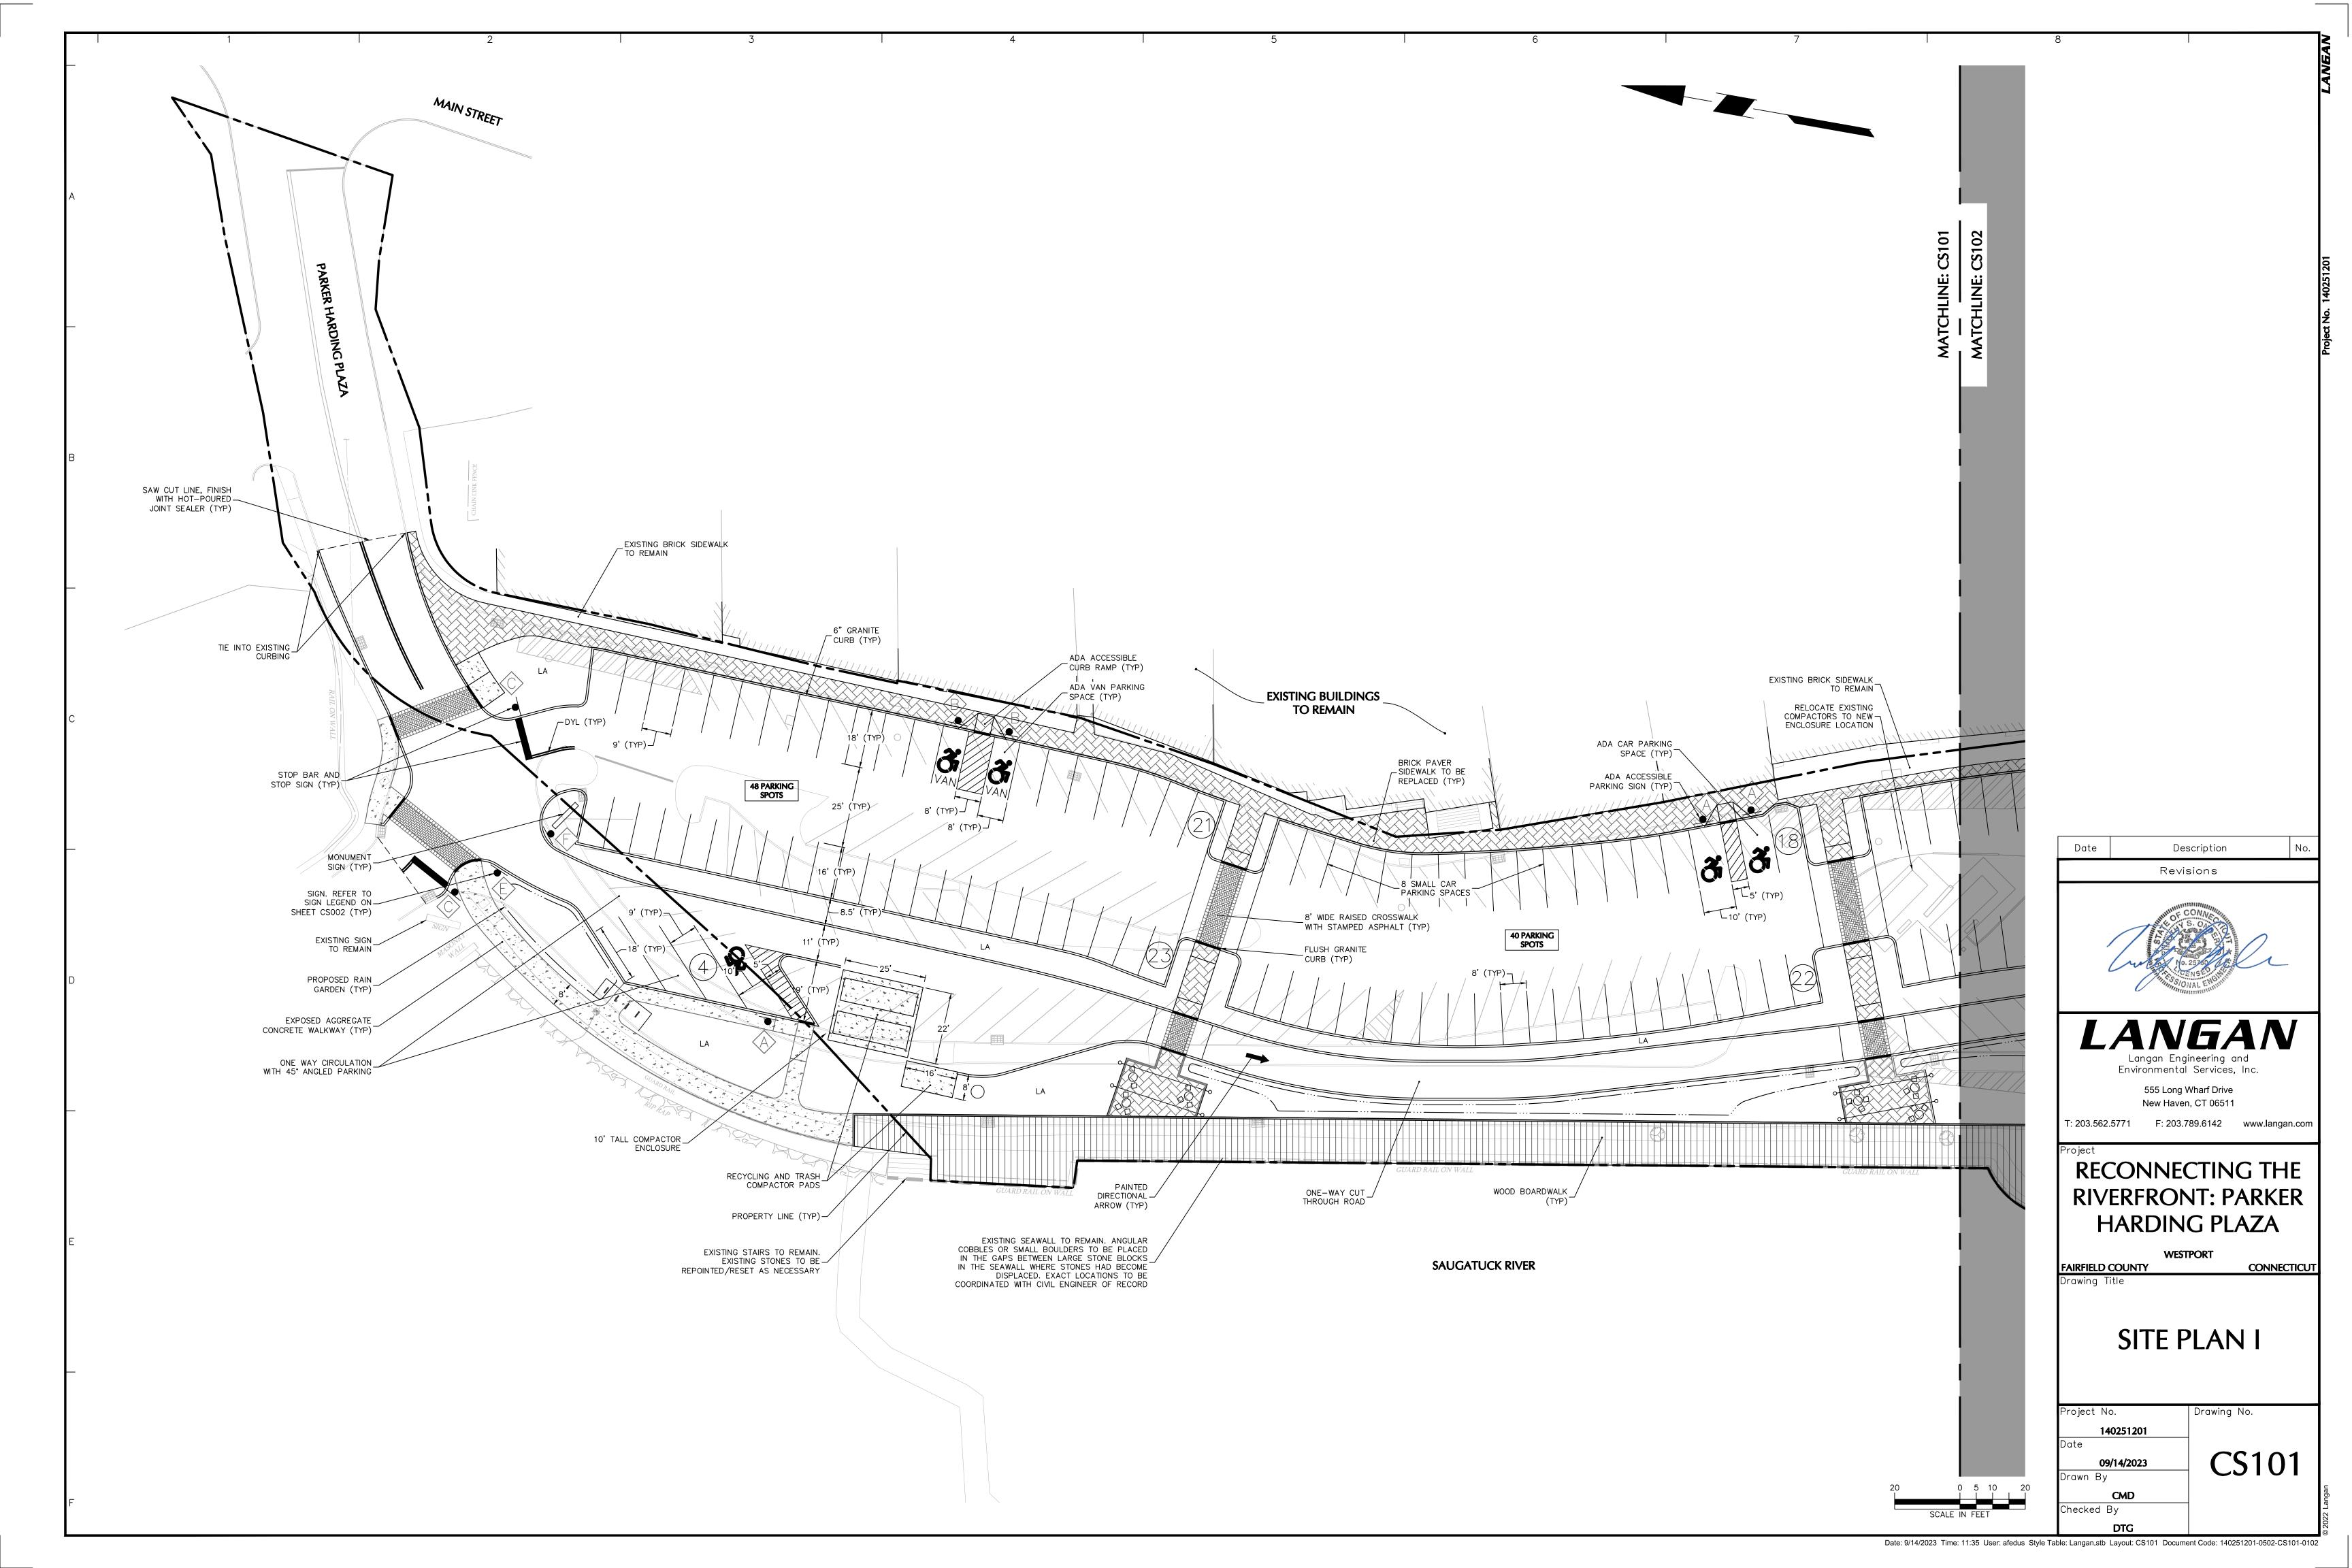


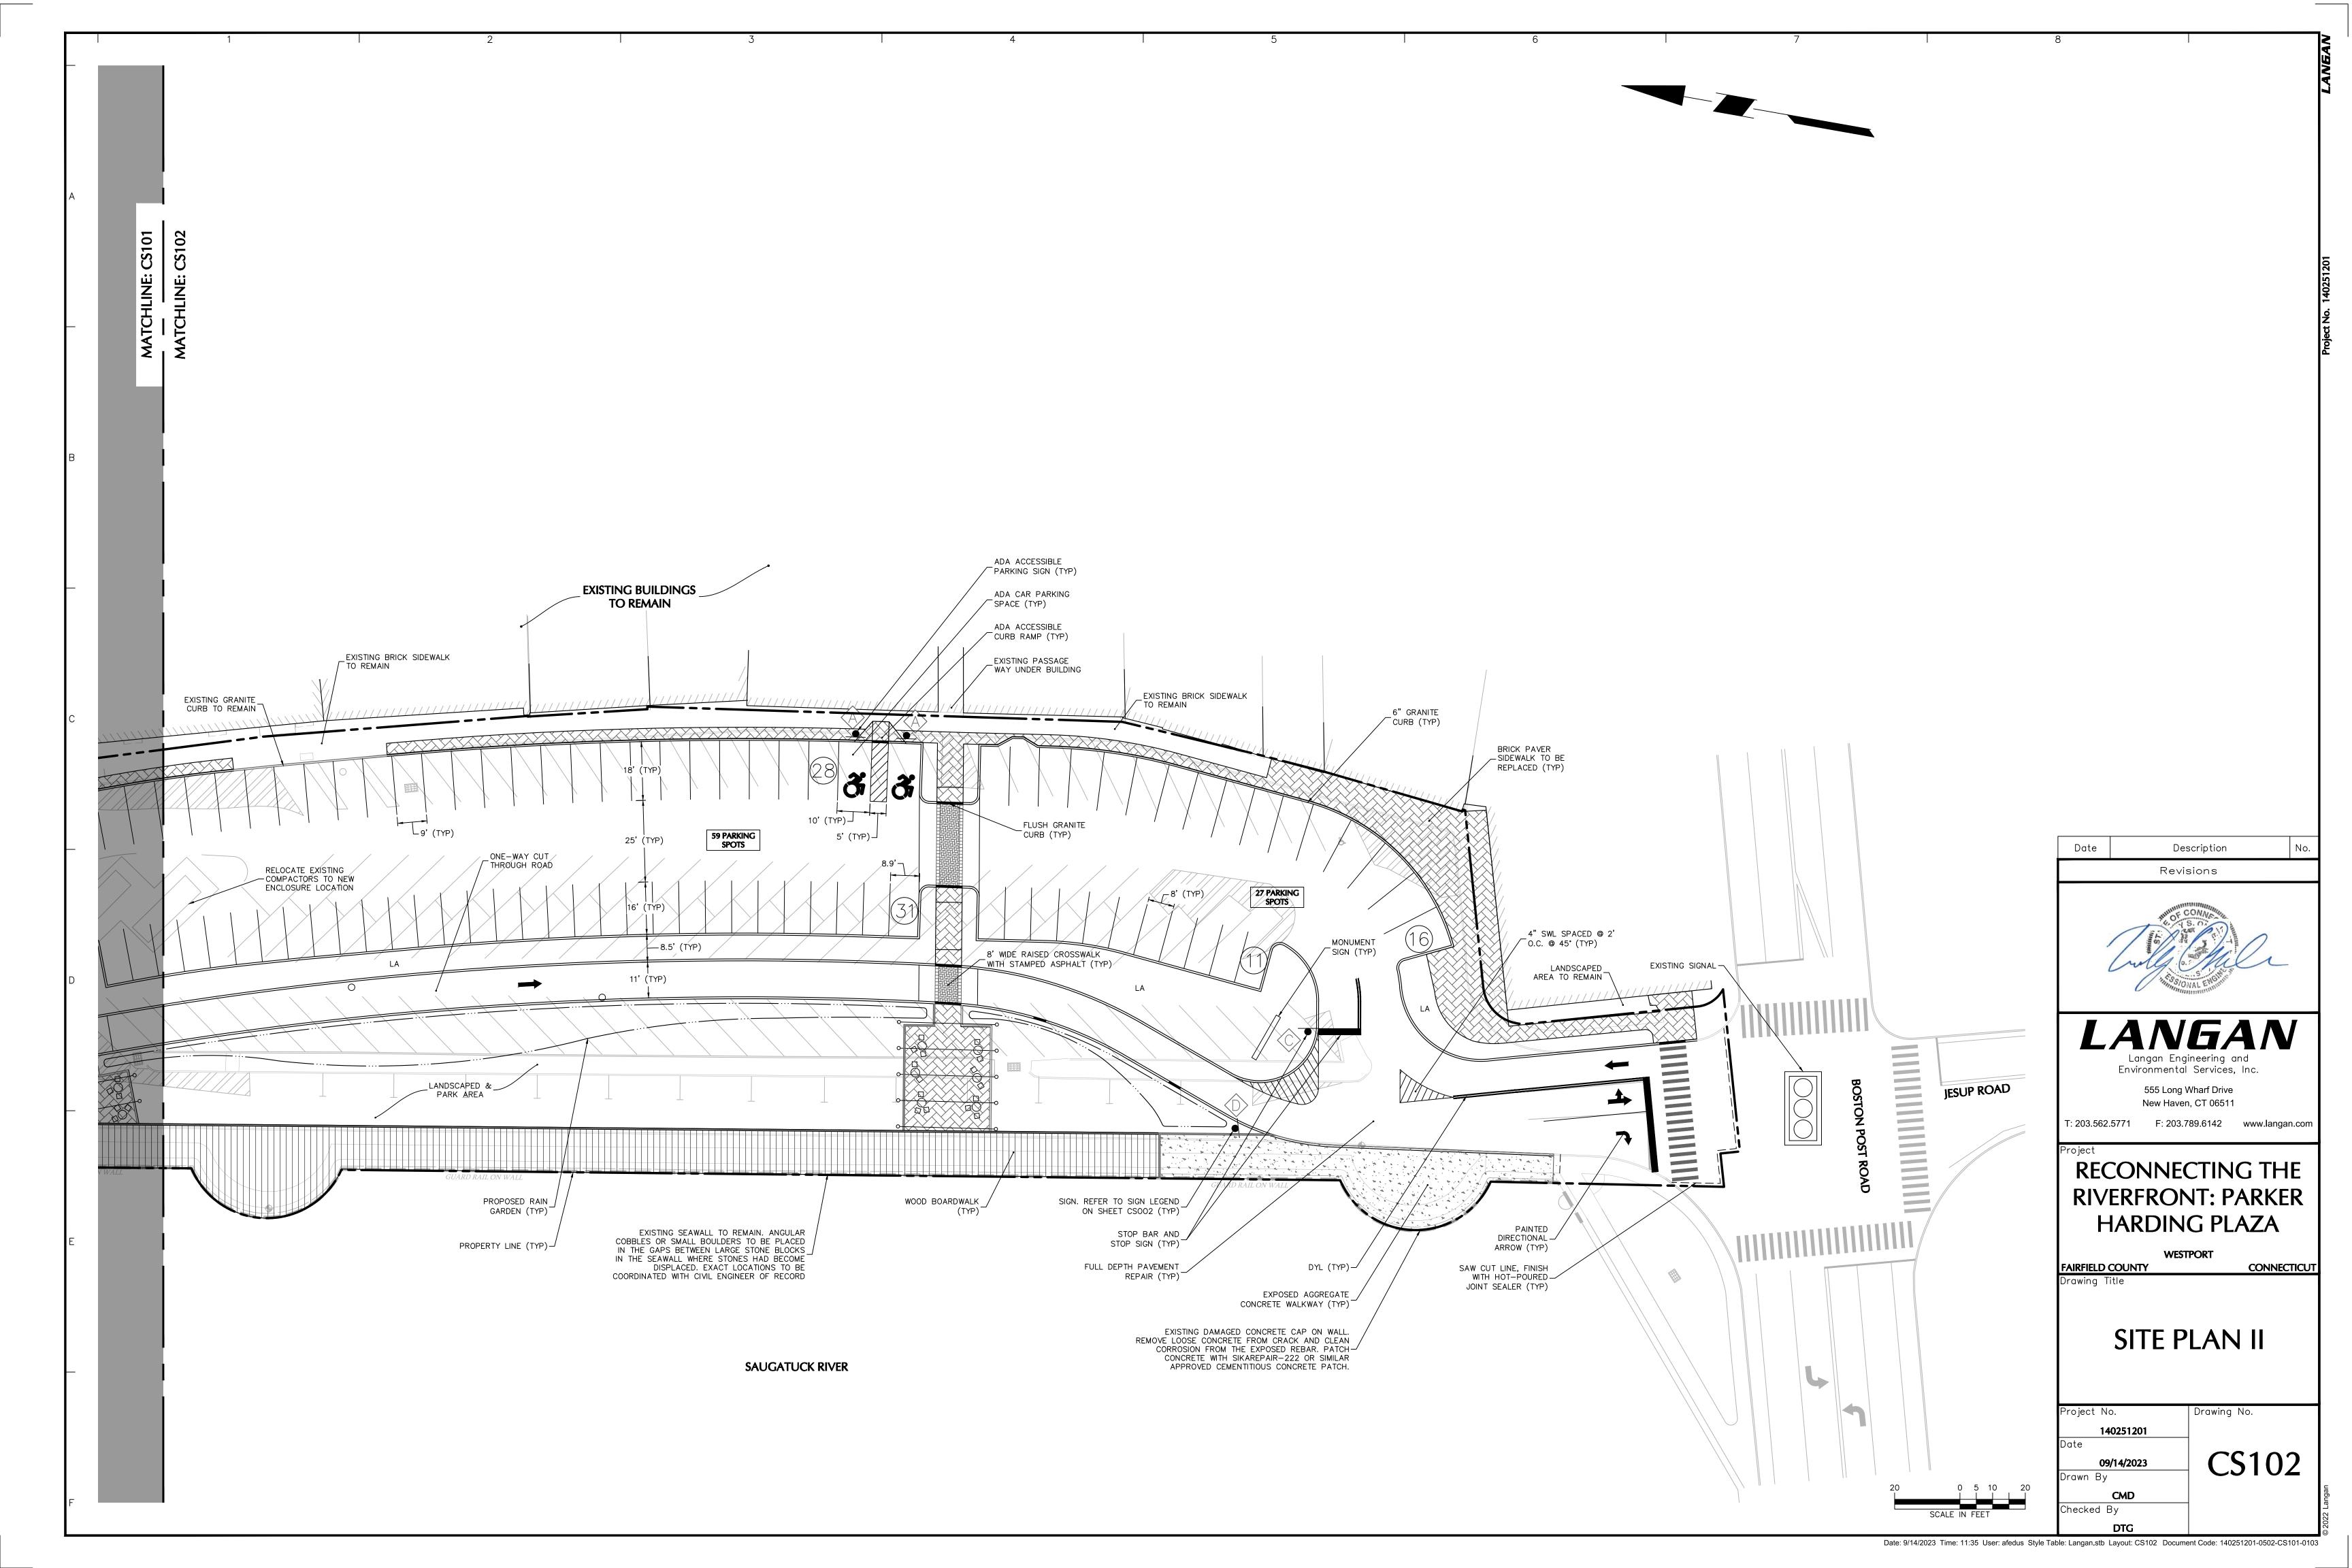


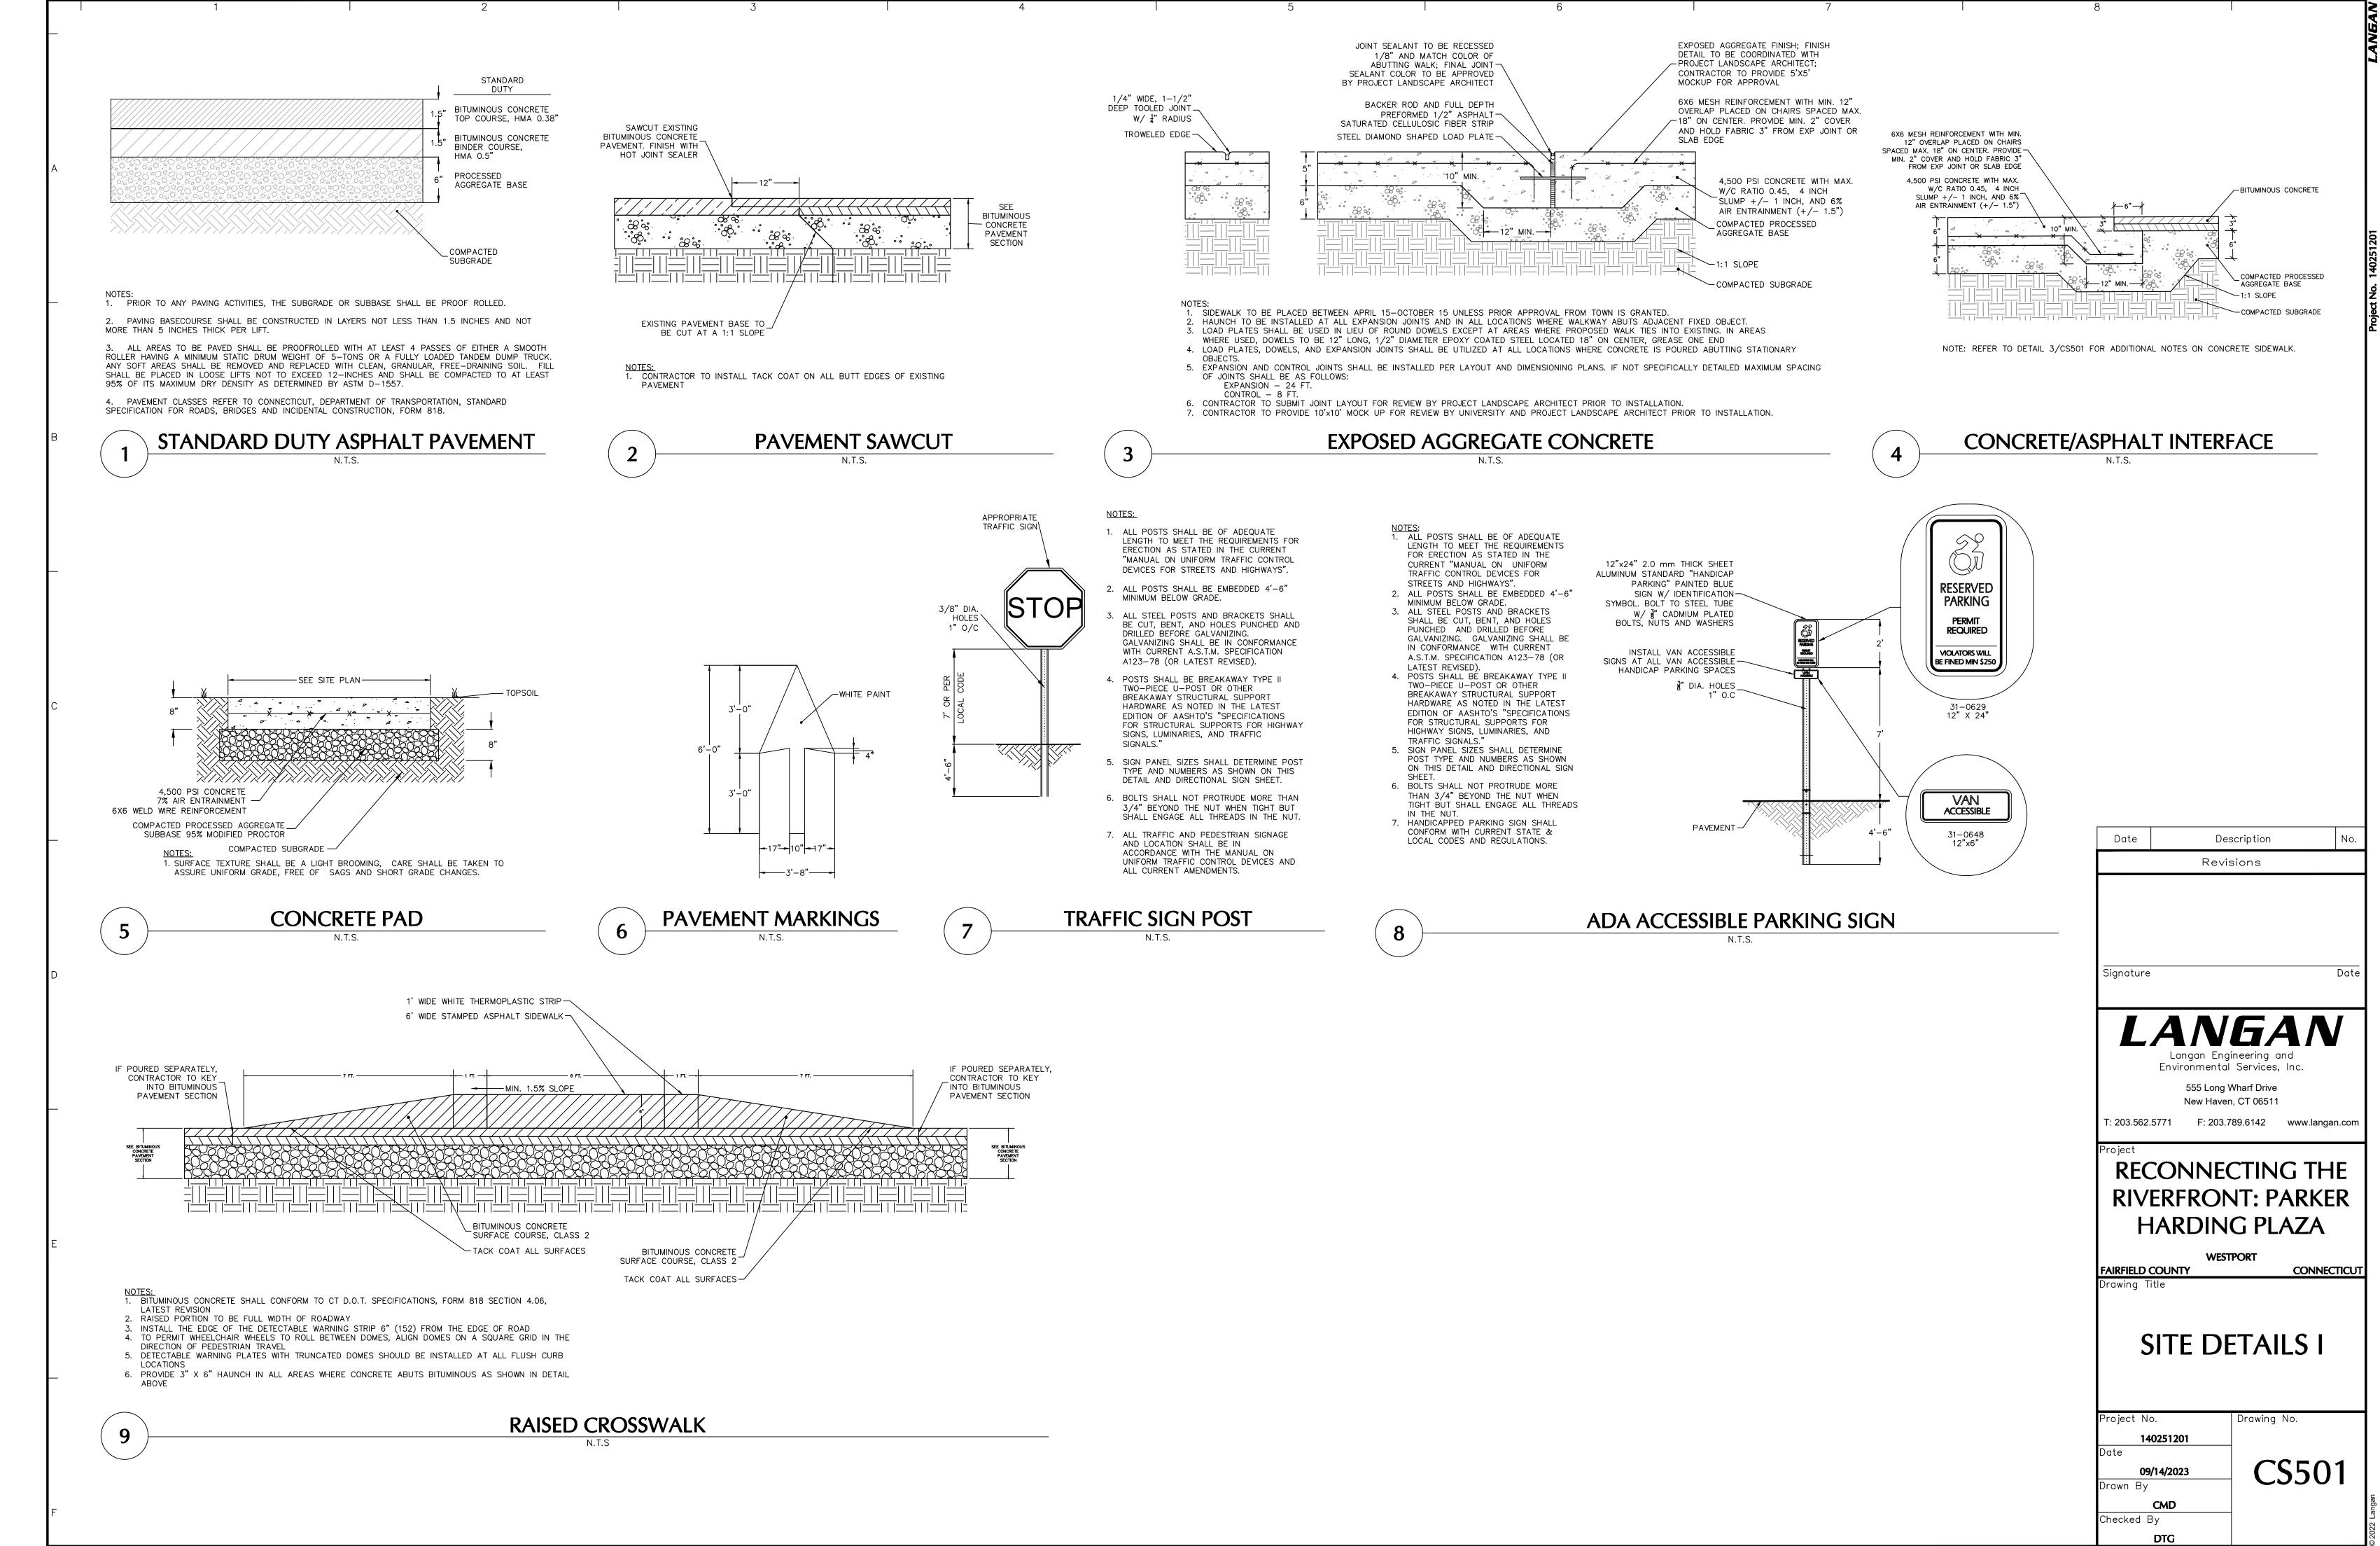



Date: 9/22/2023 Time: 13:43 User: shui Style Table: Langan.stb Layout: CS501 Document Code: 140251201-0502-CS501-0101

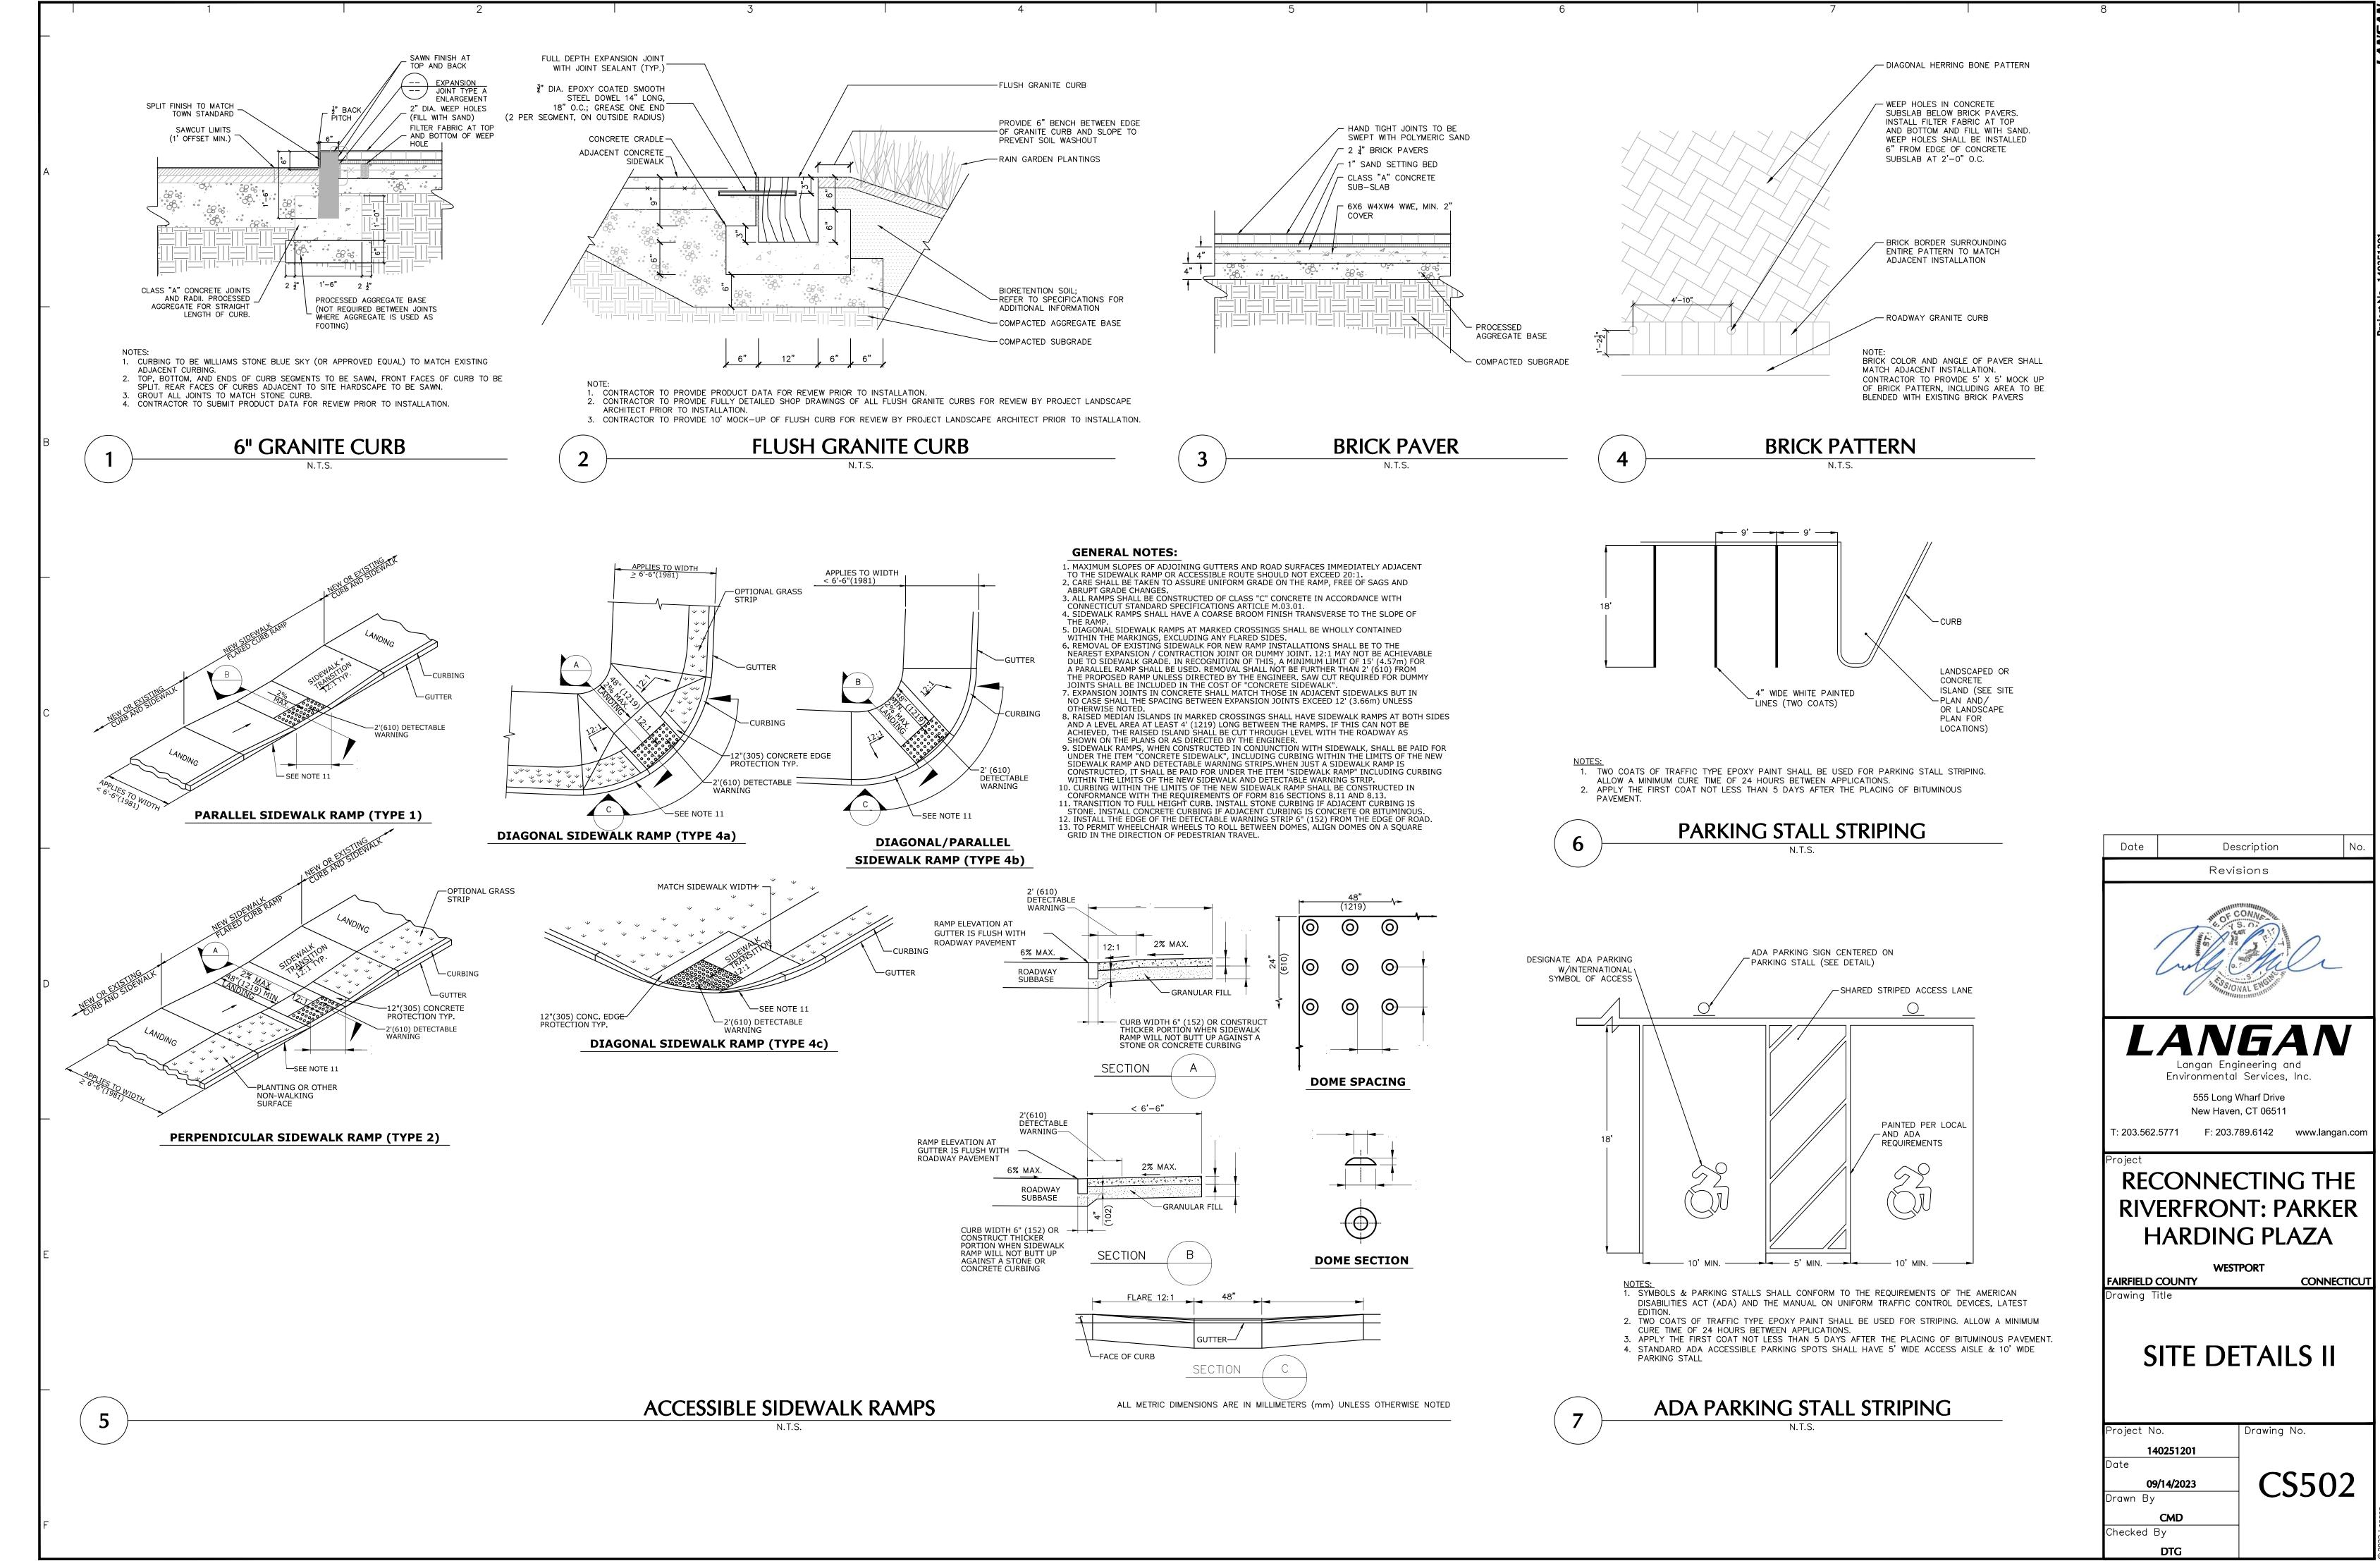

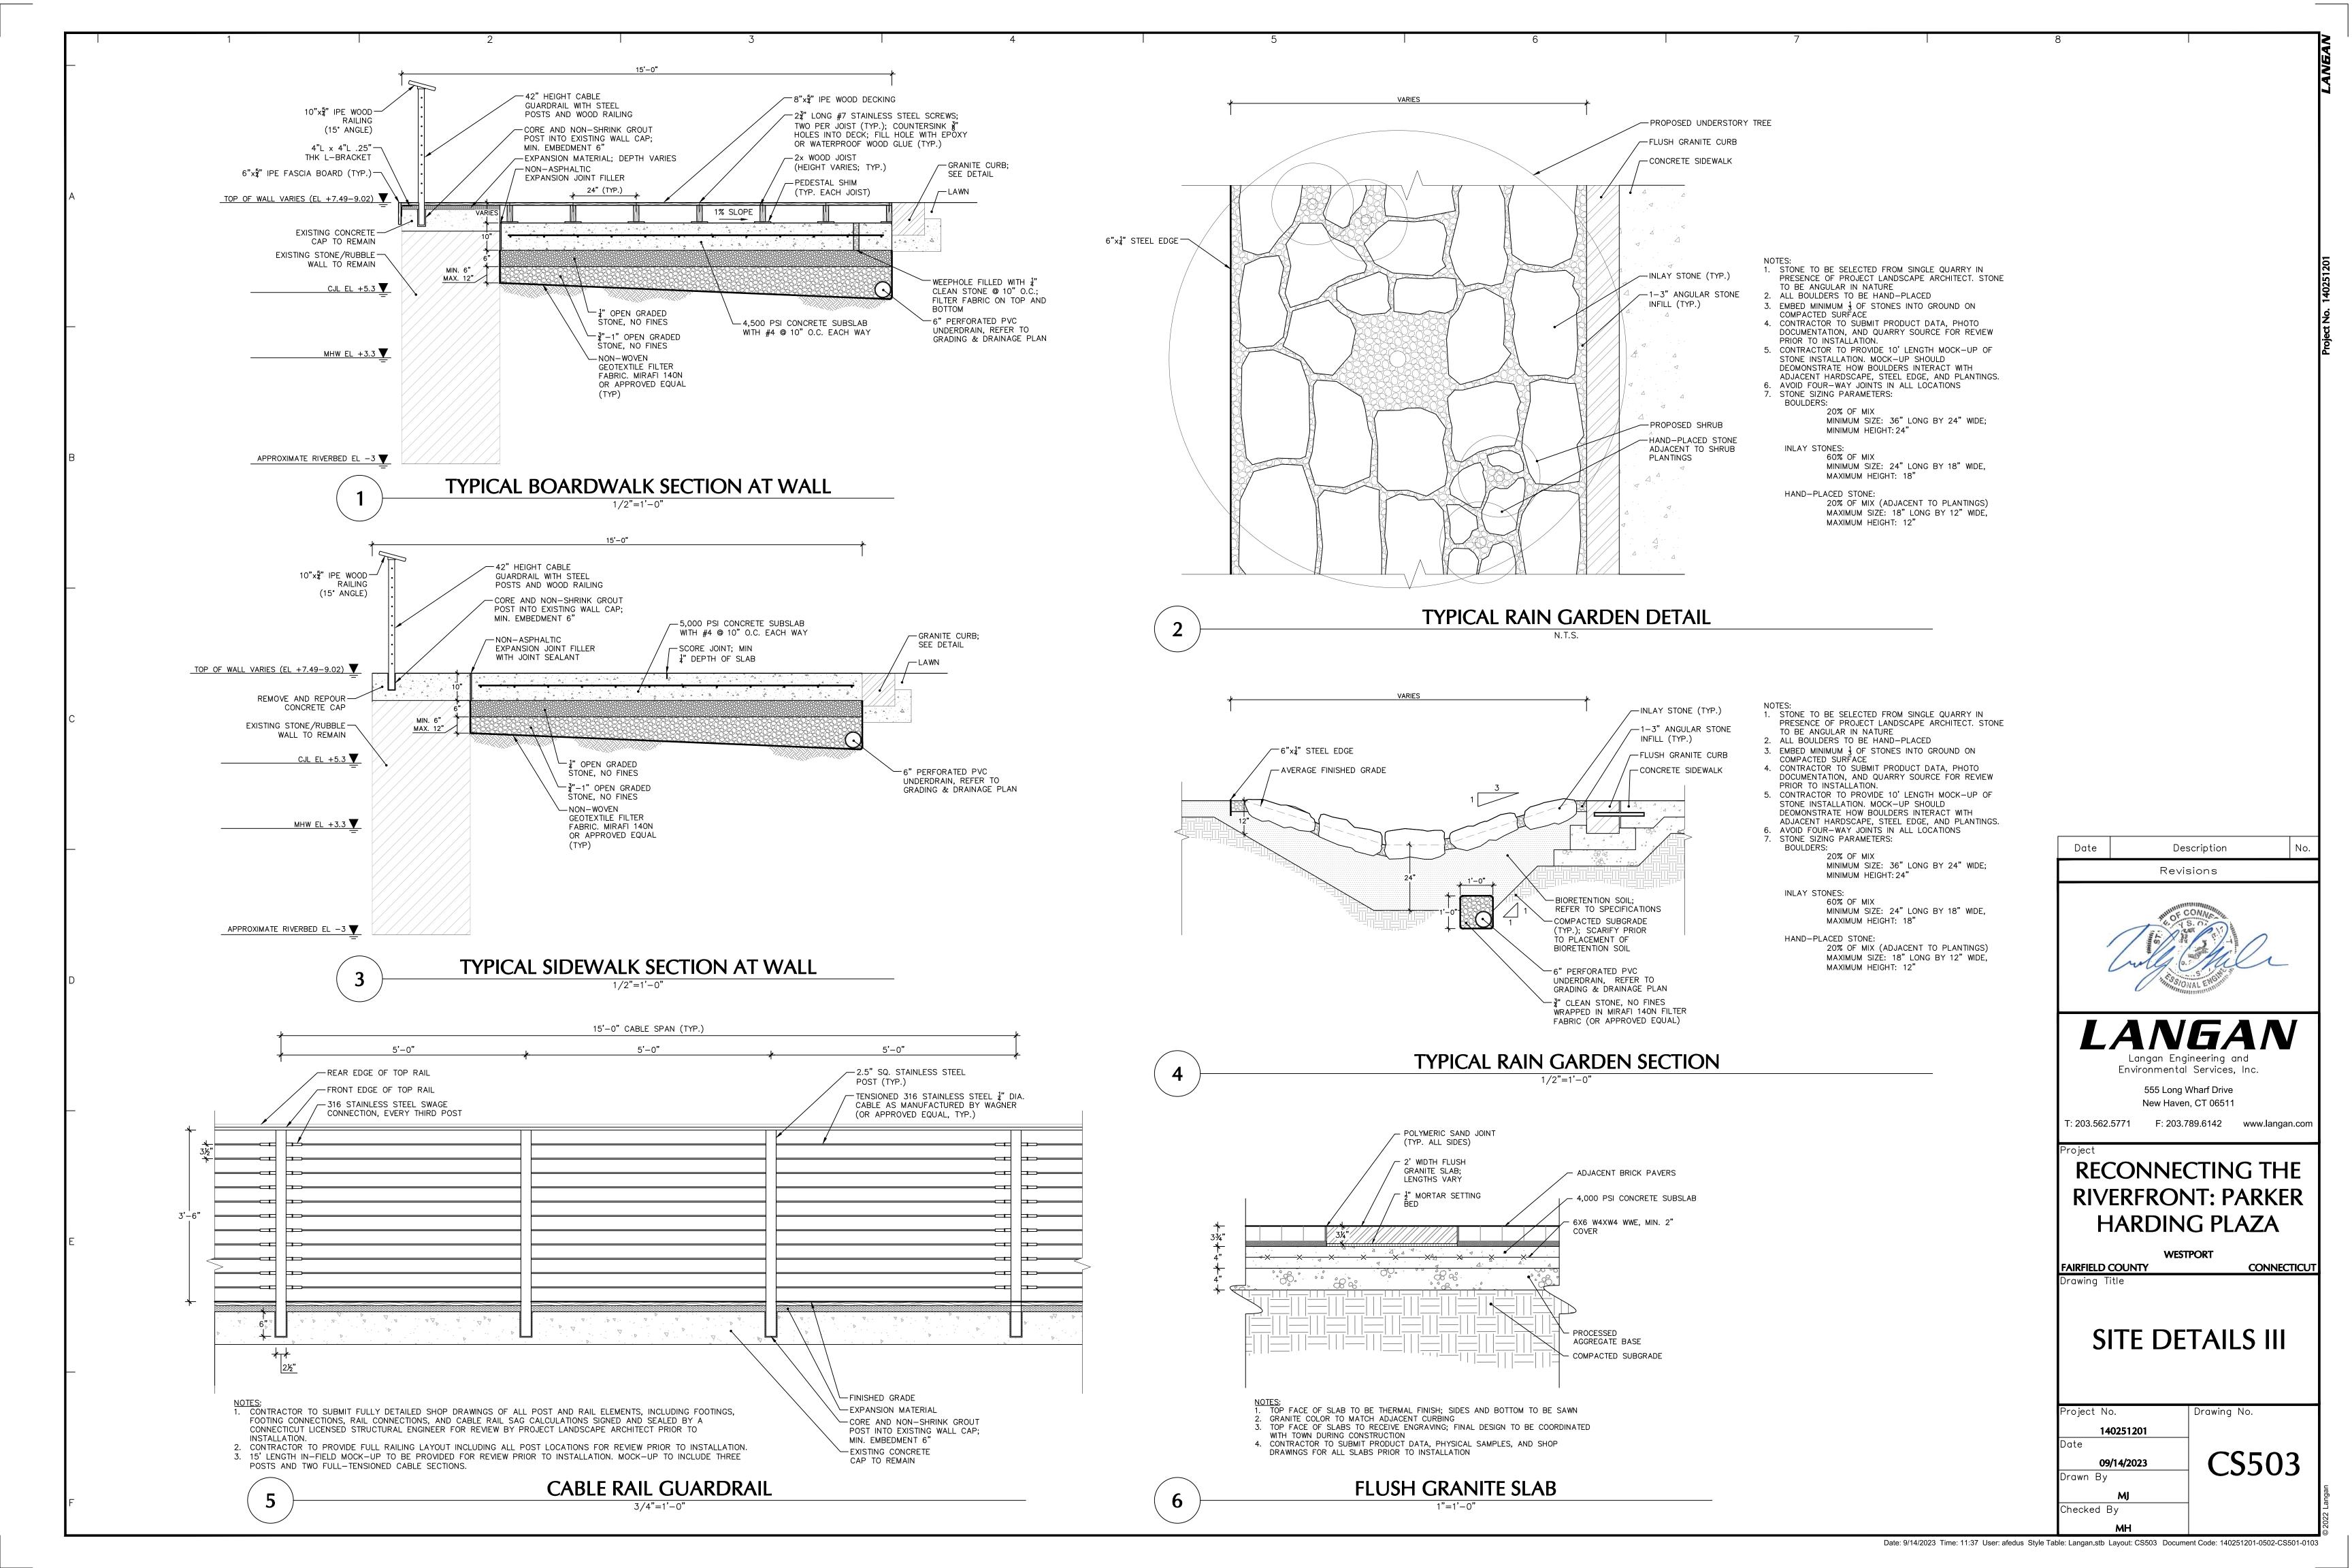

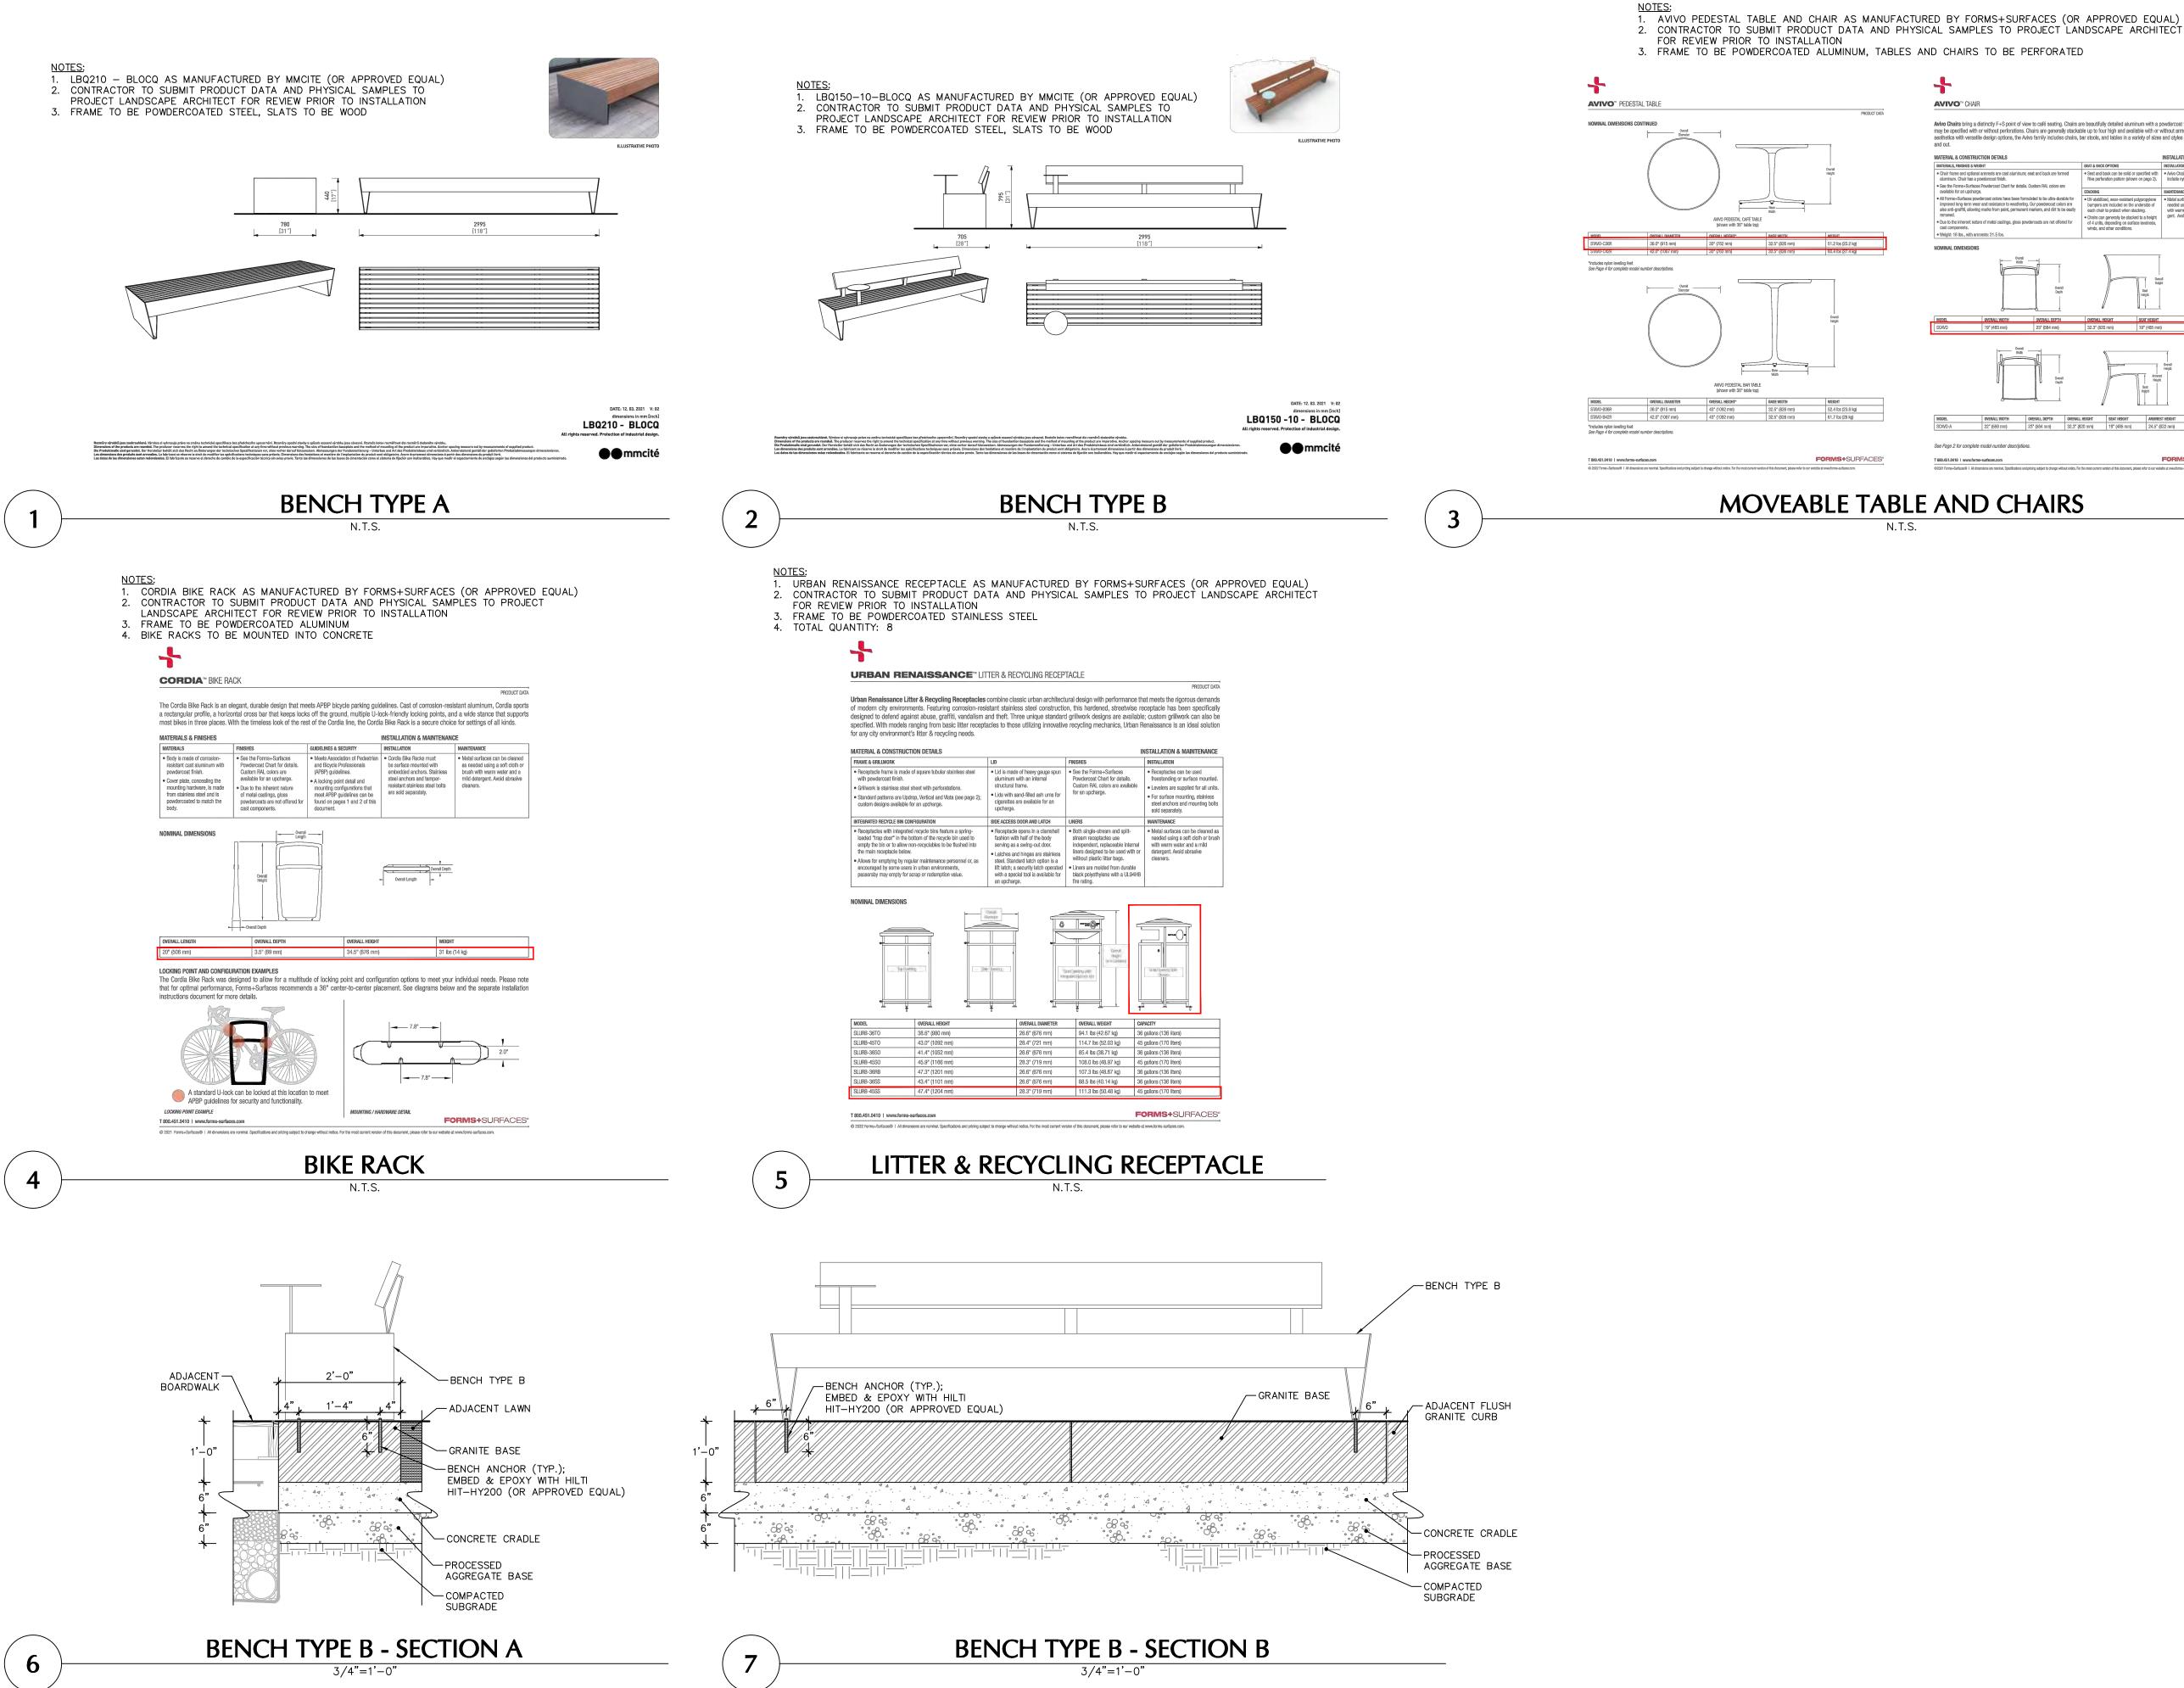

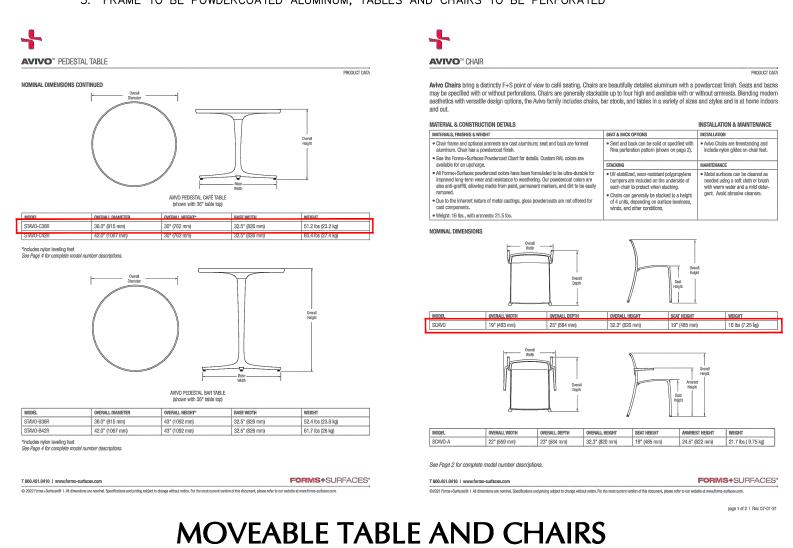

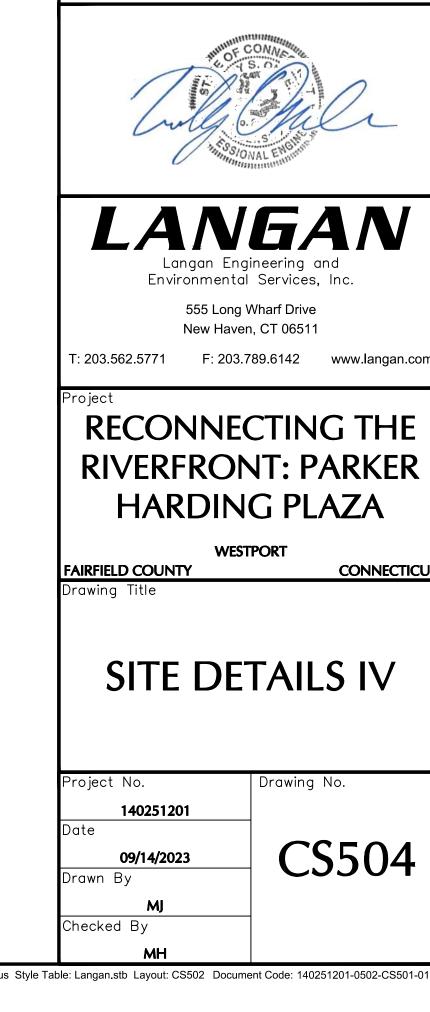

Date

Description

Revisions

