| For Office Use Only: | |
|-------------------------|--|
| Date of Filing: | |
| Date of Public Hearing: | |
| 65 Day Period Ends: | |
| Type of Work: | |

WESTPORT HISTORIC DISTRICT COMMISSION APPLICATION FOR CERTIFICATE OF APPROPRIATENESS (CA)

Application is hereby made for the issuance of a Certificate of Appropriateness under the Historic District Ordinance of Westport, Connecticut, enacted pursuant to the enabling authority contained in Chapter 97A, Section 7-147d and 147s, as amended, of the General Statutes of Connecticut.

| General Statut | es of Connecticut. | | |
|--|---|---|------------------------------|
| SECTION 1 | (To be completed by the Applicant): | | |
| ddress of pr | oposed work: 25 AVERY PL, WESTPORT CT 068 | 80 | |
| wner: WEST | PORT MUSEUM FOR HISTORY AND CULTURE c/o R. | AMIN GENESHRAM | |
| hone: 203-22 | 2-1424 x5 | Email: executived | director@westporthistory.org |
| gent/Contra | CTOT: LYONSPLAIN ARCHITECTURE C/O HANNA P | RZADA | |
| Address: 55 P | OST ROAD, WESTPORT CT 06880 | | |
| Phone: 203 55 | 57 9200 | Email: hanna@h | yonsplain.com |
| | ate of completion: Fall 2023 | | |
| Kam | epuduer . | JUNE 16, 2023 | |
| | ature (Application must be signed) | Date | |
| | ot to comply with regulations rmation needed | | |
| Signature of 2 | rmation needed Zoning Enforcement Officer indicating pre (To be completed by the Historic Distriction) | | ing regulations. |
| Signature of 2 | rmation needed Zoning Enforcement Officer indicating pre | | ing regulations. |
| Signature of Z SECTION 3 Date of Publ | rmation needed Zoning Enforcement Officer indicating pre (To be completed by the Historic Distriction) | | ing regulations. |
| Signature of 2 SECTION 3 Date of Publ Certifica List any | To be completed by the Historic Distriction in Hearing: Attention needed To be completed by the Historic Distriction in Hearing: Attention needed | | ing regulations. |
| Signature of 2 SECTION 3 Date of Publ Certifica List any | Zoning Enforcement Officer indicating pre (To be completed by the Historic Distriction of Appropriateness APPROVED conditions or modifications: ate of Appropriateness DENIED | | ing regulations. |
| Signature of Z SECTION 3 Date of Public Certifica List any of Certifica | Zoning Enforcement Officer indicating pre (To be completed by the Historic Distriction of Appropriateness APPROVED conditions or modifications: ate of Appropriateness DENIED | ct Commission) | ing regulations. |
| Signature of 2 SECTION 3 Date of Public List any of the Certification of | Zoning Enforcement Officer indicating pre (To be completed by the Historic Distriction of Appropriateness APPROVED conditions or modifications: ate of Appropriateness DENIED | Signature/Chair, WHDC | Date |
| Signature of 2 SECTION 3 Date of Publication List any of the Certification List reason and the Certification List reason are been obtained by the Certification List reason are certification and the Certification and the Certification Certificati | Zoning Enforcement Officer indicating pre (To be completed by the Historic District ic Hearing: ate of Appropriateness APPROVED conditions or modifications: ate of Appropriateness DENIED ons for denial: thas been obtained from the Historic District Coinced from the Planning and Zoning and Build (To be completed by the Historic District | Signature/Chair, WHDC Commission, work cannot commence until preding Departments. | Date |



Historic District Commission

Town Hall, 110 Myrtle Avenue Westport, CT 06880 Westportct.gov Telephone (203) 341-1184

WESTPORT HISTORIC DISTRICT COMMISSION LEGAL NOTICE

Meeting ID: 841 6063 7609 Passcode: 050849 Dial by your location • +1 646 876 9923 US (New York)

Join Zoom Meeting

https://us02web.zoom.us/j/84160637609?pwd=Uk40cXhWa0xTQkFST09nU1pkVERCZz09

The Westport Historic District Commission will hold an electronic public meeting at **7:00 p.m.** on **Tuesday**, **July 11, 2023**, for the following purposes:

- To take such action as the meeting may determine to approve a Certificate of Appropriateness application dated June 7, 2023, for proposed new decking at 10 Gorham Avenue (PID # D11//026/000) which is located within the Gorham Avenue Local Historic District.
- To take such action as the meeting may determine to approve a Certificate of Appropriateness application dated June 7, 2023, for proposed addition on house and addition of a new cabana at 75 Kings Highway North (PID # C09//026/000) which is located within the Kings Highway North Local Historic District: Kings Highway North National Historic District.
- 3. To take such action as the meeting may determine to approve a Certificate of Appropriateness application dated June 16, 2023, for proposed repairs and alterations of roofing, gutters, downspouts, siding, trim, wood details, windows, doors, shutters, and masonry at 25 Avery Place (PID # C10//130/000) which is a locally designated property.

Grayson Braun, Chair Historic District Commission June 27, 2023

Special Notice Regarding This Electronic Meeting:

Pursuant to Public Act 22-3, there will be no physical location for this meeting. This meeting will be held electronically. Telephone and Zoom video participation details are above. Comments from the public will be received during the public meeting. A copy of the applications and Historic District Commission agenda for the meeting is available on-line at www.westportct.gov and on the Town Calendar web page under July 11, 2023.

It is the policy of the Town of Westport that all Town-sponsored public meetings and events are accessible to people with disabilities. If you need assistance in participating in a meeting or event due to a disability as defined under the Americans with Disabilities Act, please contact Westport's ADA Coordinator at 203-341-1043 or <a href="efficience-of-section-needing-needing-of-section-needing

OWNERS AUTHORIZATION FORM

For Properties Located at 25 Avery Place, located in the Westport Historic District.

Submission Date:

- 1. Address of Property: 25 AVERY PLACE, WESTRORT, CT
- 2. Owner of Record: WESTPORT HISTORICAL SOCIEN IN.
- 3. Daytime Tel #: 203・223 142イ
- 4. E-mail: executive director @ westport history, org
- 5. Agent's Name: HANNA PRZADA, LYONS PLAIN MECHITETURE
- 6. Agent's Address: 55 POST ROAD, WE STORT, CT OBER
- 7. Agent's E-mail: hanna@lyonsplain.com

I, RAMIN GAMESHE AT, am the authorized representative of the property located at address:

25 Avery PI, Westport CT 06880

I hereby authorize Lyonsplain Architecture, and their subcontracting companies, to act as my Agent for the limited purpose of applying for and obtaining local building and other permits from the Authority Having Jurisdiction as required for the installation of exterior restorations on my property.

This authorization includes the transfer/re-administering, and/or cancellation of any existing permits on file for the purpose of updating/applying with an alternate subcontractor.

Signature: Canunfusk

Print Name: RAMIN GANESHERM

Date: 8/6/2023

LYONSPLAIN ARCHITECTURE

BRADLEY-WHEELER HOUSE PROPERTY DESCRIPTION

Bradley Wheeler House, 25 Avery Place. c.1867, Italianate

Local Historic Property, Wheeler House National register Historic Property, Westport Center National Register District, Myrtle Avenue State Historic District, Village District Overlay

The Bradley-Wheeler House is located on the north side of Avery Place, a street which adjoins both Myrtle Avenue and Main Street in the downtown area of the Town of Westport. The property is surrounded by a wrought iron fence with intermittent concrete piers.

Originally built in 1795 by Captain Ebenezer Coley for his son, Michael, the house used to be a Colonial-style saltbox structure. There are no known visual representations of this first house and any remnant of this first home have been either obscured or erased by subsequent modifications; the house was remodeled in the Italianate style around 1867.

The Bradley-Wheeler House is a two-and-a-half story Italianate-style structure with five bays and a low-pitch roof surmounted by a cupola with a flat seam lead-coated copper roof. The cupola has windows surrounded by flat moldings on each of its four faces with remaining area covered by flush boards. It is topped by a bracket finial. To the east and west of the cupola, are brick chimneys with a third chimney centered against the north wall of the ell at the rear of the main structure. The roof has wide eaves which terminate at a corona with a crown molding. There are no brackets beneath the eaves. The roof is coated with rolled roofing with a perimeter of lead-coated copper and has built in gutters.

Below the eaves is a wide frieze with pairs of round eyebrow windows. These only occur on the original antique structure. There are three pairs of eyebrow windows on the front and rear and two pairs on either side. The south elevation has five six-over-six windows on the second floor. The first floor has two pairs of glass French doors on either side of the centrally located front door with etched glass panels. The front door is accessed by a wooden porch with a lead-coated copper clad hipped roof supported by four pedestals with molded bases and plinths beneath chamfered square columns. Molded capitals engage curved brackets which support the frieze. On the east elevation, there is a first-floor bay-window with adjacent to a pair of six-over-six sash windows. The second floor two bays each with a six-over-six window. These are surmounted by a wide frieze with two pairs of round eyebrow windows. The west elevation has two six-over-six sash windows on the first floor and two, symmetrically placed six-over-six sash windows on the second floor. All windows have molded, Italianate-style pediments.

On the northern side of the original building is a two-story ell. The east elevation of the addition has two six-over-six windows on the second floor and a symmetrically placed six-over-six window and door on the first floor. The same symmetry is seen on the north and west facades of the ell. There is a hip roof porch that extends over the eastern side of the ell to a one-story annex connecting the main structure to an octagonal gallery with a standing seam metal roof. The porch has a wood deck and rests on piers and concrete retaining wall. The western side of the annex has a concrete ramp with wrought iron railing.

Aside from the flush boards on the first floor of the front porch, the entire museum is finished with narrow corner boards, water tables and clapboard siding. The foundation of the antique building is fieldstone parged with cement. The newer annex and gallery have foundations of concrete with a veneer brick on the exterior.

WESTPORT MUSEUM BRADLEY - WHEELER HOUSE

EXTERIOR REPAIRS AND IMROVEMENTS

25 AVERY PLACE WESTPORT, CT 06880

HDC PERMIT SET

ABBREVIATIONS PCF PCT CONC PERF PERI PFN face of masonry face of stud acoustical acoustic board asphaltic concrete access access pane floor sink panel (ed) (ing) above finished floor prestressed concrete gage, gauge galvanized grab bar area line pressure alarm bounds per square foc pounds per square inch post-tensioned concrete general contract (or) paper towel dispenser galvanized iror poly vinyl chloride glass, glazing glass block gloss galvanized pipe beam bottom of bottom rubber base reference refrigerator register reinforce (d) (ing) hose bibb hardboard hollow core heavy duty header hardware hexagonal height hollow metal built-up roof code blue rough opening right of way horizontal control joint service sink square feet (foot) semi-gloss sheet sheathing similar iron pipe size concrete masonry unit (s) sleeve sheet metal screw COL COMB COMP COMPO COMPT CONC CONST CONT CONTR combination compress (ed) (ion) (ible) soundproof spacer specification (s) composition, composite knock-out concrete construction length laboratory ladder laminate lavatory label left hand live load low point light contract (or) station standard seating steel storage structure (al) corrugated carpet (ed) (ing) ceramic tile counter flashing cubic foot (feet) suspended spray vinyl louver lightweight lightweight concrete symmetrý (ical) synthetic system tongue & groove tread (s) towel bar meter (s) med gàs alarm pane tinted telephone tempered thick (ness) tack board maximum machine bolt dimension (s) division dead load mechanical medicine cabinet metal floor decking top of plate manufacture (r) tolerance top of steel top of wall magnetic hold open downspou dispenser detail drawing drawer toilet paper dispenser toilet partition miscellaneous molding, moulding millimeter (s) thermal tube steel top of slab treated television typical membrane` elevation movable electric panel board metal roof deck mounted metal furring metal threshold unless noted otherwise mullion millwork urinal elapsed time vacuum varies, variable electric water coole vapor barrier natural vinyl base EXH EXIST or E EXP JT or EJ not in contract verify in field vinyl tile nonmetallic nitrous oxide vinýl vertical joint fire alarm annunciator pane noise reduction noise reduction coefficien vermiculite face brick not to scale vinyl wall covering oxygen overall obscure fixed equipment fire extinguisher cabinet on center outside diamete with without wood base actory finish opposite hand overhead nished floor line window opening opposite wall hung _{_} flat head machine screw waterproof (ing

operating room

panic bar particle board

ire hose station


flat head wood screw


working point water resistant

zone valve box

wainścot wall to wall

TITLE SHEET - GRAPHIC SYMBOLS

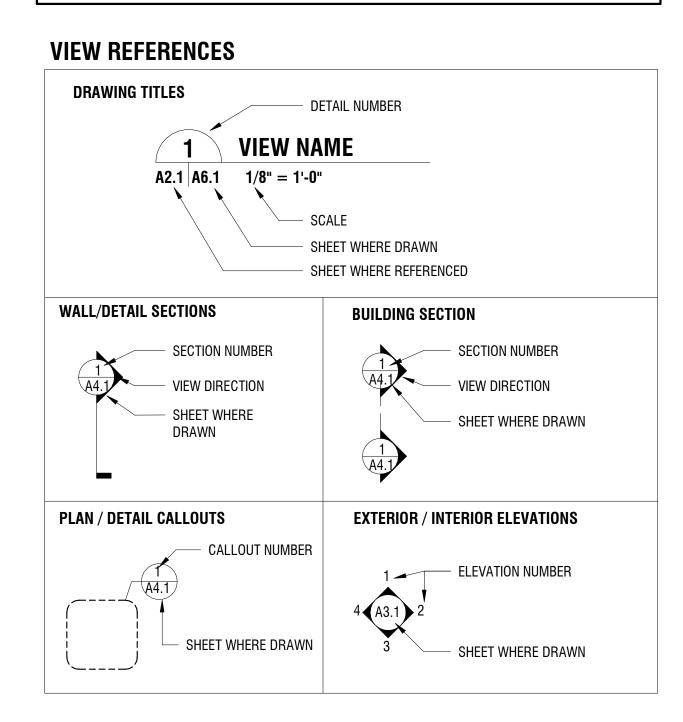

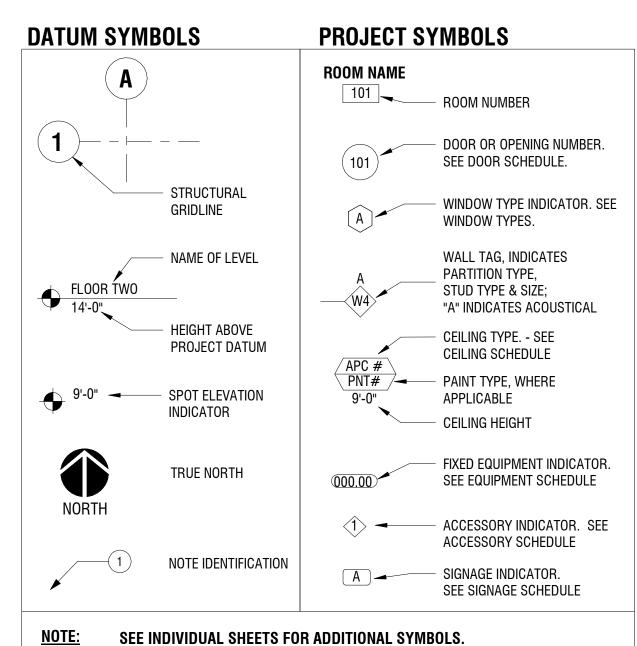

PROJECT TEAM

CLIENT

THE WESTPORT MUSEUM FOR HISTORY AND CULTURE 25 AVERY PLACE WESTPORT, CT 06880

ARCHITECT

LYONSPLAIN ARCHITECTURE AND DESIGN

WESTPORT, CT 06880

SHEET INDEX

0 GENERAL

TITLE SHEET **SPECIFICATIONS**

2 ARCHITECTURAL

LOWER LEVEL FLOOR PLAN FIRST FLOOR PLAN **SECOND FLOOR PLAN** ATTIC FLOOR PLAN **ROOF PLAN**

EXTERIOR ELEVATIONS EXTERIOR ELEVATIONS EXTERIOR ELEVATIONS

DOOR SCHEDULE, TYPES, DETAILS, AND NOTES

WINDOW SCHEDULE & TYPES WINDOW SHUTTER TYPES **TYPICAL DETAILS**

PROJECT NARRATIVE

SCOPE OF EXTERIOR REPAIRS AND ALTERATIONS

ROOFING:

Low Pitch Roof as shown On The Drawings:

Replacement of an existing EPDM roofing system-

Repairs and/ or restoration of Yankee gutters with Zinc-Coated Copper gutter liners and flashing.

Low-Pitch Avery Place Porch Roof:

 Replacement of an existing Lead- Coated Copper front porch roofing with Zinc-Coated Copper roof. Roofing layout and seam design to match exiting. See photos.

Gutters and Downspouts:

 Replacement of existing powder-coated aluminum downspouts and Lead-Coated Copper with Zinc-Coated Copper downspouts to match the newer units along.

EXTERIOR WOOD SIDING, RUNNING AND STANDING TRIM AND EXTERIOR ORNAMENTAL WOOD DETAILS:

- Lap Siding, Ship-Lap Siding, Wood Window and Door Casing, Running and Standing Trim, Exterior Ornamental Wood Details: Strip, scape, repair and restore. Dutchman repairs and/or replacement of any rot or damaged pieces with like and kind materials and profiles.
- Front Porch Decking: Restore and repair, replace where necessary with Vertical Grain Douglas Fair

Match size and layout. Prime and paint.

WINDOWS, DOORS, AND EXTERIOR SHUTTERS:

- Shop restoration of existing window sashes, door slabs and shutters. Strip, scrape, prime and paint all windows and doors. Remove, clean and reinstall all glazing. Any damages glass to be replaced with alike historic glass, Reglaze with Sarco putty, match putty profiles with existing. Restore and repair existing hardware. Replace with like and kind if existing cannot be restored.
- Window and Door Frame Restoration: Strip and Scape frames onsite. Repair and replace any rot and damages pieces of frames, casings or sills with epoxy and dutchman where necessary. Prime and
- New storefront windows and entry door to be custom-fabricated. Solid mahogany, entrance lock door set to match existing, and as required by code. Door and windows to be primed and painted.

MISCELLANEOUS MASONRY:

- Chimney repointing and flashing repairs as needed. Match mortar color and texture. Mortar type: N,
- Replace broken brick veneer wall with like and kind brick, replace broken bluestone cap at guardrail
- Repoint brick as needed, ensure weep holes are at 8"-14" above finish grade. Repair existing exposed stone walls parging as needed. Match mortar color and texture.



LYONSPLAIN ARCHITECTURE

183 Main Street Westport, Connecticut

203 557 9200 www.lvonsplain.com

This drawing and the related specifications are instruments of service and shall remain the property of Lyonsplain Architectur whether the project for which it's made is executed or not. The drawings and related specifications shall not be used by the owner or others on other projects, for additions to this project or for completion of this project by others except by agreeme in writing and with appropriate compensation to Lyonsplair Architecture. This drawing and related specifications are copyrighted and protected under Section 120 of the U.S. Copyright Act USC. The protection includes but is not limited. design and construction techniques: unauthorized use or reproduction is prohibited. Submission or distribution for offici egulatory requirements or for other purposes in connection with the project is not to be construed as publication in derogation of the rights of Lyonsplain Architecture.

DESCRIPTION

PROJECT INFO

WESTPORT MUSEUM BRADLEY WHEELER HOUSE

PROJECT ADDRESS 25 AVERY PLACE

WESTPORT, CT 06880

2203 PROJECT #

LPA 06/07/2023 DATE

SHEET TITLE

DRAWN BY


TITLE SHEET

SHEET NUMBER

EXPERIENCE THE CARLISLE DIFFERENCE



Sure-Seal EPDM Fully-Adhered Roofing Systems

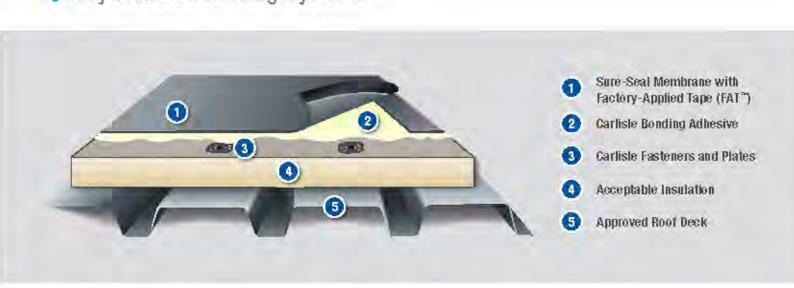

Sure-Seal EPDM Membranes for fully adhered roofing systems are available in the following:

| Color | Black |
|--------------------|---------------|
| Thicknesses (mils) | 45, 60 and 90 |
| Standard Widths | 10' -30' |
| Standard Lengths | 50'-100' |

System Features & Benefits:

- » Over 50 years of proven performance » In colder climates, dark-colored EPDM reduces heating costs, which are generally 3-5 times greater than cooling costs
- » Industry leading UV resistance of 41,580 kJ/m²
- Full thickness of weathering material, no internal scrim. » 465% elongation results in superior hail damage resistance
- Lowest global warming potential, acid rain and smog impact according to EPA's TRACI model

| | New Construction | | | | | | Re-roofing | | |
|---------------------------|-------------------------------------|---|--------------------|------------------------|----------------|-------------------------------|---------------------------|---------------------------|------------------------|
| Existing or New Deck Type | Steel | Plywood or OSB | Lt. Wt Concrete | Structural Concrete | Wood Planks | Gypsum & Fibrous Cement | Smooth Surface BUR | Gravel Surfaced BUR | Existing Single-Pty |
| Insulation Required | Yes | No | *Refer to Specs | No | Yes | Yes | No | Yes | Ves |
| Recommended Insulations | 0 | Cartiste Polyiso, OSB or SecurShield™ HD Cover Board over Polystyrene | | | | | Refer to New Construction | | |
| Insulation Attached By | | FAST™ Adhesive (non-penetrating) or Carlisle Fasteners and Plates | | | | | Refer to New Construction | | |
| Membrane Attached By | Carlisle- Approved Bonding Adhesive | | | | | 4- | Refer to New Co | onstruction | |

FOR TEAR OFF OPTIONS REFER TO NEW CONSTRUCTION ABOVE. For current code approvals, warranties and specifications and details, visit Carlisle's web site or contact Project Review.

* Refer to Carlisle's Adhered Design Criteria portion of the current specification for requirements.

800-479-6832 | P.O. Box 7000 | Carlisle, PA17013 | Fax: 717-245-7053 | www.carlislesyntec.com





Revere T-Z® Product is Durable, Attractive and Easy on the **Environment.**

Revere Tin-Zinc® products are coated on both sides with a unique patented T-Z Alloy™ (tin-zinc alloy). It offers all the advantages of copper with a naturally weathering earthtone gray color. Revere's T-Z^e coated products are rugged, environmentally friendly and aesthetically appealing, for use in virtually all architectural metal applications

The three layers of FreedomGray Satin T-Z Alloy™.

Tin-zinc alloy with satin finish 2 Intermetallic layer

8 Copper (99.5% pure)

The tin-zinc alloy is applied to both sides of our sheets and coils, using the hot-dip process. This ensures complete coverage and eliminates voids.

A satin finish is factory-applied to FreedomGray Satin T-Z Alloy™, to reduce initial reflectiveness and provide a natural, weathered appearance. The satin-finished Tin/Zinc surface begins to oxidize and starts to darken upon exposure. Environmental conditions and severity of exposure dictate how long this will take.

As with plain and pre-patinated copper, FreedomGray Satin T-Z Alloy™ will always display differences in the shades and hues of it's natural patina. These are NOT an indication of defective material. In many respects it is the variations that give T-Z® coated products their unique life, vitality and aesthetics.



Tin-Zinc Coated Products

T-Z[®] Alloy Coatings vs. Zinc: A Revealing Comparison.

When a durable gray architectural metal roof is called for, FreedomGray Satin T-Z Alloy™ offers numerous advantages over zinc. Like all architectural copper, FreedomGray T-Z Alloy™ is easier to form, simpler to install and more durable in most environmental conditions. Some comparisons:

 More versatile forming – Our T-Z[®] coated products can be formed, installed and subjected to sub-freezing temperatures with no adverse effects.

Sharp, zero-radius bends, which are typical with all architectural metal work, can stress zinc to the point that it cracks or splits. Expansion movement caused by daily and seasonal temperature changes can aggravate minor splits and make them "run"

FreedomGray can be formed and installed with the same bends as plain copper.

 Less restrictive installation – Moisture on the reverse side of zinc can cause severe and rapid corrosion. In extreme conditions it can "rust through" in less than a year. To avoid this problem, the underside of zinc must be ventilated - Installed above the roof deck. This difficult, costly installation is not necessary with our T-Zº coated product, which can be applied directly over roof decks.

EFFICIENT OF THERMAL EXPANSION

Copper vs. zinc

Zinc measured Zinc measured Copper/Stainle parallel to perpendicular to Steel rolling direction

 Greater durability – Ice dams, in valleys and along eaves, are a common winter occurrence in much of the country.

Water trapped behind these dams can (and does) penetrate locks and seams.

With zinc roofs, this can lead to "underside corrosion." Moisture trapped on the underside of copper, on the other hand, has no negative effects, making T-Z[®] coated product a better choice for long-term durability.

it at the seam. If too much heat is applied, a

The melting point of architectural copper is

1,981°F. At 700°F, it takes almost an hour for

copper to begin to anneal. As discussed later

in this brochure, FreedomGray is soldered

similar to plain copper.

hole can easily be burned through zinc.

• Physical properties - Properties of sheet zinc (coefficient of thermal expansion, tensile strength, creep rate, etc.) depend upon temperature and direction of rolling. The chart shown here compares the coefficients of thermal expansion for zinc, stainless steel

 Soldering – Zinc anneals at 212°F and FreedomGray Satin T-Z Alloy™ is a melts at 784°F. Standard solder begins to flow practical choice for today's environmentally at 420°F. As a result, soldering changes the conscious clients. grain size of zinc (anneals it) and weakens

FreedomGray Satin T-Z Alloy™ Is basically inert, allowing it to be used with most other architectural metals. When in doubt, contact Revere's Technical Advisory Service for answers about



In Any Environment, T-Z®

Coated Copper Fits.

FreedomGray Satin T-Z Alloy™ is appropriate for use in most applications that would use copper or lead-coated copper. FreedomGray may be used not only for roofs, but also to form most architectural accents, gutters, downspouts and other rainwater carriers, and wall cladding.

Roofs and flashings using Revere's patented tin-zinc alloy have been exposed to Industrial, seacoast, urban and rural environments without failure. Salt spray, salt fog and other accelerated weathering tests have also had no adverse effects. However, in some marine evnviroments pitting may occure over time, please consult with Revere.

Handling Considerations



In most environments and applications, FreedomGray Satin T-Z Alloy™ will not stain other materials below them. However, drip edges and overhangs should still be designed to minimize water staining.


If desired, FreedomGray Satin T-Z Alloy™ may be painted without altering its physical properties.


Inorganic acids, including hydrochloric acid, can damage FreedomGray Satin T-Z Alloy™. Steps should be taken to protect against runoff from acid-leaching substances, overspray from masonry cleaners (muriatic acid), tannic acid from some wood, and other

Most commonly available underlayments may be used with these products. Before installing FreedomGray Satin T-Z Alloy™ with treated lumber, consult Revere and the lumber treater.

For safety, Revere always recommends the use of gloves and eye protection whenever handling any architectural metal.



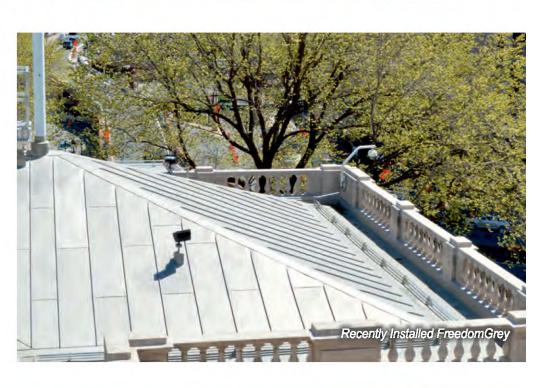

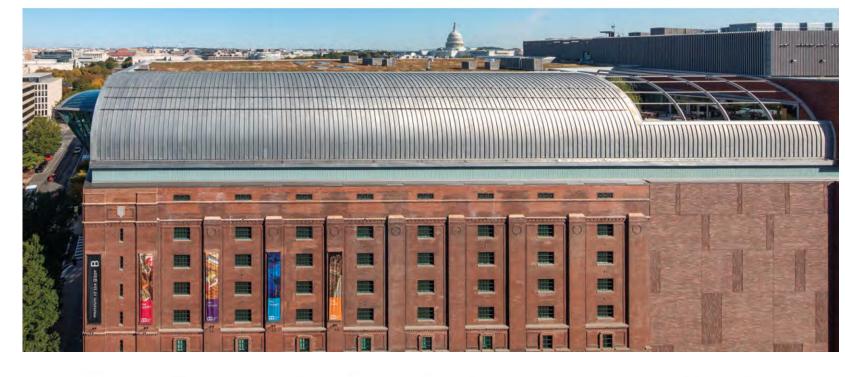

Architectural Guide Specifications Revere FreedomGray® and Satin T-Z Alloy™ is cut, bent, formed and installed using the same tools and techniques as with mill-finished copper. Complete details and specifications for the installation of architectural sheet copper are contained in the Revere manual Copper & Common Sense.

MATERIALS: Sheet Copper

All FreedomGray sheet copper shall be standard, ounce-weight material conforming to ASTM specification B370.

Where FreedomGray Satin T-Z Alloy™ coated material is specified or noted on the drawings, copper shall be coated both sides with Tin/Zinc alloy materials. To prevent water stains due to a minimum of 0.0005" thick per side. Composition of the alloy shall be approximately 50% zinc and 50% tin with trace elements controlled for durability, workday. corrosion resistance and color.

The T-Z Alloy™ shall be applied by the hot-dip process. All T-Z Alloy™ coated copper shall have a satin finish.

Where used on T-Z Alloy™ coated copper, solder shall conform to ASTM specification B32 and shall be pure tin OR lead-free, high-tin. If leaded solder is allowed a 60% minimum of tin is required.

WORKMANSHIP: Handling & Storage

Store FreedomGray Satin T-Z Alloy™ coated copper sheets, colls and formed shapes off the ground, in an enclosed structure. Do NOT store In a manner or location that would allow water or moisture to remain between sheets or shapes prior to installation. Do NOT store on bare ground under a tarp or in another manner that may cause condensation to form on or between sheets or shapes. Caution must be taken to avoid moisture In storage of sheets, colls, pans, gutters or fascia. Storage In wet conditions, high-moisture areas or where condensation occurs may cause surface staining or corrosion, this can occur quickly.

Handle sheets and shapes so as to minimize scratches, dents, etc.

COMMENTARY: In the absence of oxygen, standing water may cause water stains and, in severe cases, corrosion. Water stains and surface scratches should not affect lead times. the life or durability of FreedomGray Satin T-Z Alloy™; however, they can be aesthetically unattractive.

to receive soldering should be chemically and/or mechanically cleaned to produce clean, bright alloy. COMMENTARY: to all surfaces to receive solder.

To ease soldering, a tin-bearing flux may be applied

Except as noted elsewhere, form and install FreedomGray Satin T-Z Alloy™ as noted on the drawings and in the same manner as described for plain copper in Revere's sheet copper design manual Copper & Common Sense, latest edition.

Protection FreedomGray Satin T-Z Alloy™ shall be protected during installation and cleaning of masonry with tarps, polyethylene sheeting or similar impervious condensation trapped on the metal's surface, protection must be removed at the end of each

Remove excessive dirt and construction debris

by washing thoroughly with clear water. Grease, oils, etc. may be removed by washing with alkaline commercial cleaning agent in hot water. Do not otherwise chemically or mechanically clean FreedomGray Satin T-Z Alloy™. Available Forms of FreedomGray

Sheets and coils Weights 16-az.; 0.0216" thick

20-oz.; 0.027" thick 24-oz.; 0.032" thick 32-oz.; 0.043° thick HOO-H01 - cold rolled Temper Stock sizes 36"x 120" x 16-oz. sheets 36"x 96" x 16-oz. sheets 36"x 120" x 20-oz_ sheets 36"x 96" x 20-oz. sheets 500 lin. ft. coils of 20° and 24" wide, 16-oz. and 20oz.

NOTE: Other sizes and corresponding lead times available on request.

ORDERING INFORMATION:

FreedomGray Satin T-Z Alloy™ are priced at a premium above Revere's Classic Copper finish. Contact your local Revere distributor for prices and

Minimum Order Quantity One standard case or coil

Through Revere sheet copper distributors throughout the U.S., Canada and South America.

FreedomGray Satin T-Z Alloy™

Before soldering T-Z Alloy coated copper, surfaces Warranty Revere warrants that, for a period of 25 years after delivery, with the exception of coastal areas within 1 mile of a salt water environment, FreedomGray Satin T-Z Alloy™ will comply with the written specifications accepted by Revere and will be free of defects in

> workmanship and materials for a period of 10 years. Call Revere for complete warranty details.

Technical Guidance

If you have questions or concerns about the use of FreedomGray Satin T-Z Alloy™ on a particular project, please call (800) 448-1776, ext. 2554.

Do NOT Use FreedomGray Satin T-Z

1) Below plain or pre-patinated copper 2) In areas subject to impingement (e.g., in areas where water falls off a higher roof onto FreedomGray Satin T-Z Alloy™)

3) In areas of concentrated or abrasive flow (such as in valleys on slate or tile roofs)

4) Below or next to Cedar, or any natural acid bearing woods without a surface protection of a temporary clear or colored latex paint. This paint should provide suitable protection for the Tin / Zinc coating for 1 year minimum.

5) Where treated lumber is in contact with our material or where runoff from treated lumber flows onto our material.

6) Consult your wood manufacturers and follow their recommendations for product suitability. Wood treatments applied by manufacturers change frequently, you must make sure to follow current recommendations.

Cautionary Uses

1) Interior applications where oxidation of the T-Z alloy coating may not occur in a short period of time due to its limited exposure.

2) Soffits and similar "protected" applications where weathering will be extremely slow.



LYONSPLAIN ARCHITECTURE

183 Main Street Westport, Connecticut

203 557 9200 www.lyonsplain.com

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DESCRIPTION

PROJECT INFO

WESTPORT MUSEUM BRADLEY WHEELER HOUSE

PROJECT ADDRESS

25 AVERY PLACE WESTPORT, CT 06880

PROJECT #

LPA DRAWN BY


2203

06/07/2023 DATE

SHEET TITLE

SPECIFICATIONS

SHEET NUMBER

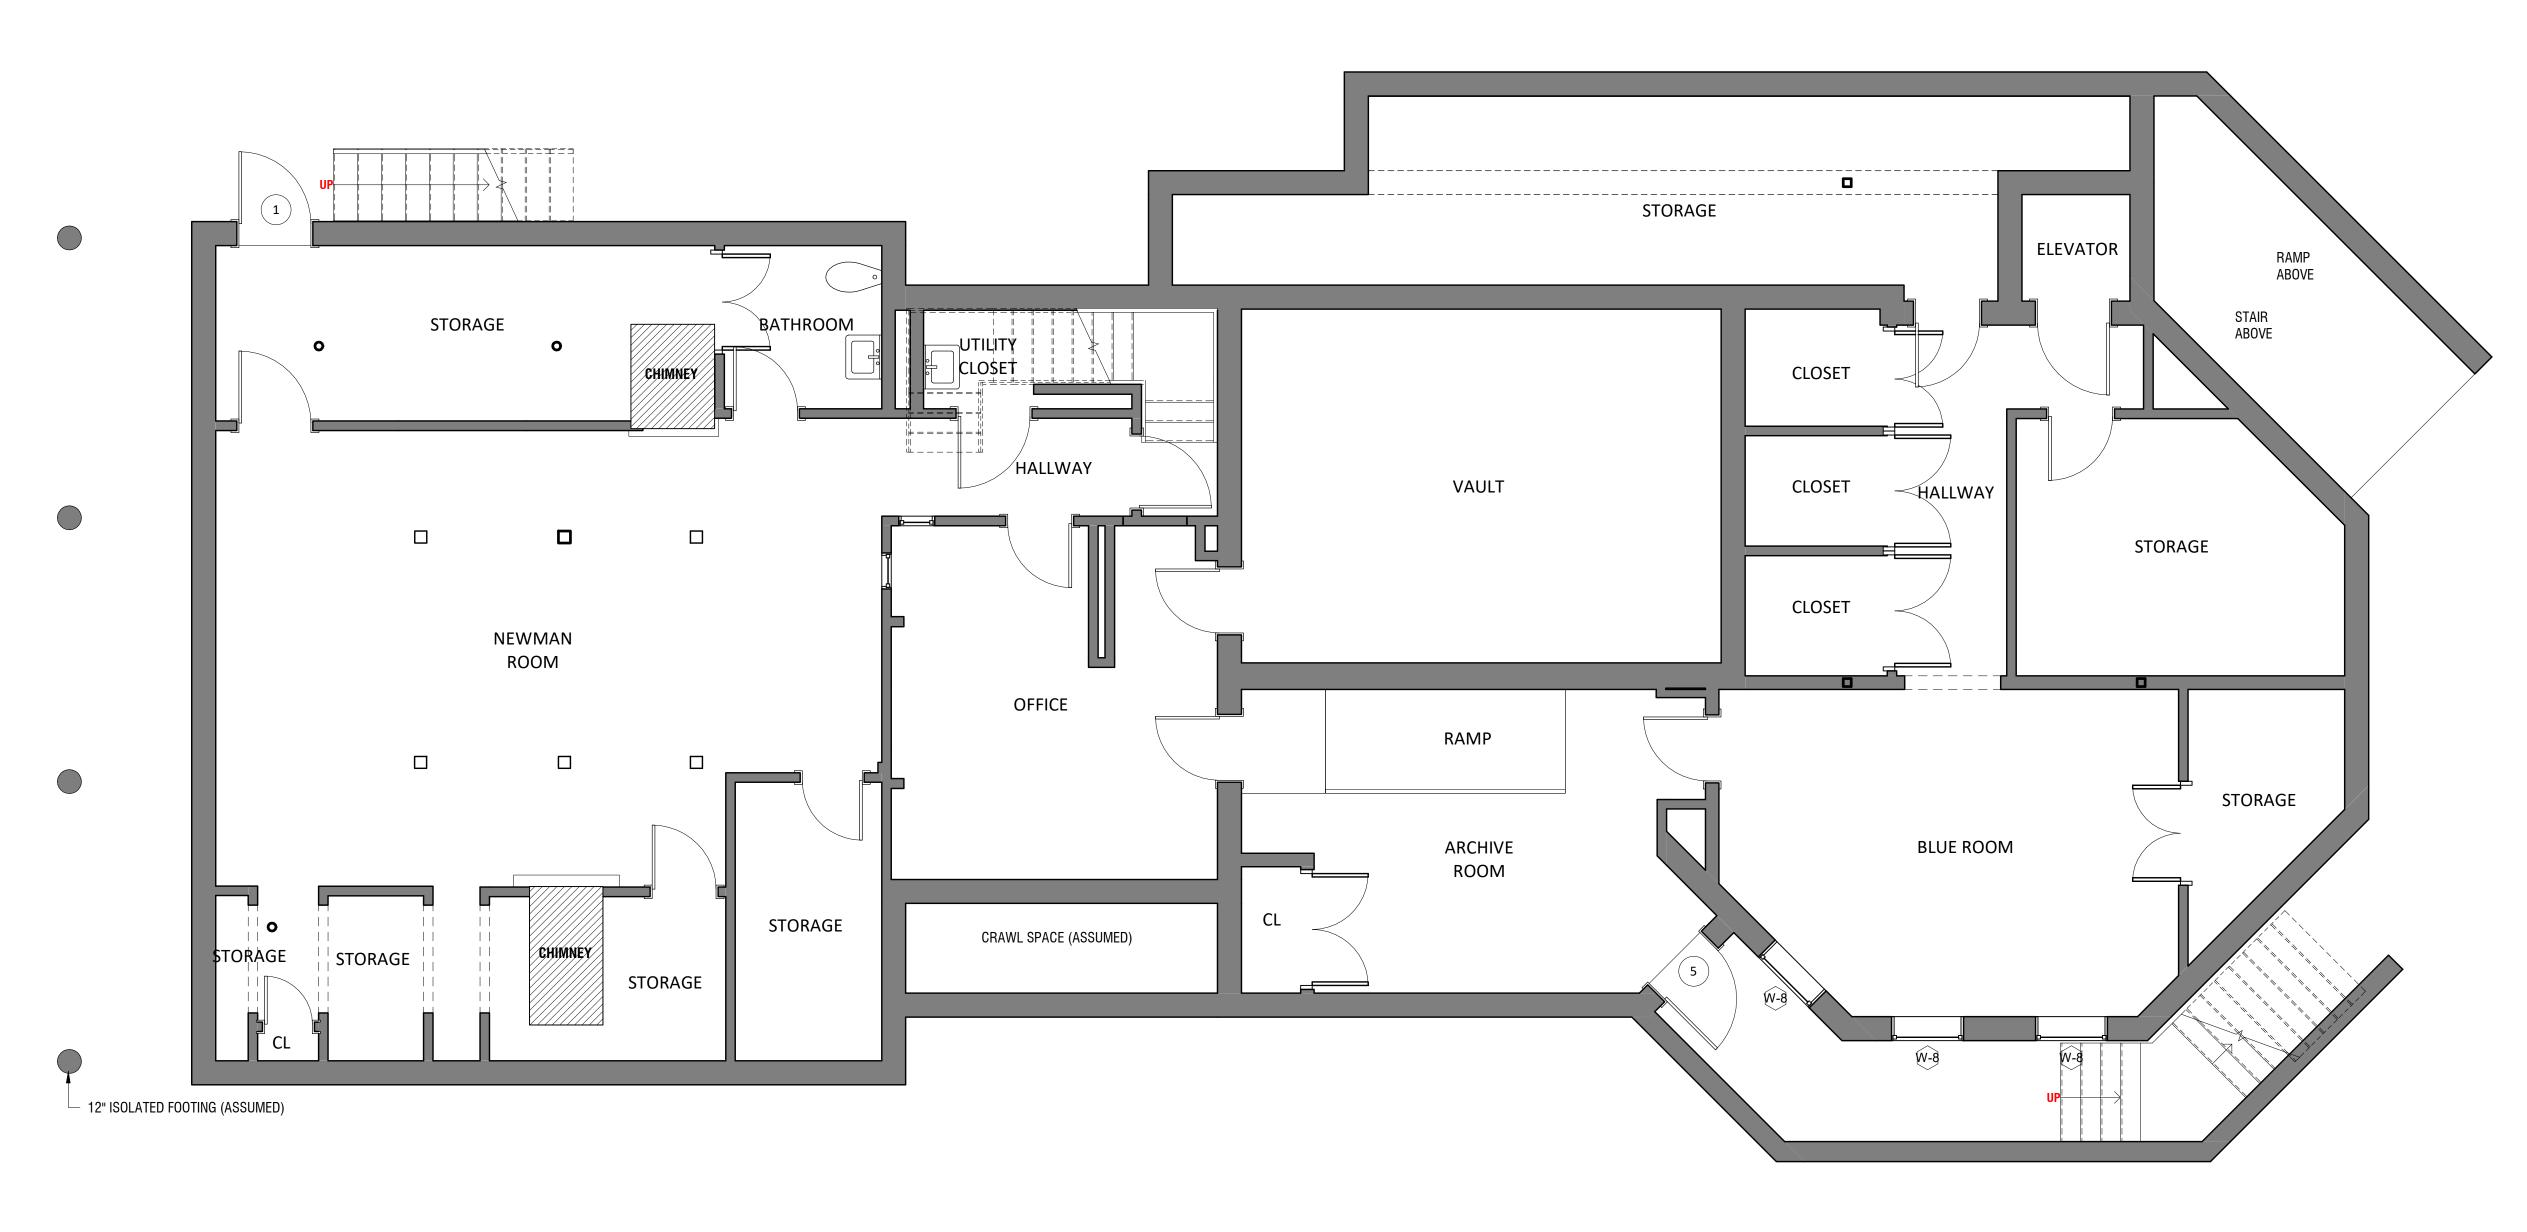

1 LOWER LEVEL PLAN
A4.1 A1.1 1/4" = 1'-0"

KEYPLAN - LOWER LEVEL

1795/1867

2003

PROJECT TRUE NORTH

0' 2' 4'

LP

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PROJECT INFO

WESTPORT MUSEUM BRADLEY -WHEELER HOUSE

PROJECT ADDRESS

25 AVERY PLACE
WESTPORT, CT 06880

PROJECT # **2203**

DRAWN BY **LPA**DATE **06/07/2023**


SHEET TITL

LOWER LEVEL FLOOR PLAN

SHEET NUMBER

A1.1

\\Mac\Home\LyonsPlain Dropbox\0.1 LPA PROJECTS Folder\1.3 PROJECTS\2002\2203 Westport Museum BW House\D. DRAWING DOCUMENTS\I

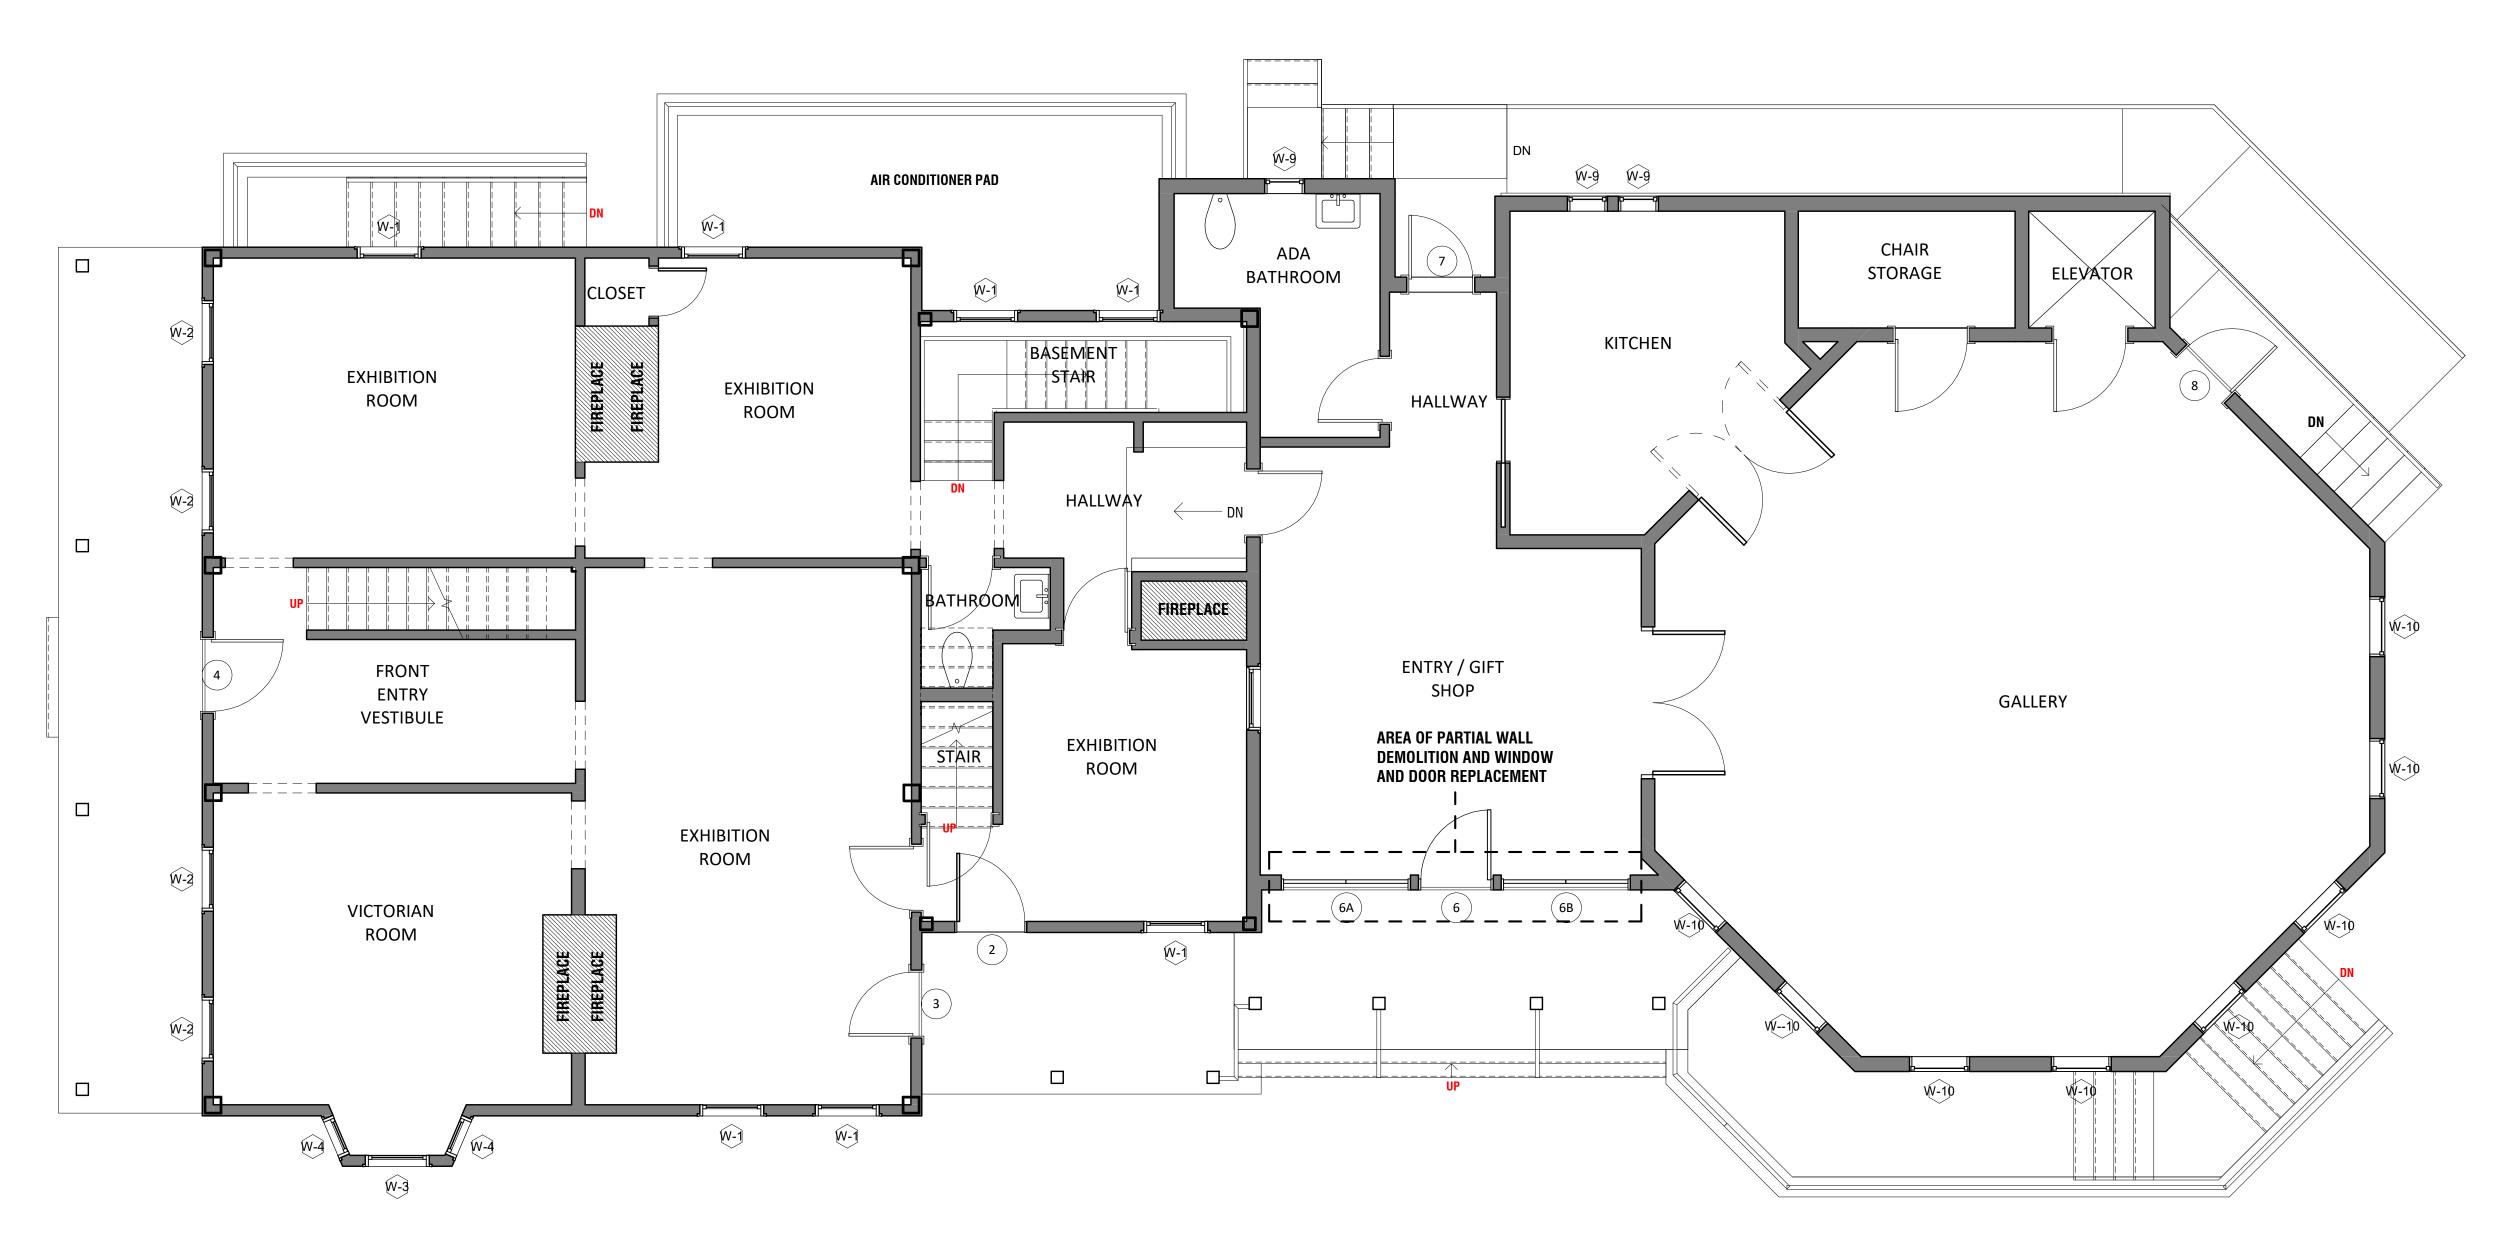

1 FIRST FLOOR PLAN
A3.1 A1.2 1/4" = 1'-0"

| True | North | North

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<u>REV#</u> DESCRIPTION DATI

PROJECT INFO

WESTPORT MUSEUM BRADLEY -WHEELER HOUSE

PROJECT ADDRESS

25 AVERY PLACE
WESTPORT, CT 06880

PROJECT # **2203**

DRAWN BY **LPA**DATE **06/07/2023**


SHEET TITLE

FIRST FLOOR PLAN

SHEET NUMBER

A1.2

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SECOND FLOOR PLAN A3.1 A1.3 1/4" = 1'-0"
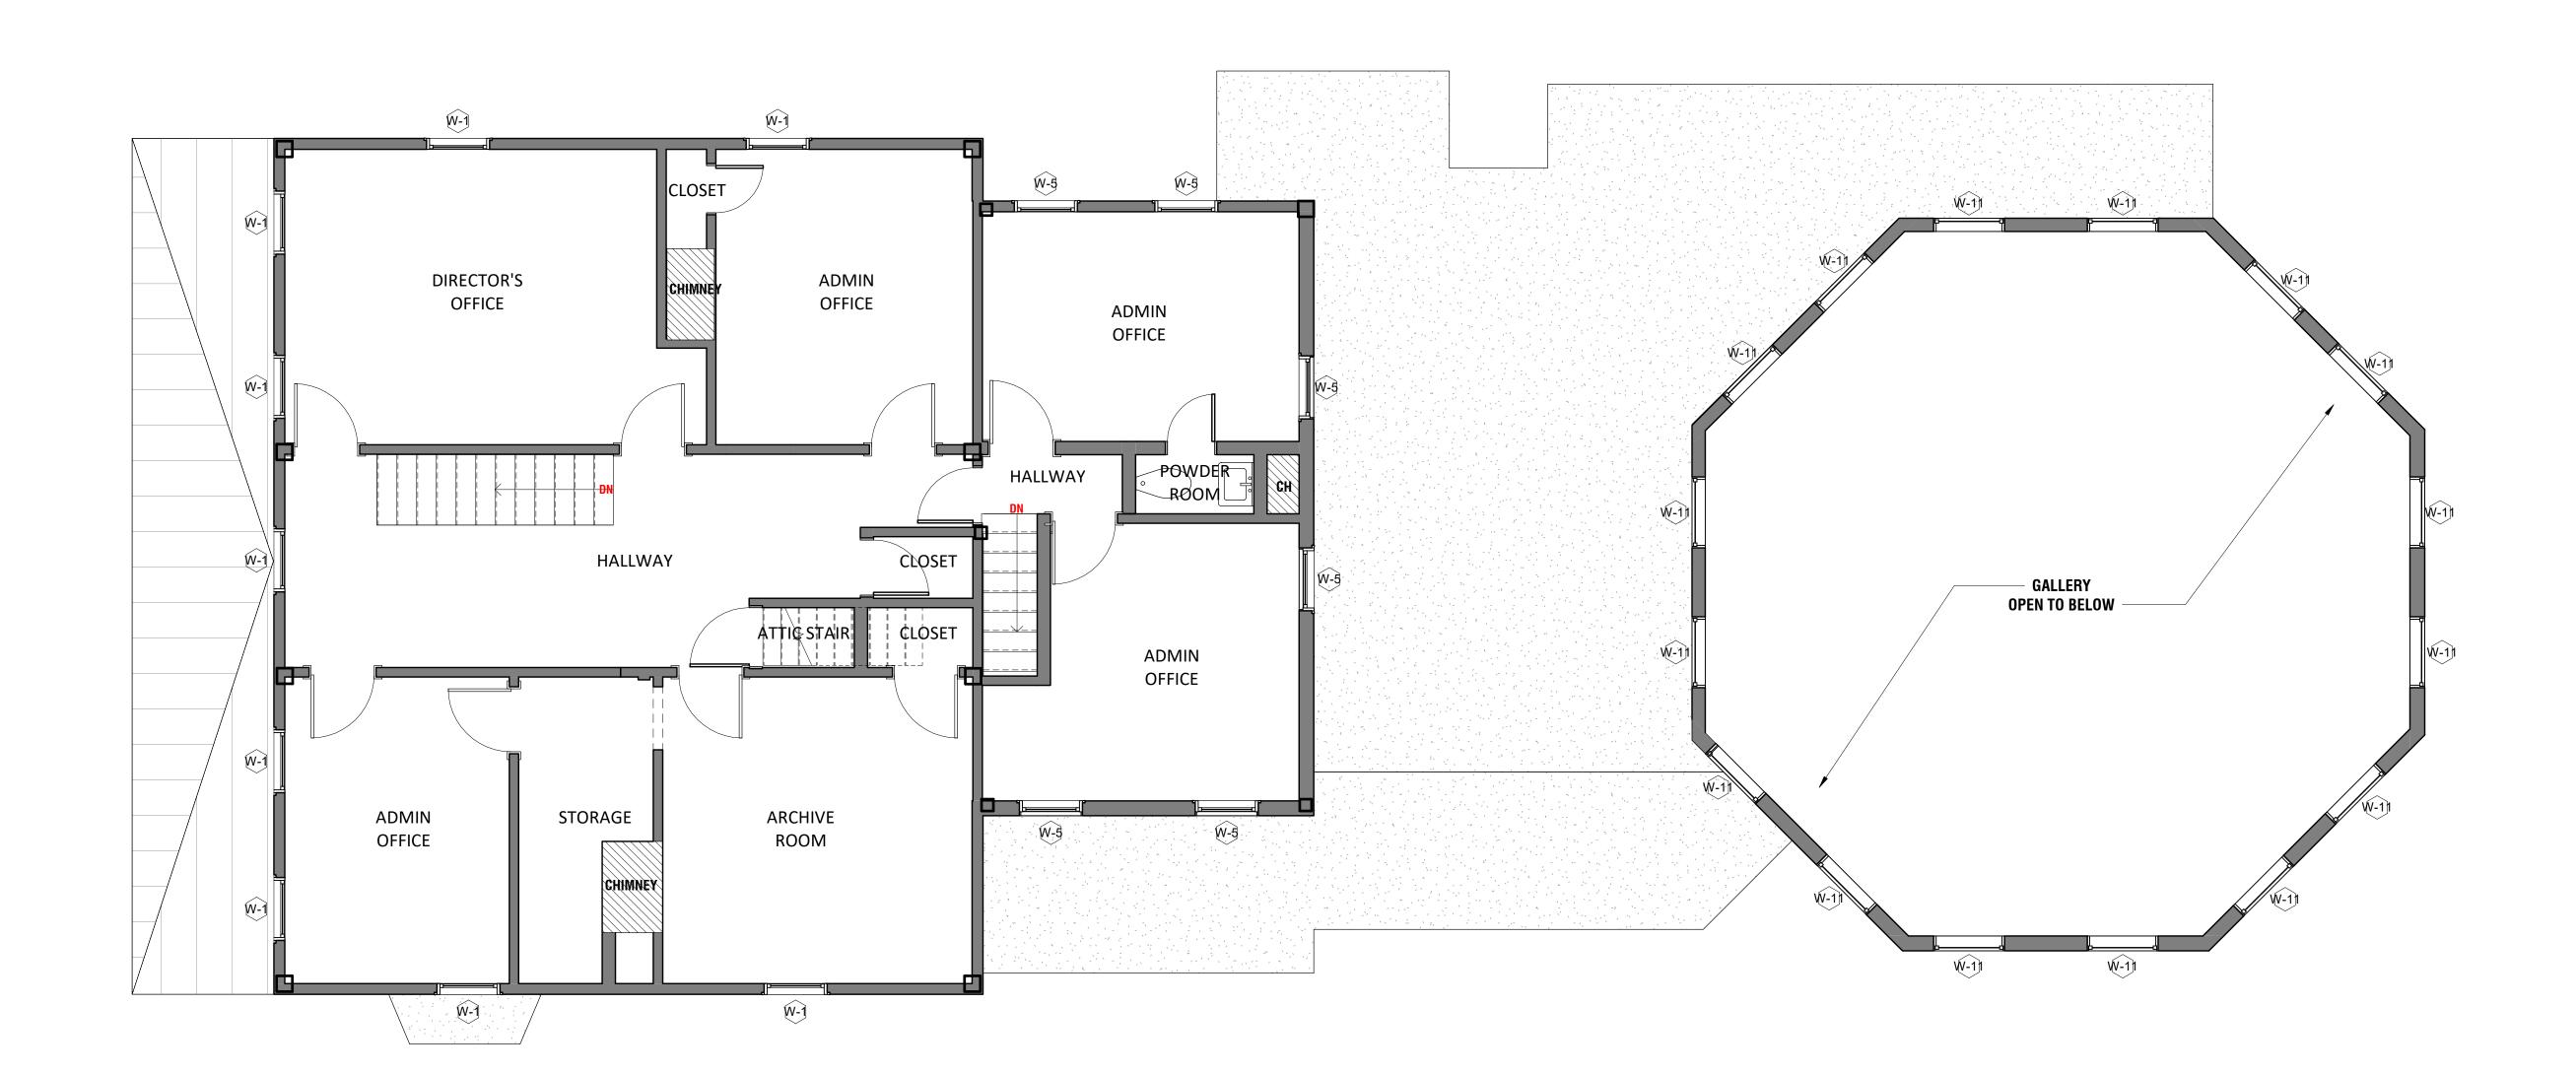
> KEYPLAN TRUE NORTH 1795/1867 0' 2' 4'

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PROJECT INFO

WESTPORT MUSEUM BRADLEY -WHEELER HOUSE

PROJECT ADDRESS


25 AVERY PLACE WESTPORT, CT 06880

PROJECT # **2203** DRAWN BY LPA

06/07/2023

SECOND FLOOR PLAN

SHEET NUMBER

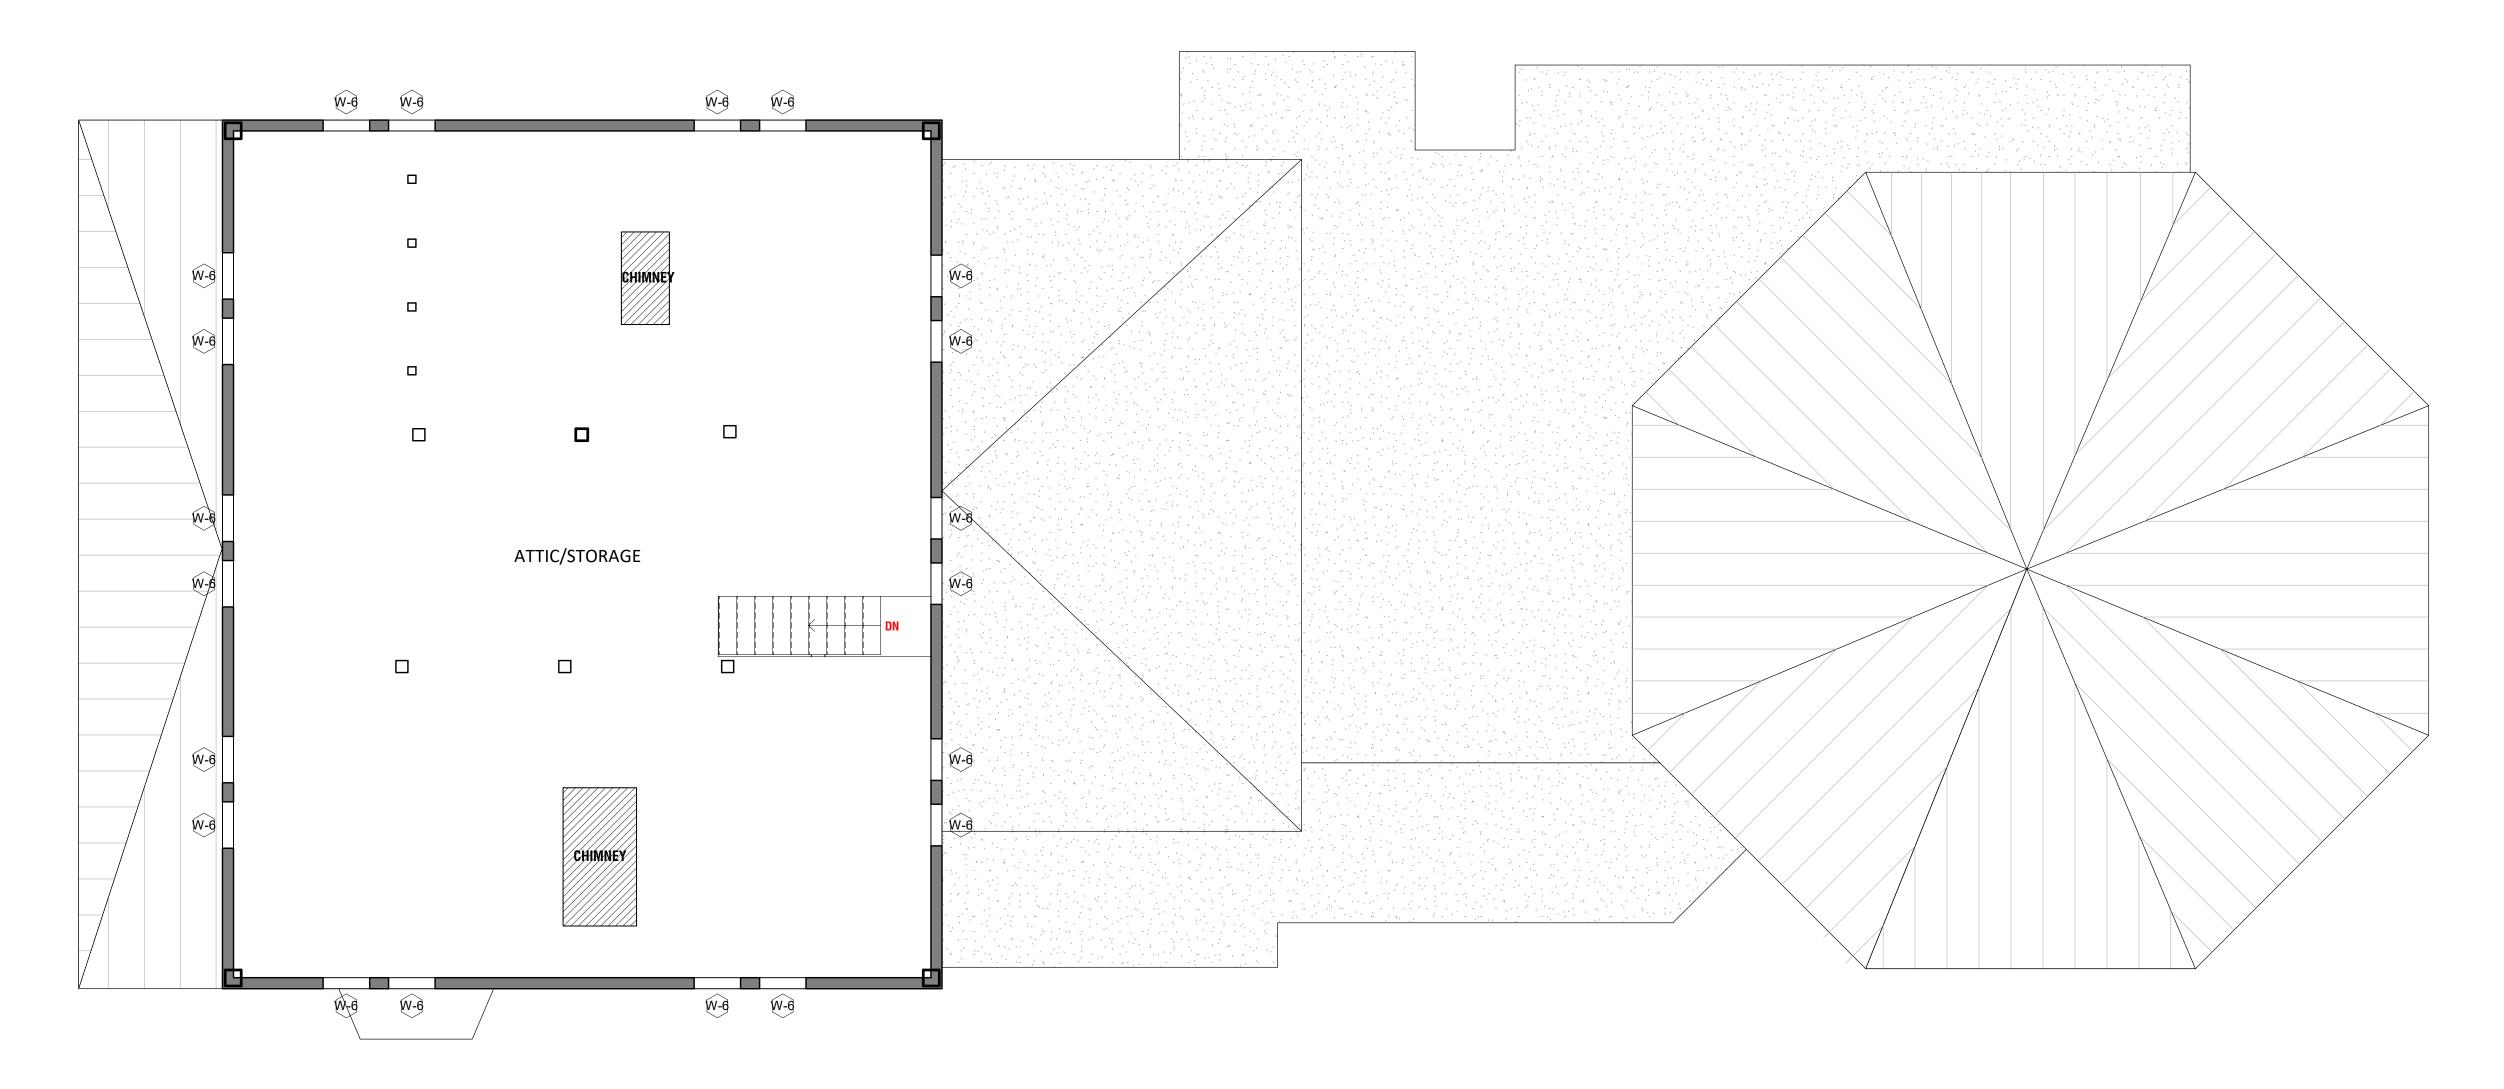

ATTIC FLOOR PLAN
A3.1 | A1.4 1/4" = 1'-0"

| TRUE | NORTH | NORTH

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REV# DESCRIPTION DA

PROJECT IN

WESTPORT MUSEUM BRADLEY -WHEELER HOUSE

PROJECT ADDRESS

25 AVERY PLACE
WESTPORT, CT 06880

WESTPUNI, GI UU

PROJECT # 2203

DRAWN BY LPA

DATE **06/07/2023**


SHEET TITLE


ATTIC FLOOR PLAN


SHEET NUMBER

A1.4

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LP\
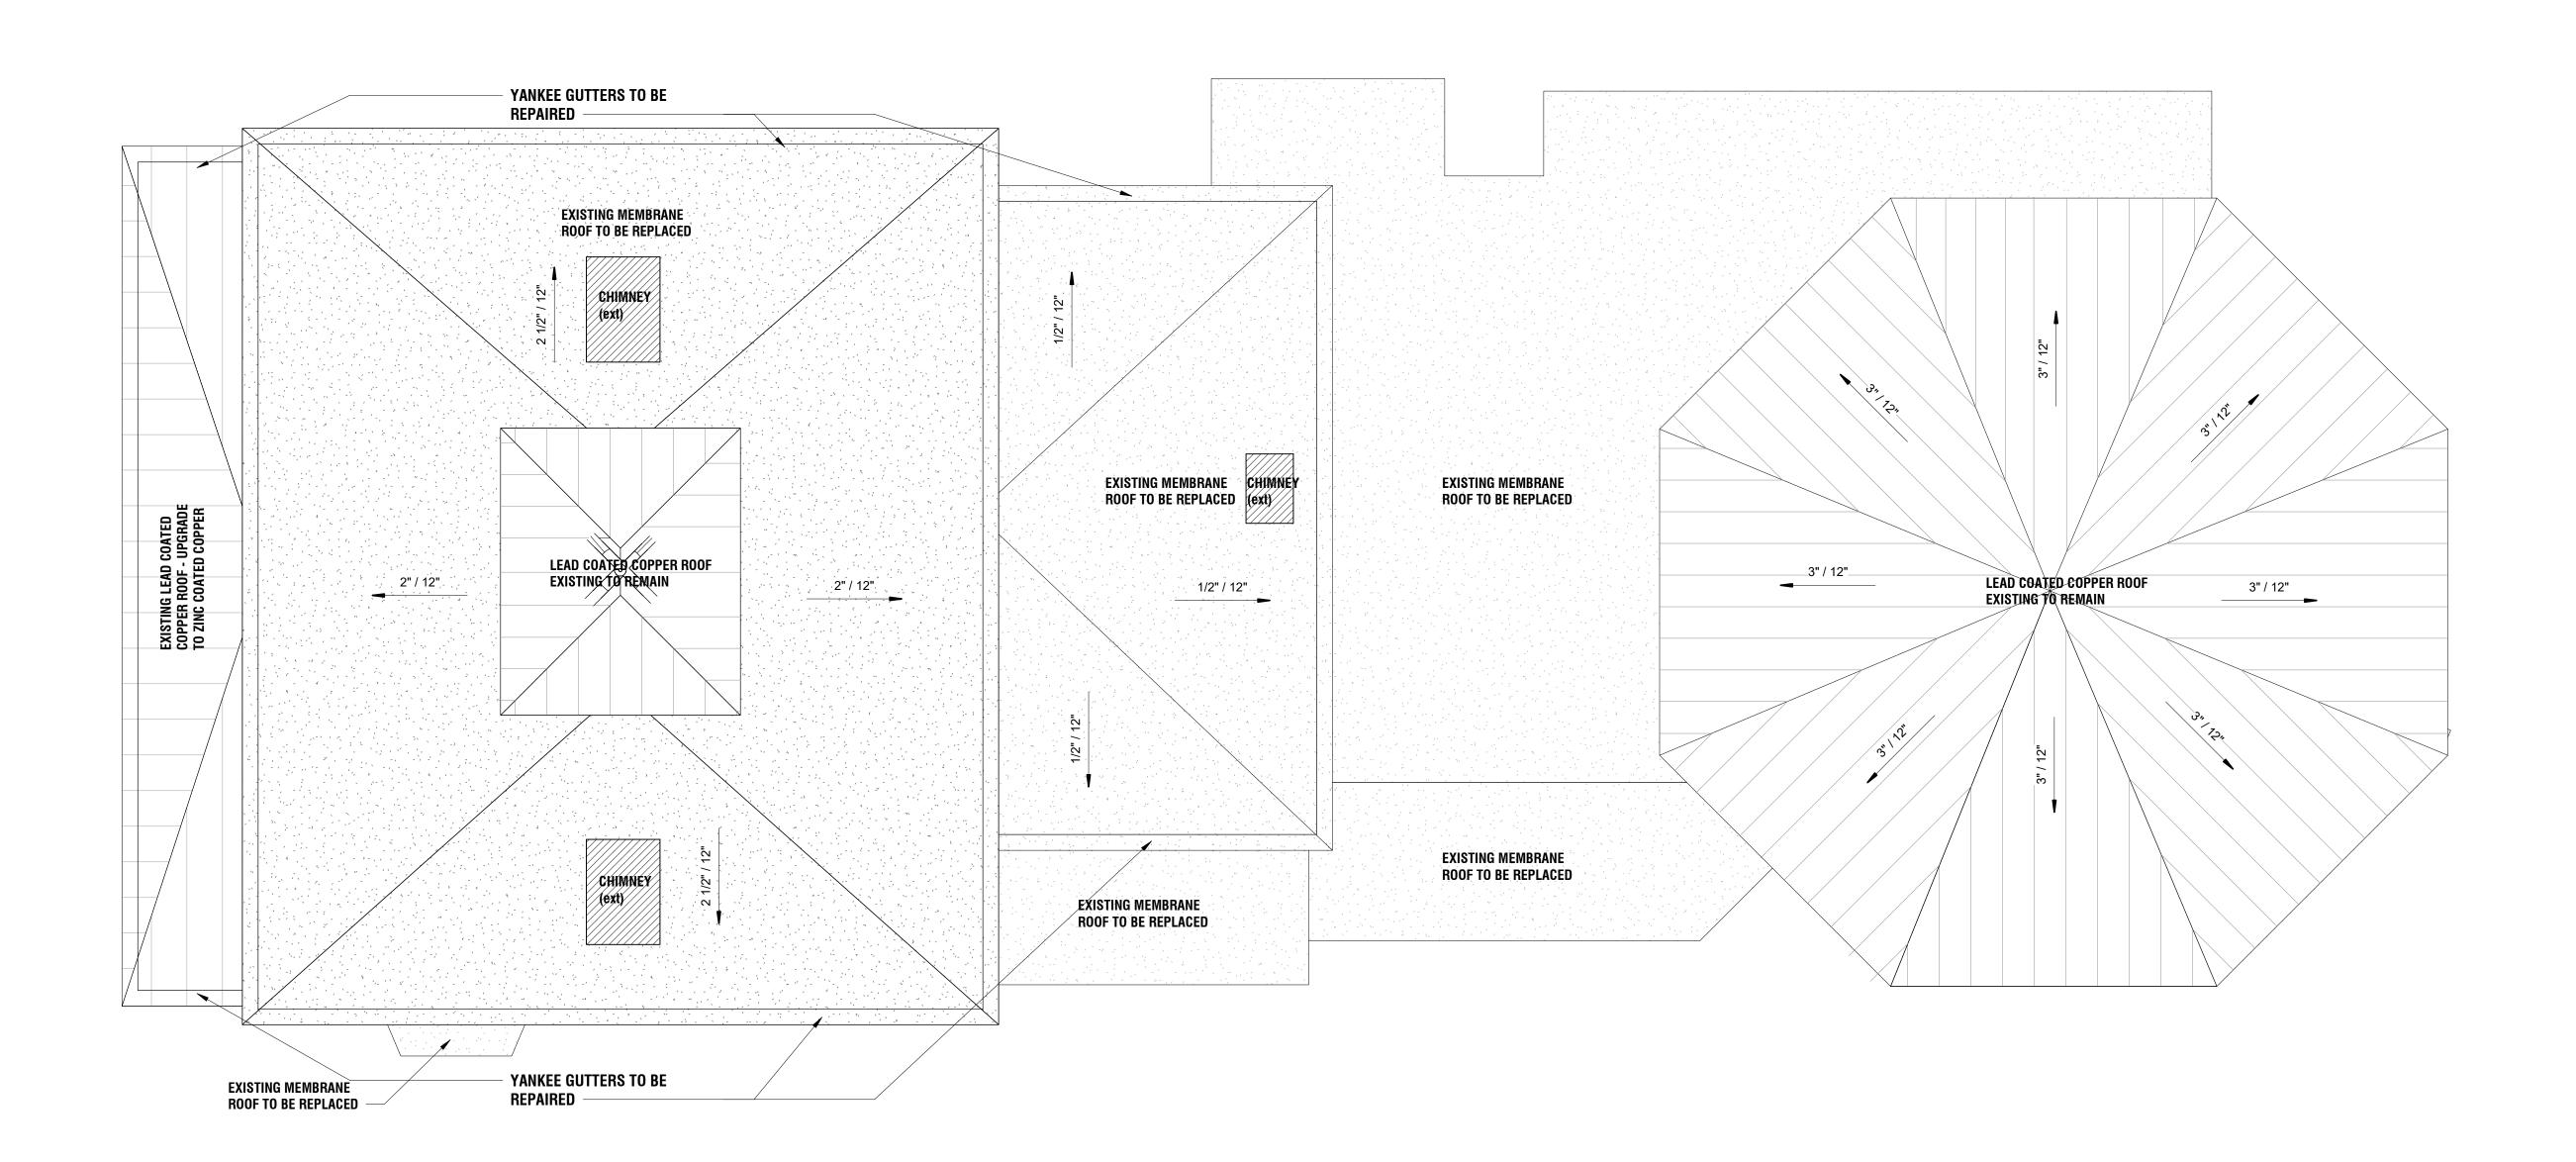
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PROJECT INFO

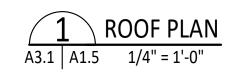WESTPORT MUSEUM BRADLEY -WHEELER HOUSE

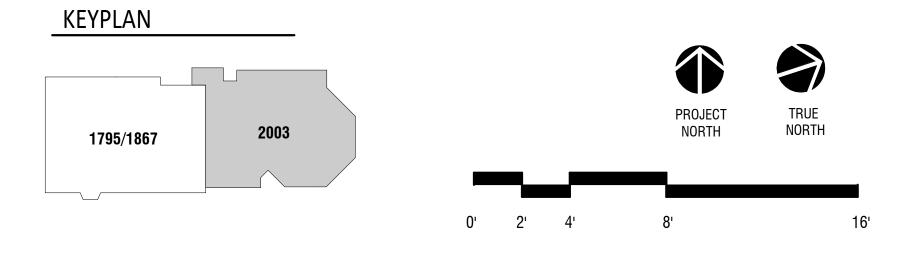PROJECT ADDRESS

25 AVERY PLACE
WESTPORT, CT 06880

PROJECT # **2203**

DRAWN BY **LPA**DATE **06/07/2023**

SHEET TITLE

ROOF PLAN

SHEET NUMBER

A1.5

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| \wedge | | |
|--------------|-------------|------|
| <u>ÆEV</u> # | DESCRIPTION | DATE |

PROJECT INFO

WESTPORT MUSEUM BRADLEY -WHEELER HOUSE

PROJECT ADDRESS

25 AVERY PLACE
WESTPORT, CT 06880

PROJECT # **2203**

DRAWN BY LPA

DATE **06/07/2023**

SHEET TITLE

EXTERIOR ELEVATIONS

SHEET NUMBER

BRICK CHIMNEY

0' 2' 4'


METAL GUARD RAIL

BRICK VENEER W/ STONE CAP

2003

1795/1867

A3.1

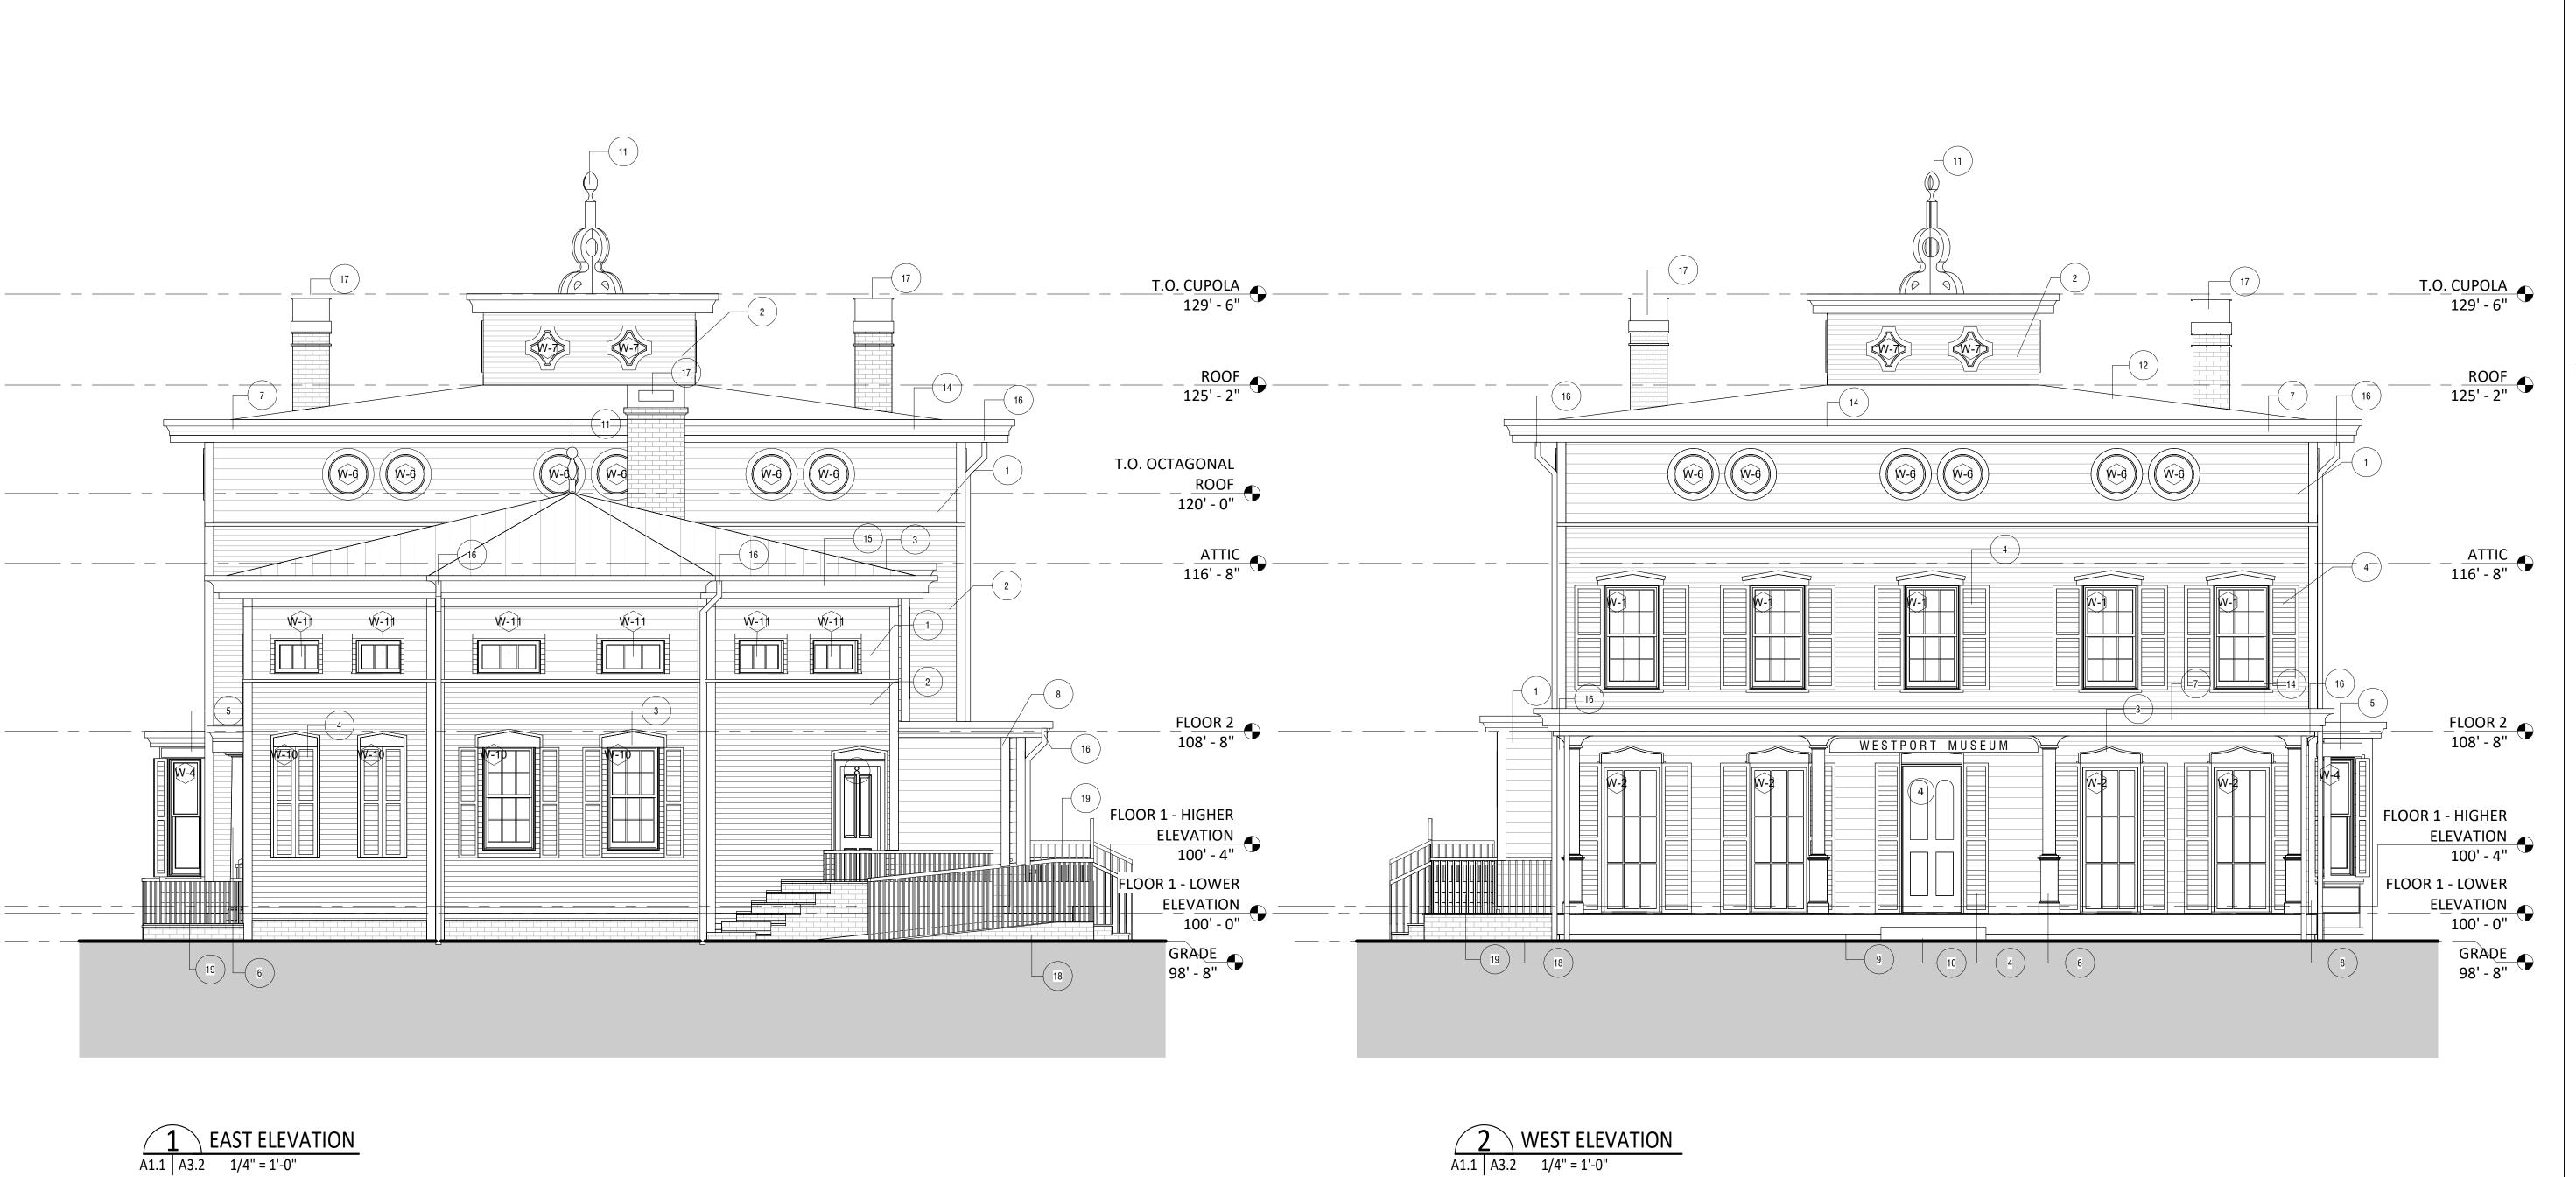

2 WEST ELEVATION A1.1 A3.2 1/4" = 1'-0"

> LEGEND - EAST ELEVATION LEGEND - WEST ELEVATION 1795/1867 2003 -1795/1867 2003

| KEY VALUE | MATERIAL NOTE | |
|-----------|---------------------------|--|
| 1 | SHIPLAP SIDING | |
| 2 | LAP SIDING | |
| 3 | WOOD CASING | |
| 4 | WOOD SHUTTER | |
| 5 | WOOD PANELS | |
| 6 | ORNAMENTAL COLUMN | |
| 7 | WOOD FASCIA | |
| 8 | WOOD CORNER BOARD | |
| 9 | WOOD WATER TABLE | |
| 10 | WOOD STEPS | |
| 11 | FINIALS | |
| 12 | EPDM ROOFING | |
| 13 | LEAD-COATED COPPER ROOF | |
| 14 | YANKEE GUTTER | |
| 15 | HALF ROUND GUTTER | |
| 16 | DOWNSPOUT | |
| 17 | BRICK CHIMNEY | |
| 18 | BRICK VENEER W/ STONE CAP | |
| 19 | METAL GUARD RAIL | |

0' 2' 4'

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PROJECT ADDRESS 25 AVERY PLACE WESTPORT, CT 06880

2203 PROJECT # LPA DRAWN BY

06/07/2023

SHEET TITLE

EXTERIOR ELEVATIONS

SHEET NUMBER

A3.2



1 SOUTH ELEVATION
A1.1 | A3.3 1/4" = 1'-0"

LEGEND - SOUTH ELEVATION

1795/1867 2003

| | · |
|----|---------------------------|
| 1 | SHIPLAP SIDING |
| 2 | LAP SIDING |
| 3 | WOOD CASING |
| 4 | WOOD SHUTTER |
| 5 | WOOD PANELS |
| 6 | ORNAMENTAL COLUMN |
| 7 | WOOD FASCIA |
| 8 | WOOD CORNER BOARD |
| 9 | WOOD WATER TABLE |
| 10 | WOOD STEPS |
| 11 | FINIALS |
| 12 | EPDM ROOFING |
| 13 | LEAD-COATED COPPER ROOF |
| 14 | YANKEE GUTTER |
| 15 | HALF ROUND GUTTER |
| 16 | DOWNSPOUT |
| 17 | BRICK CHIMNEY |
| 18 | BRICK VENEER W/ STONE CAP |
| 19 | METAL GUARD RAIL |

EXTERIOR ELEVATIONS KEYNOTES

MATERIAL NOTE

KEY VALUE

0' 2' 4' 8' 16'

LP\

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REV# DESCRIPTION DATE

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WESTPORT, CT 06880

PROJECT # **2203**

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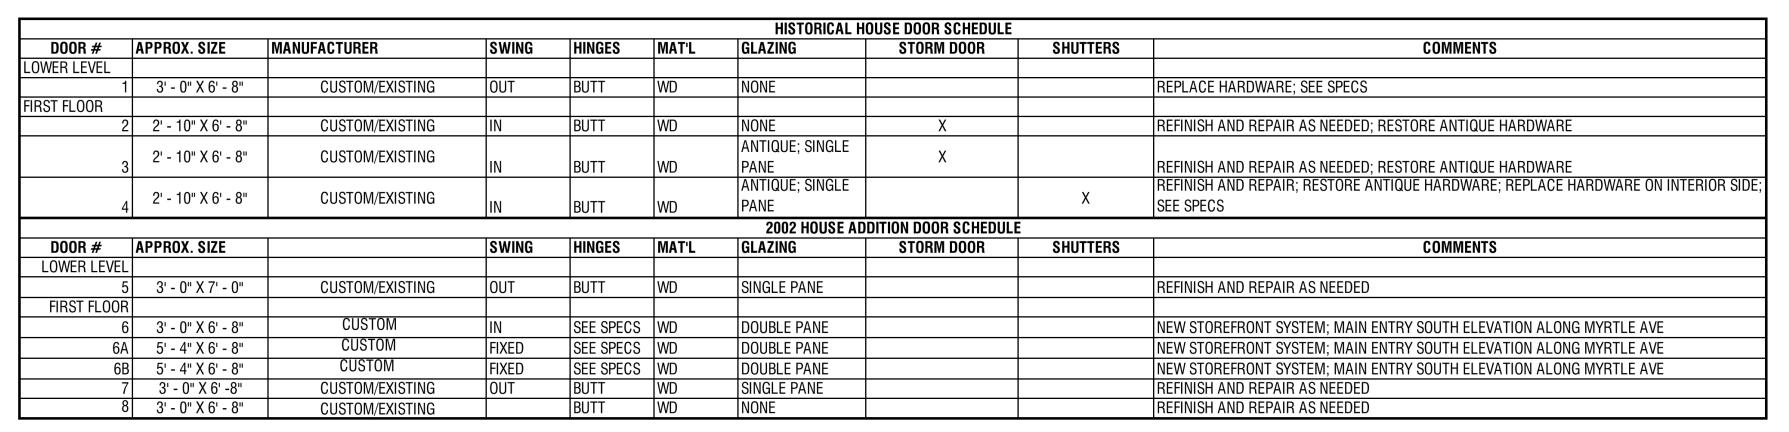
NTE 06/07/2023


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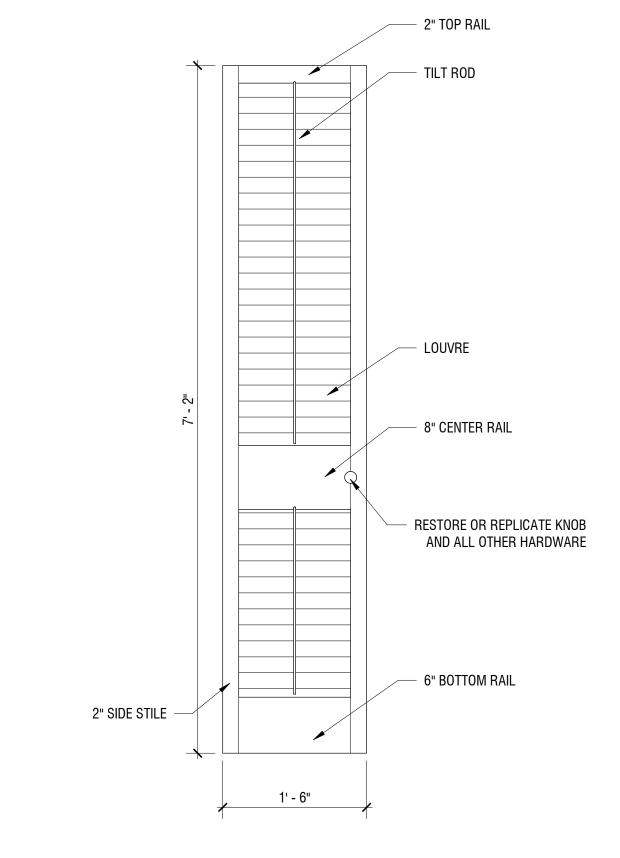
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SHEET NUMBER


A3.3





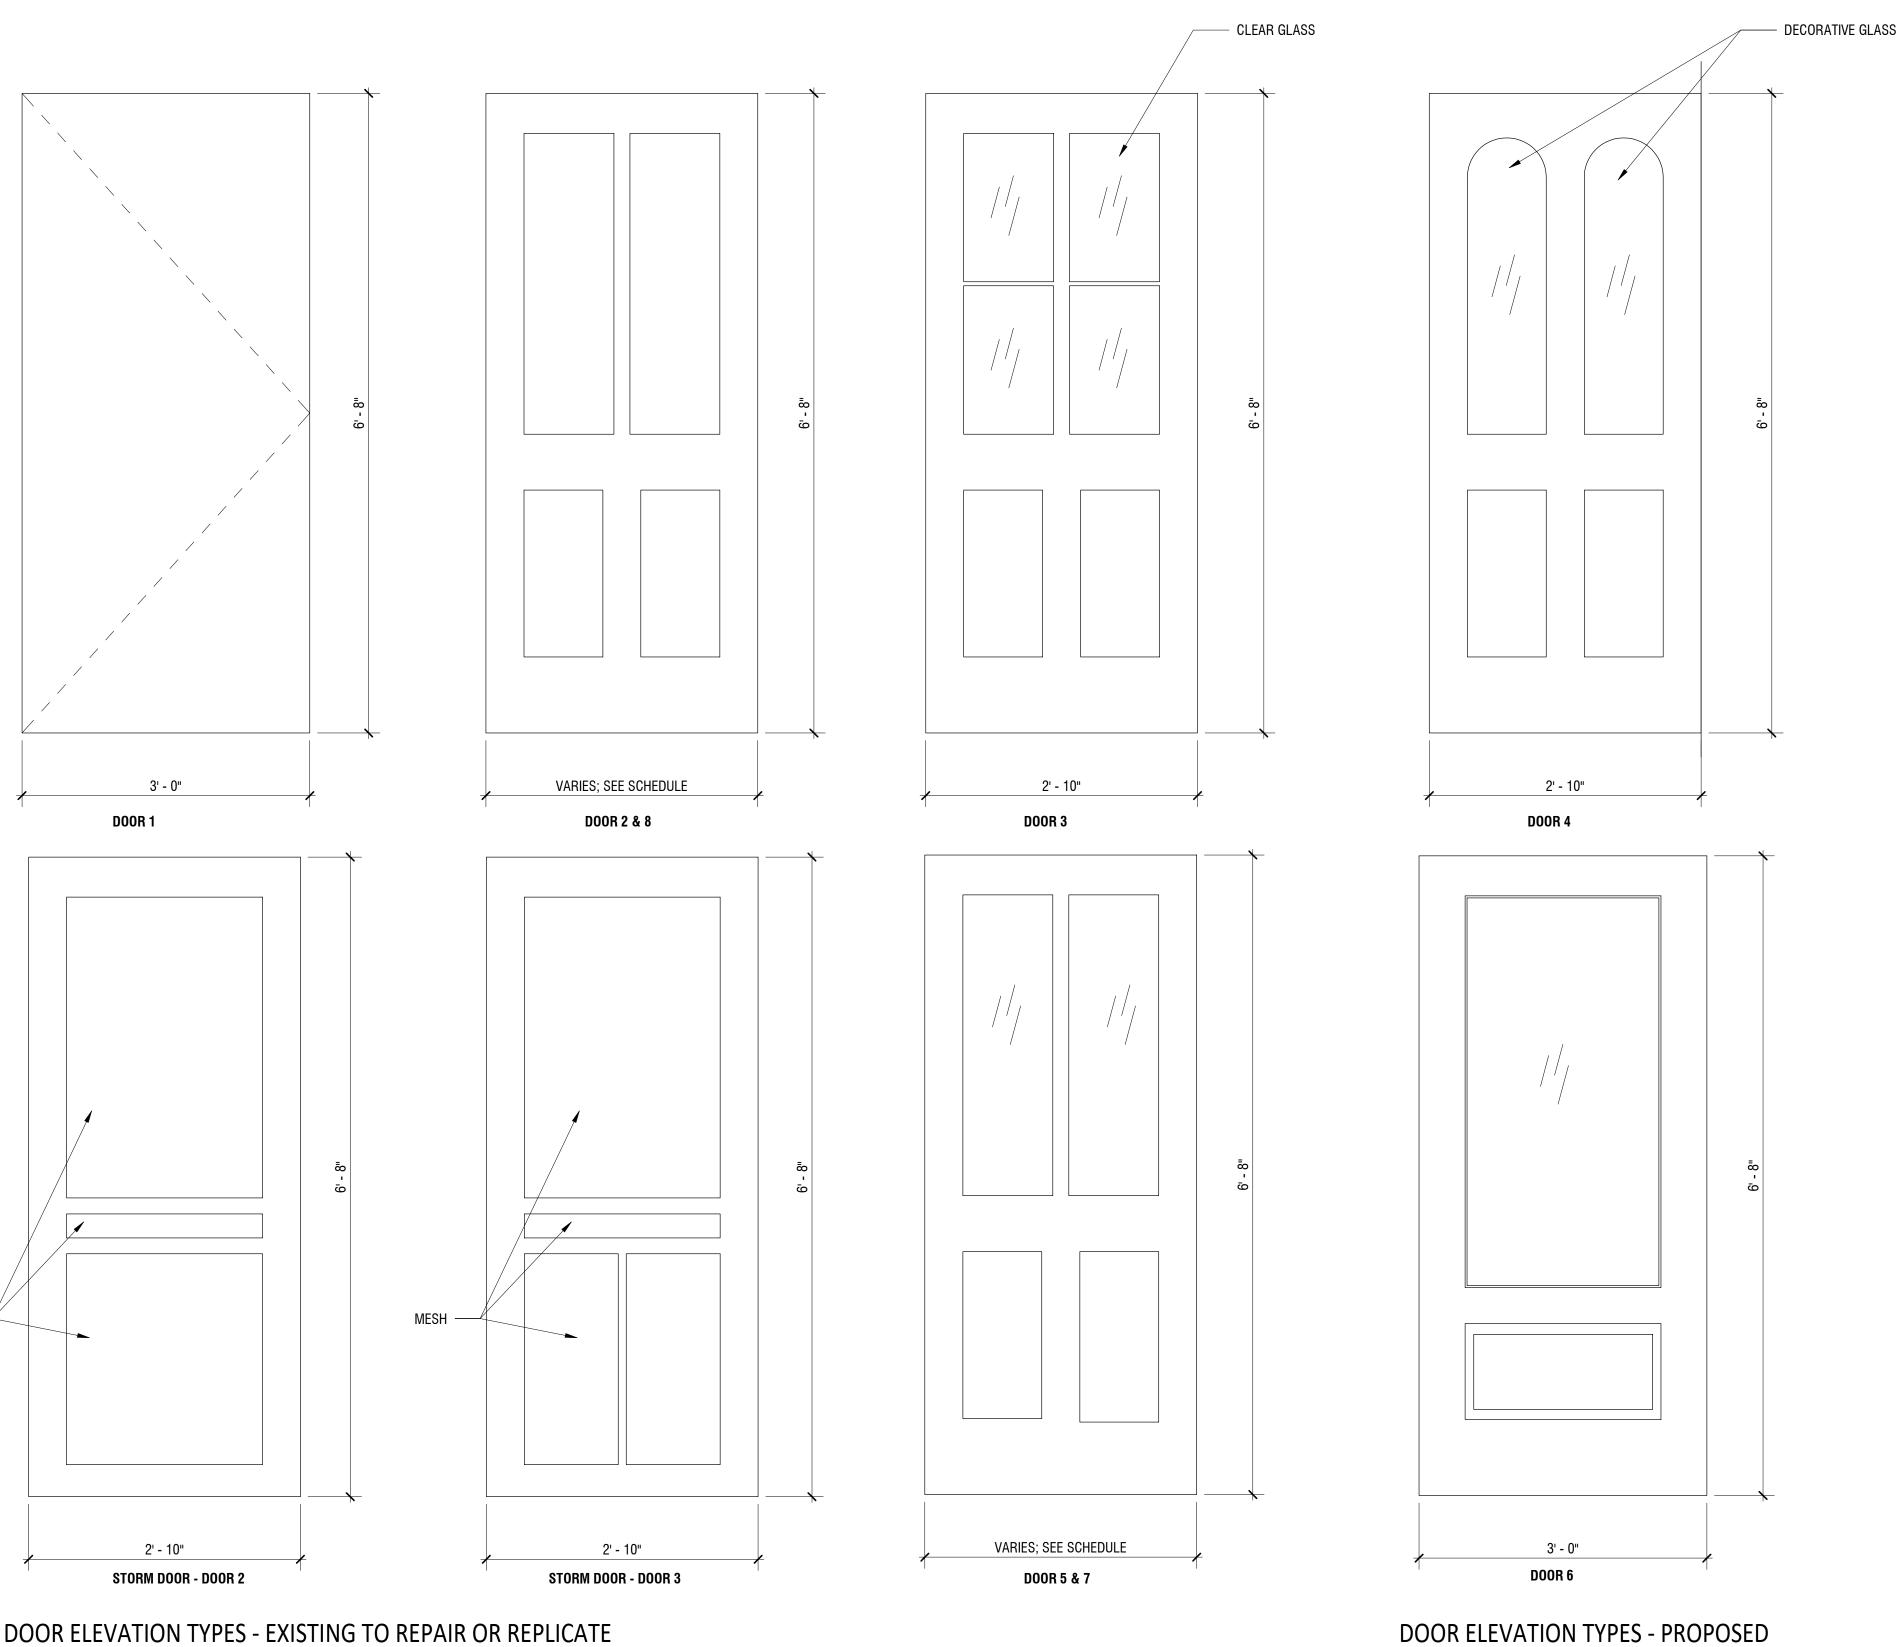

EXTERIOR DOOR SHUTTERS - EXISTING TO REPAIR OR REPLICATE

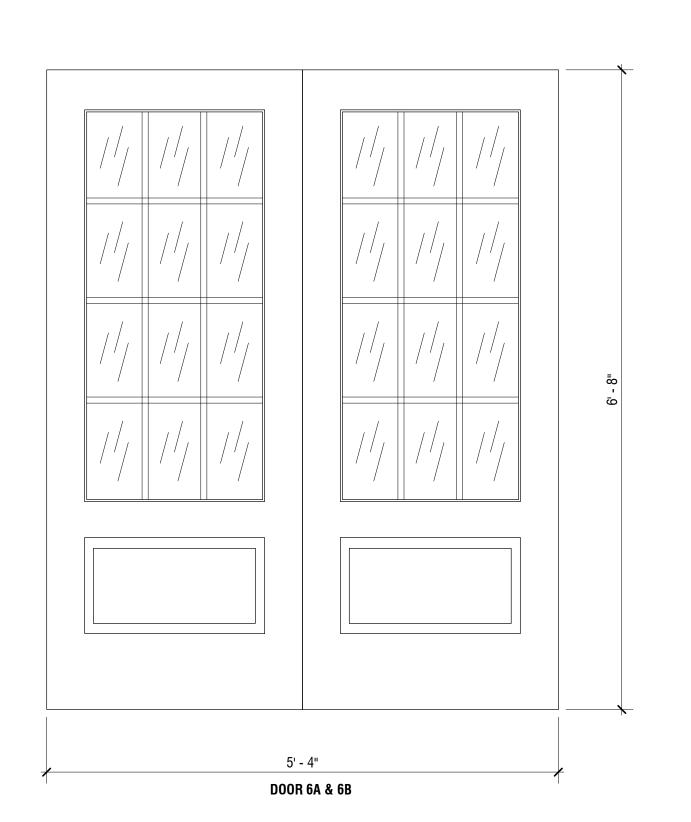



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WESTPORT, CT 06880

2203 PROJECT # LPA DRAWN BY

06/07/2023

SHEET TITLE

DOOR SCHEDULE, TYPES, DETAILS, AND **NOTES**


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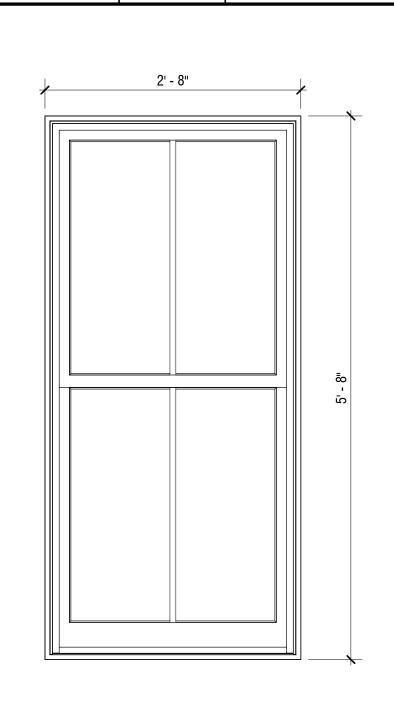
A8.0


DOOR ELEVATION TYPES - EXISTING TO REPAIR OR REPLICATE


MESH -


| | | | 1795/18 | 367 HISTORIC | CAL HOUSE WINDOW SCH | HEDULE | |
|-------------|--------------------|-------------|----------|--------------|----------------------|----------|--|
| WINDOW TAG | APPROX. SIZE | MANUFACTURE | FUNCTION | MAT'L | GLASS TYPE | SHUTTERS | COMMENTS |
| FIRST FLOOR | | | | | | | |
| W-1 | 2' - 8" X 5' - 0" | CUSTOM | DH | WOOD | ANTIQUE; SINGLE PANE | S-A | RESTORE AND REPAIR |
| W-2 | 2' - 8" X 7' - 0" | CUSTOM | FIXED | WOOD | ANTIQUE; SINGLE PANE | S-B | RESTORE AND REPAIR |
| W-3 | 2' - 8" X 5' - 8" | CUSTOM | DH | WOOD | ANTIQUE; SINGLE PANE | S-C | RESTORE AND REPAIR |
| W-4 | 1' - 10" X 5' - 8" | CUSTOM | DH | WOOD | ANTIQUE; SINGLE PANE | S-D | RESTORE AND REPAIR |
| SECOND FLOO | R | | | | | | |
| W-1 | 2' - 8" X 5' - 0" | CUSTOM | DH | WOOD | ANTIQUE; SINGLE PANE | S-A | RESTORE AND REPAIR |
| W-5 | 2' - 8" X 4' - 2" | CUSTOM | DH | WOOD | ANTIQUE; SINGLE PANE | S-E | RESTORE AND REPAIR |
| ATTIC | | | | | | | |
| W-6 | 24" DIA | CUSTOM | FIXED | WOOD | ANTIQUE; SINGLE PANE | NO | RESTORE AND REPAIR |
| CUPOLA | | | | | | | |
| W-7 | FIELD MEASURE | CUSTOM | FIXED | WOOD | ANTIQUE; SINGLE PANE | NO | RESTORE AND REPAIR |
| | | | 200 | 3 HOUSE AD | DDITION WINDOW SCHED | ULE | |
| WINDOW TAG | APPROX. SIZE | MANUFACTURE | FUNCTION | MAT'L | GLASS TYPE | SHUTTERS | COMMENTS |
| LOWER LEVEL | | | | | | | |
| W-8 | 3' - 0" X 5' - 0 | CUSTOM | DH | WOOD | SINGLE PANE | NO | EXISTING TO REMAIN; REPAIR AND REPAINT AS NEEDED |
| FIRST FLOOR | | | | | | | |
| W-9 | 1' - 8" X 2' - 8" | CUSTOM | DH | WOOD | SINGLE PANE | NO | EXISTING TO REMAIN; REPAIR AND REPAINT AS NEEDED |
| W-10 | 2' - 6" X 5' - 0" | CUSTOM | DH | WOOD | SINGLE PANE | S-J | EXISTING TO REMAIN; REPAIR AND REPAINT AS NEEDED |
| SECOND FLOO | R | | | | | | |
| W-11 | 3' - 0" X 1' - 8" | CUSTOM | CASEMENT | WOOD | SINGLE PANE | NO | EXISTING TO REMAIN; REPAIR AND REPAINT AS NEEDED |



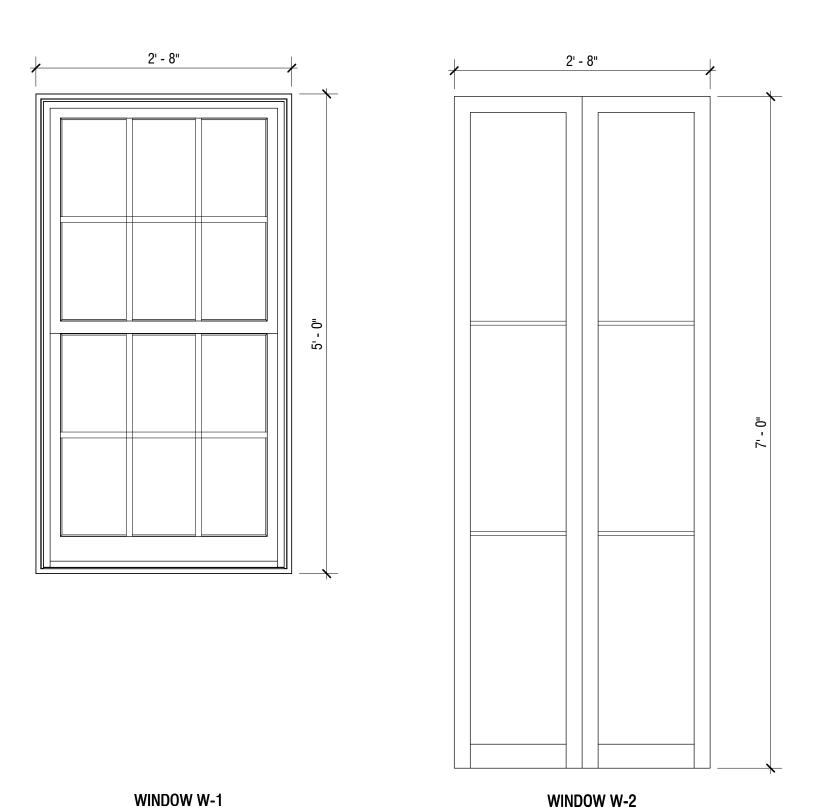


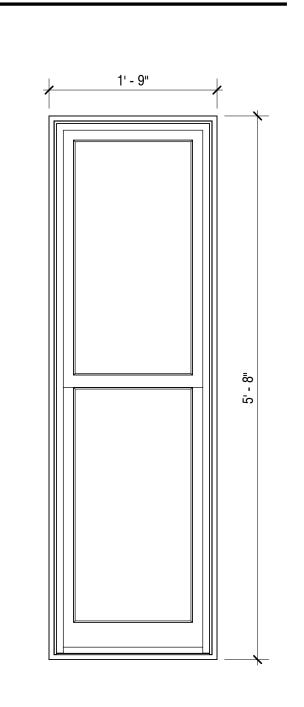


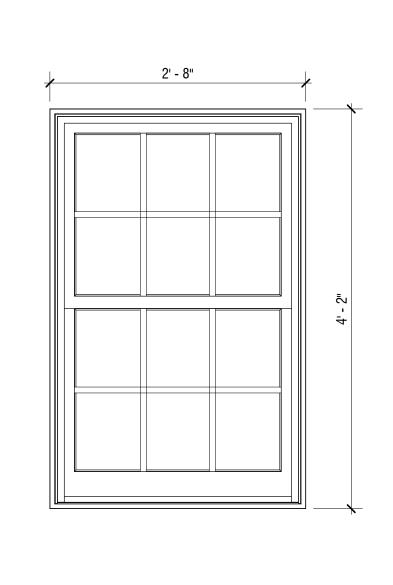


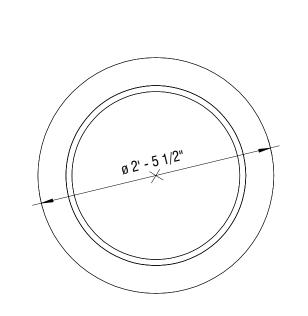


WINDOW W-6

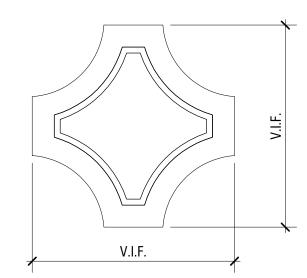

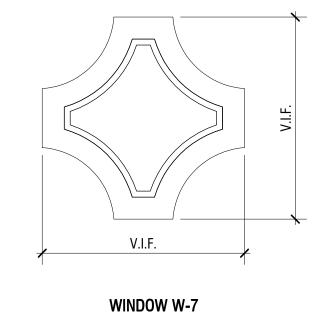


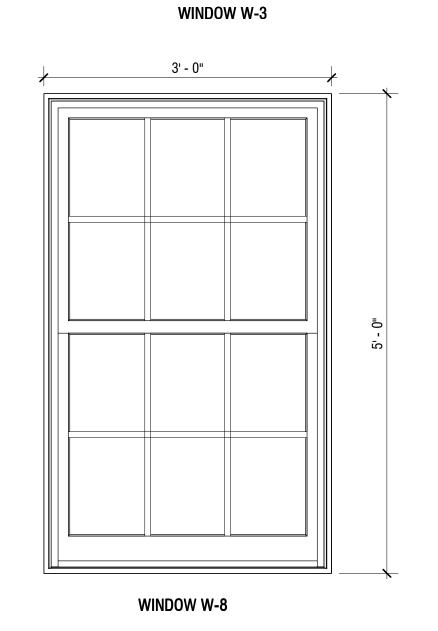


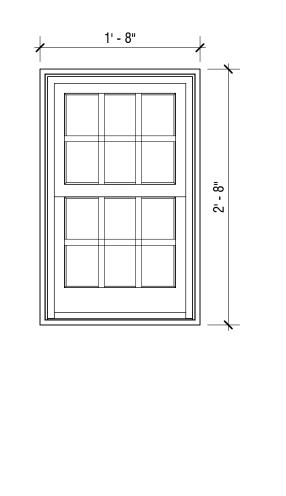

WINDOW W-9

WINDOW W-4

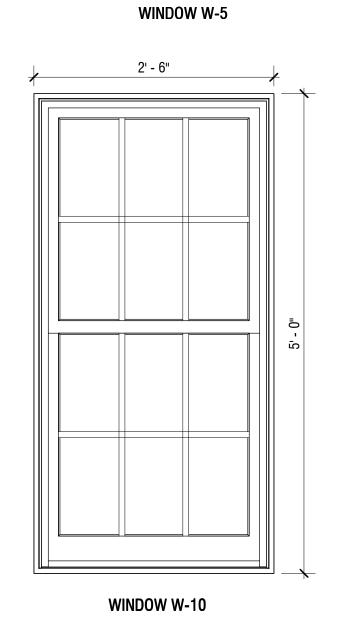

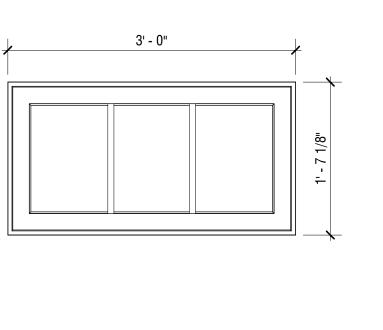

WINDOW W-11

WINDOW ELEVATION TYPES - EXISTING TO REPAIR OR REPLICATE

WESTPORT

MUSEUM BRADLEY -

WHEELER HOUSE

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Westport, Connecticut 06880

183 Main Street

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PROJECT ADDRESS 25 AVERY PLACE WESTPORT, CT 06880

PROJECT INFO


PROJECT # **2203** DRAWN BY LPA

06/07/2023

SHEET TITLE

WINDOW SCHEDULE & TYPES

A8.10

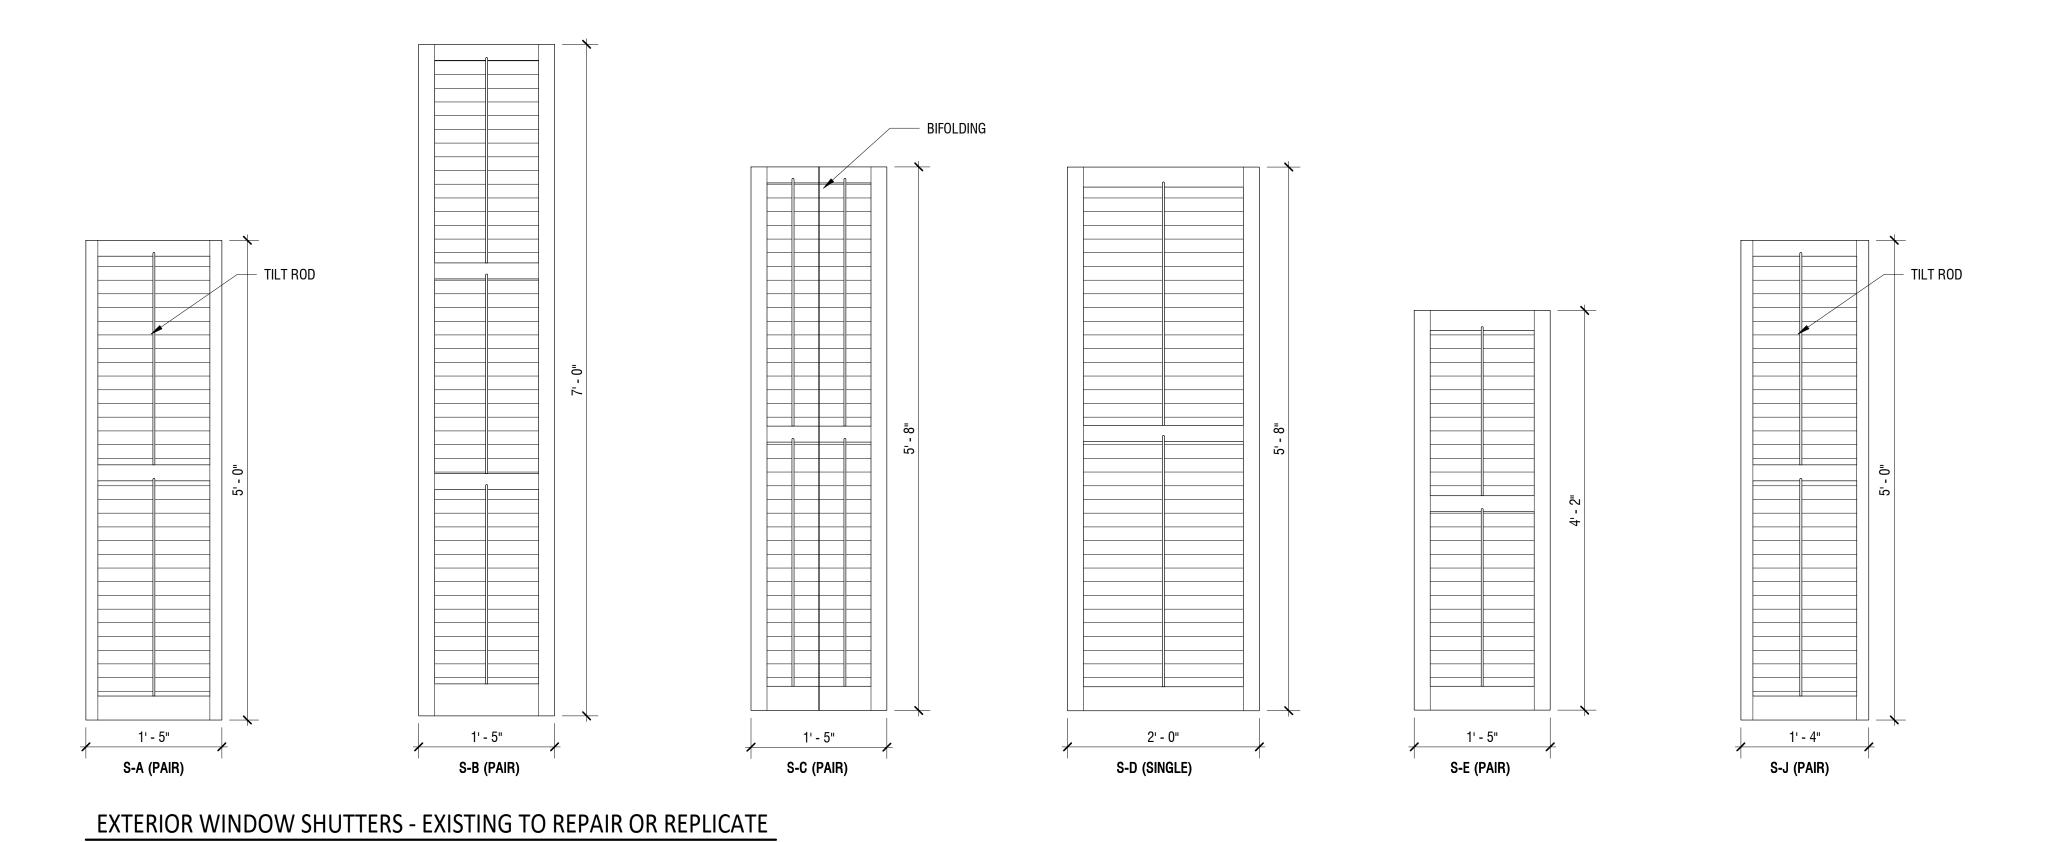

LP

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REV# DESCRIPTION

PROJECT II

WESTPORT MUSEUM BRADLEY -WHEELER HOUSE

PROJECT ADDRESS

25 AVERY PLACE
WESTPORT, CT 06880

PROJECT # **2203**

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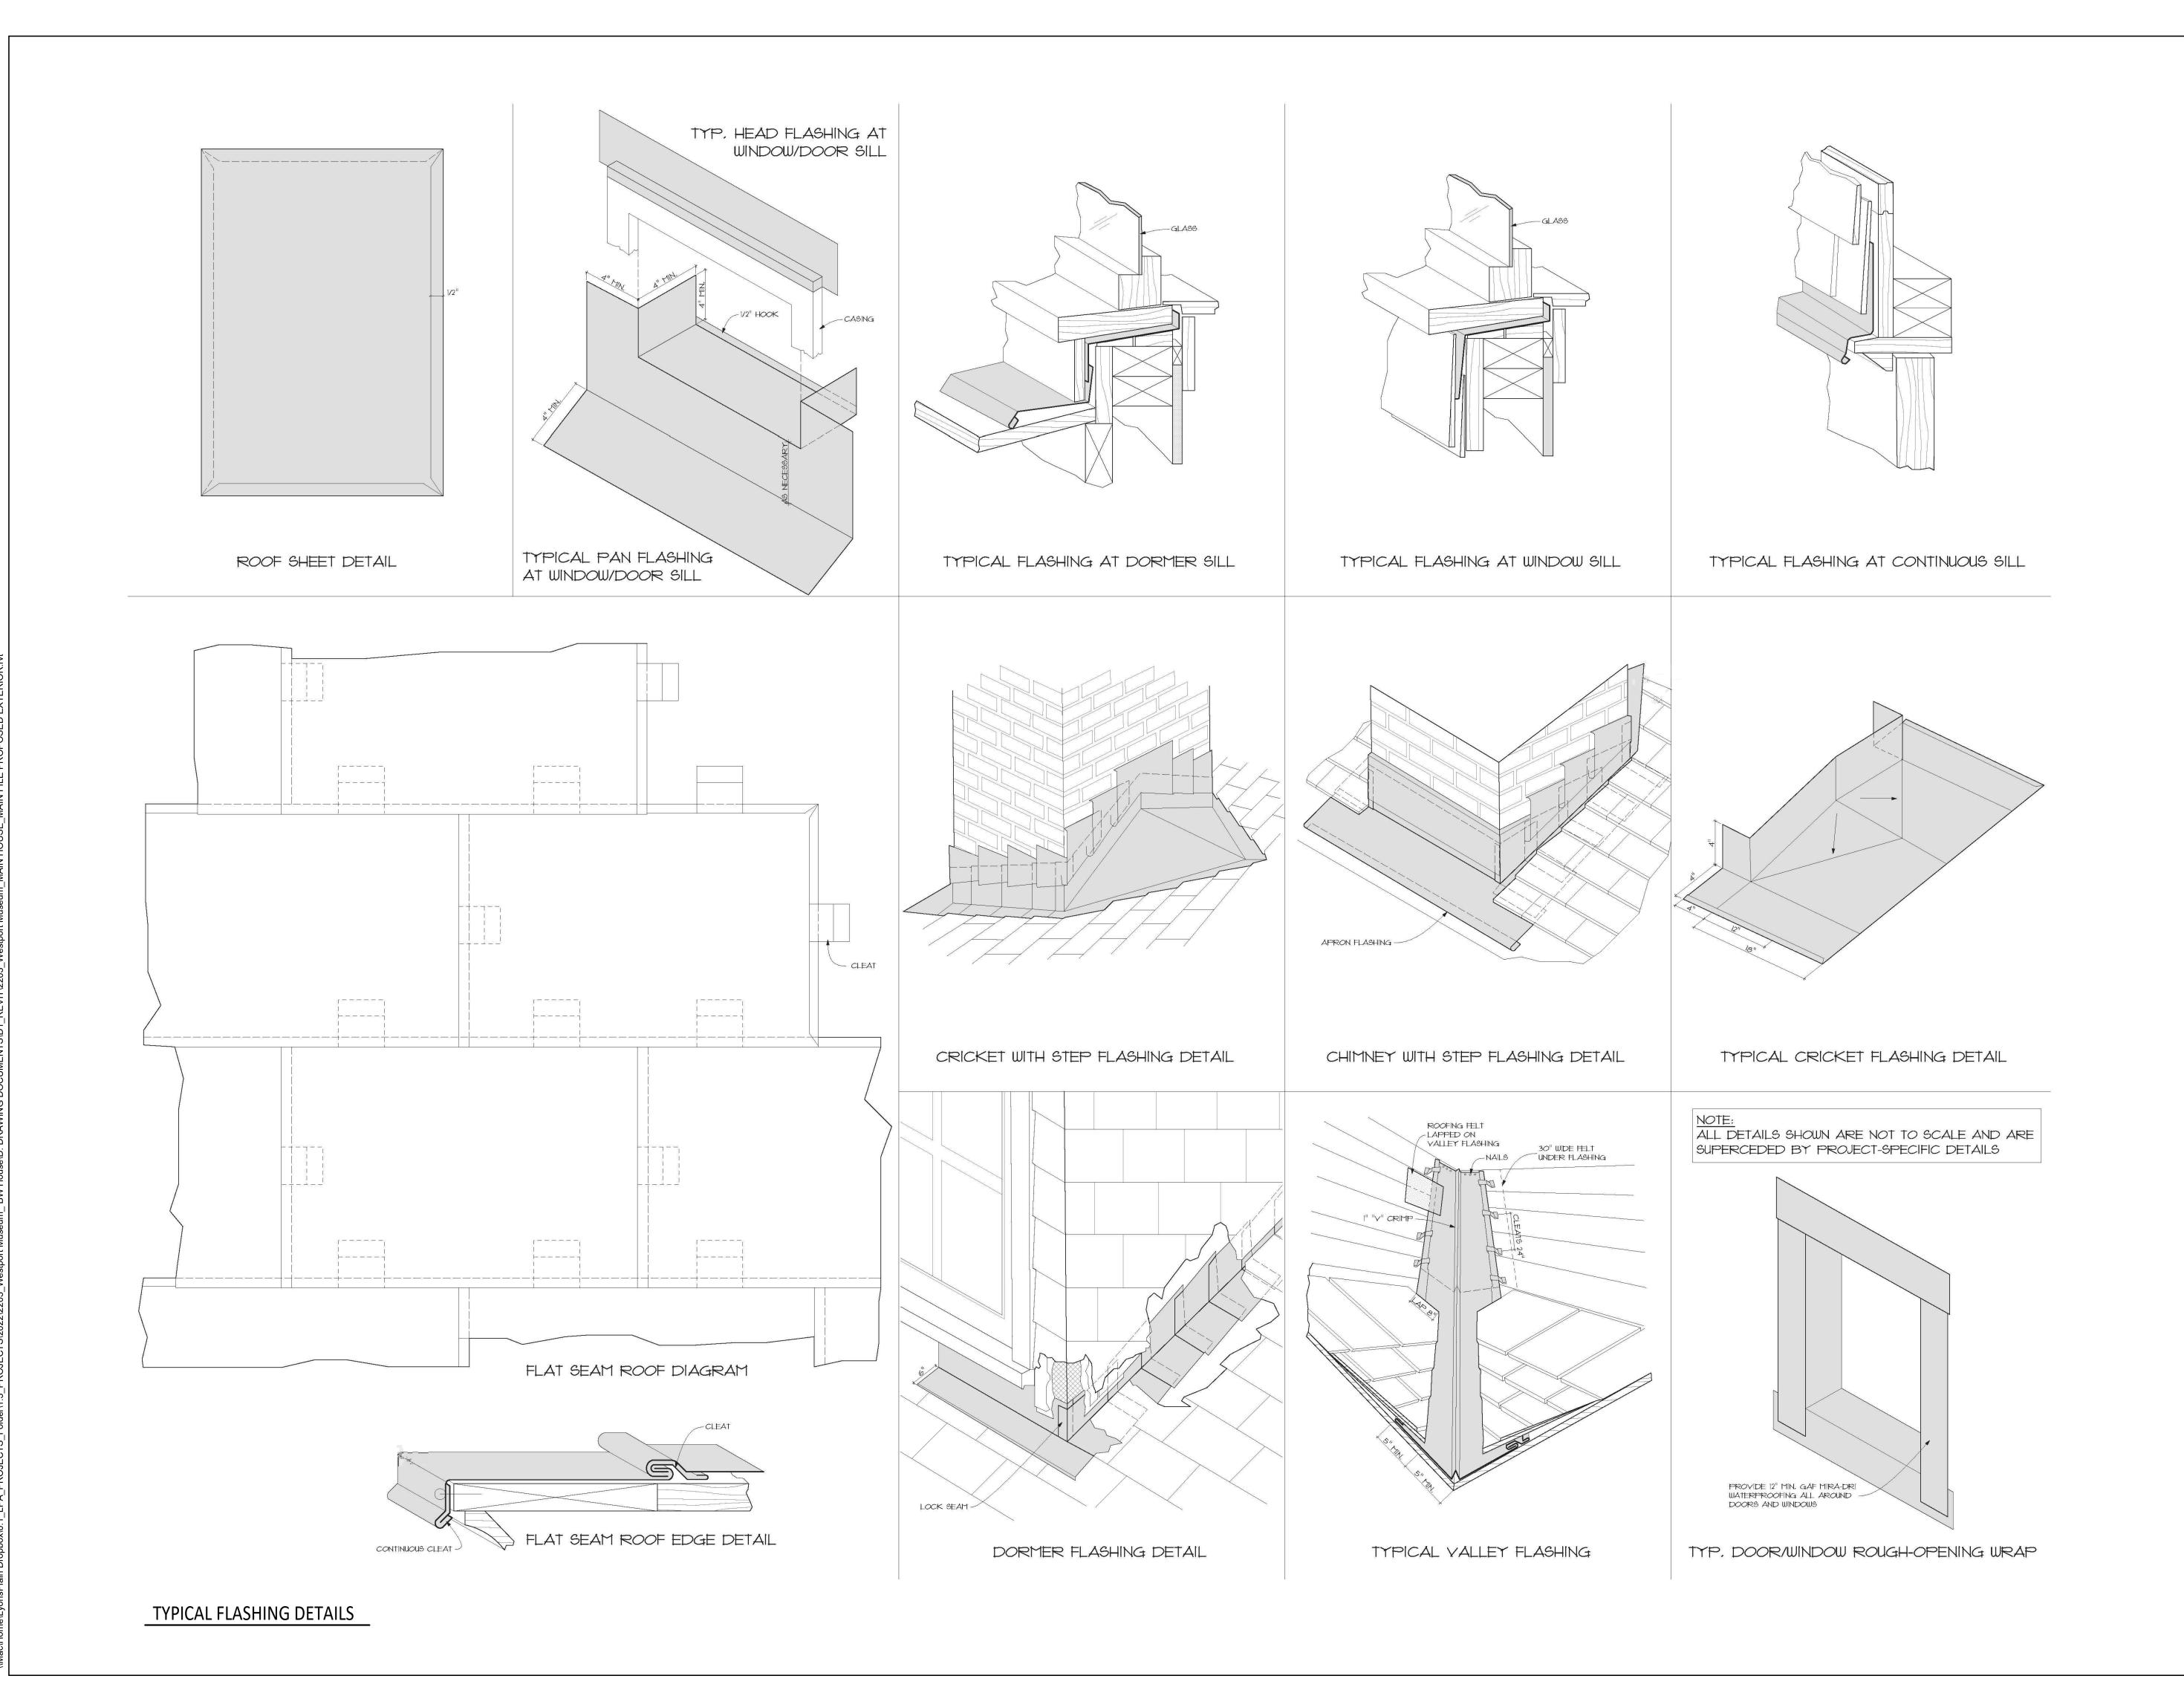
DATE **06/07/2023**

SHEET TITLE

WINDOW SHUTTER TYPES

SHEET NUMBER

A8.11



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<u> DESCRIPTION</u>

PROJECT INFO

WESTPORT
MUSEUM BRADLEY WHEELER HOUSE

PROJECT ADDRESS

25 AVERY PLACE

WESTPORT, CT 06880

PROJECT # 2203

DRAWN BY LPA

06/07/2023

SHEET TITLE

TYPICAL DETAILS

SHEET NUMBER

A9.1

WESTPORT MUSEUM FOR HISTORY AND CULTURE BRADLEY - WHEELER HOUSE WESTPORT HISTORIC DISTRICT COMMISSION - CERTIFICATE OF APPROPRIATENESS APPLICATION

PHOTOGRAPHIC DOCUMENTATION

June 17th, 2023

LYONSPLAIN ARCHITECTURE













EXISTING CONDITIONS

















EXISTING CONDITIONS

















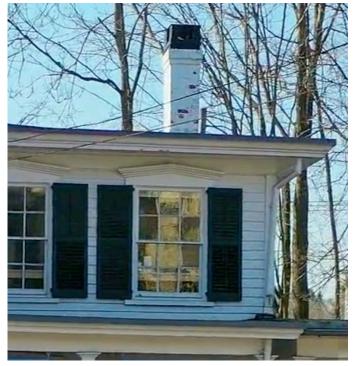

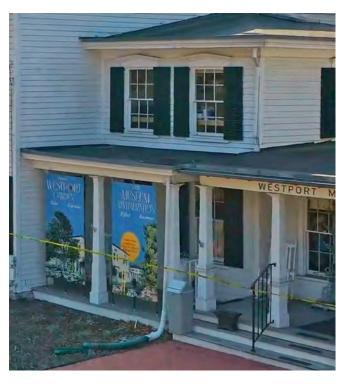

EXISTING EXTERIOR DETAILS



















EXISTING EXTERIOR DETAILS


























ADJACENT STREET FRONTAGE







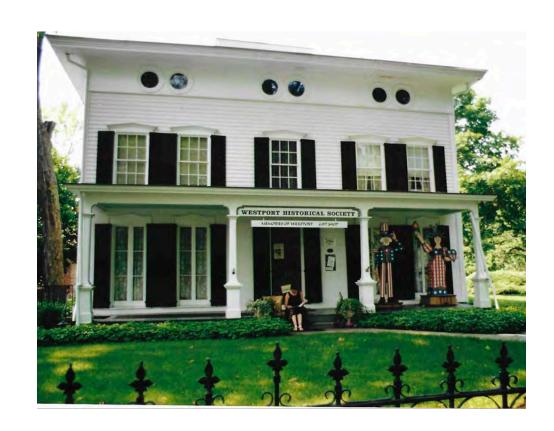





HISTORIC PHOTOS









HISTORIC PHOTOS

ADJACENT PROPERTY OWNERS:

OWNER: TOWN OF WESTPORT

CO OWNER: NEW TOWN COMMON HIST PROP

110 MYRTLE AVE WESTPORT, CT 06880

OWNER: WHA EQUITIES CORPORATION

190 MAIN ST P.O.BOX 95 WESTPORT, CT 06881

OWNER: WESTPORT HISTORICAL SOCIETY

25 AVERY PL



HISTORIC RESOURCES INVENTORY - BUILDING AND STRUCTURES

Please send completed form to: Stacey Vairo, National Register and State Register Coordinator, Connecticut Commission on Culture & Tourism, One Constitution Plaza, 2nd Floor, Hartford, CT 06103

* Note: Please attach any additional or expanded information on a separate sheet.

| GENERAL INFORMATION | |
|---|---------------------------------|
| Building Name (Common) Westport Historical Society | ty |
| Building Name (Historic) Coley-Bradley-Wheeler Ho | puse |
| Street Address or Location 25 Avery Place | |
| Town/City Westport Village _ | County Fairfield |
| O Wastport Historical Conint. | O Public O Private |
| Present Use: Museum | |
| Historic Use: Residential | |
| Accessibility to public: Exterior visible from public r Interior accessible? O Yes O No If yes, explain _ Style of building Italianate (ca. 1860 remodel) | |
| Material(s) (Indicate use or location when appropriate): | |
| ☐ Clapboard ☐ Asbestos Siding ☐ Brice ☐ Fieldstone ☐ Board & Batten ☐ Stude ☐ Concrete (Type) ☐ Cut | |
| Structural System Wood Frame Post & Beam Balle Other | oon |
| Roof (Type) | |
| ☐ Gable ☑ Flat ☐ Mansard ☐ Gambrel ☐ Shed ☐ Hip ☐ (Material) | Monitor Sawtooth Round Other |
| ☐ Wood Shingle | Tin Slate Asphalt Shingle Other |
| Number of Stories: 2 Approximate Dim | ensions |
| Structural Condition: Excellent Good Fr | |
| Exterior Condition: Excellent V Good Fair | |
| Location Integrity: On original site Moved | When? |
| | S |
| | UTM |
| | R, Specify: Actual Potential |

| PROPERTY INFORMATION (CONT'D) | The state of the s | The state of the s | 1 12storic Kesourres Invent |
|--|--|--|-----------------------------|
| Related outbuildings or landscape features: Barn Shed Garage Other landscape features or buildings: | Carriage House | Shop | Garden |
| 1 ligh building density Scattered | al Commercial Ir buildings visible from site | ndustrial 🔲 | Rural |
| Interrelationship of building and surroundings: See continuation sheet. | | | |
| • Other notable features of building or site (Interior a See continuation sheet. | nd/or Exterior) | | |
| Architect | Builder | | |
| · Historical or Architectural importance: | | | 17-17- |
| | | | |
| • Sources: | | | |
| See continuation sheet. | | | |
| Photographer PAL | | Dat | e |
| View | | | |
| Name | | | |
| Organization PAL | 20 | | |
| Address 210 Lonsdale Avenue, Pawtucket, RI 0286 | 00 | | |
| Subsequent field evaluations: | | | |
| Threats to the building or site: | | | |
| | andalism Developers | Renewal | Private |
| | ther | | on |

COMMISSION ON CULTURE & TOURISM STATE HISTORIC PRESERVATION OFFICE

One Constitution Plaza, Second Floor, Hartford, CT 06103

HISTORIC RESOURCE INVENTORY FORM

For Buildings and Structures

CONTINUATION SHEET

Item Number: ____ Date: October 2011

PAL, Pawtucket, RI 02860

25 Avery Place, Westport, CT

Interrelationship of building and surroundings:

The building occupies a level site on the northwest side of the intersection of Avery Place and Myrtle Avenue. It is set close to the street and faces south. Planted beds line the building's foundation and a well-kept grass lawn lies to the south and east. To the west of the house lies a patch of dense vegetation, and several other large trees and shrubs dot the property. A gravel driveway off of Myrtle Avenue leading to the former carriage house lies to the north of the house. A cast-iron fence borders the south and east edges of the lot, separating it from the sidewalk and street.

Other notable features of building or site (Interior and/or Exterior):

The building is a two-story, five-bay-by-two-bay Italianate style former residence. The shallow hip roof has a wide overhang and brick chimneys on the east and west slopes. A wide entablature runs below the roofline and contains pairs of bull's-eye windows. A square cupola is located at the ridge and has two decorative openings on each side with a wide hip roof and elaborate scroll-sawn finial. The walls are clad in clapboard with flush board on the first story of the south (facade) elevation and rest on a fieldstone foundation. The house was enlarged and remodeled in the Italianate style in the 1860s. A full-width porch with a hip roof and chamfered posts was constructed during the remodel. A bay window on the east elevation and an ell on the north elevation were also built at that time. The ell is two stories tall and two bays wide with a hip roof and brick chimney on the north slope. A one-story addition was constructed on the north end of the ell to connect it to an octagonal addition. A porch supported by tapered posts extends across the entire east elevation of the ell and one-story addition. An octagonal addition on the north elevation of the one-story addition has deep overhangs and a wide frieze containing rectangular, three-light windows. The one-story and octagonal additions were constructed in 2010. An octagonal carriage house is located northwest of the house. It is one-story tall and two-bays wide with fieldstone walls, brick quoins, and a wood shingle-clad conical roof. The main entrance is located beneath the porch in the center of the facade and consists of a wood panel door with a pedimented lintel. A secondary entrance on the east elevation of the ell consists of a wood panel door with a pediment. An entrance on the east elevation of the one-story addition consists of a wood panel door with simple wood trim. Windows primarily consist of six-over-six, wood, doublehung sash with pediments. Four pairs of full-height, three-pane casement windows are evenly spaced on the east and west sides of the main entrance on the facade. The bay window has two-over-two and one-over-one double-hung sash with panels below. The ca. 1860 plan of the house is relatively intact except for the large addition on the north elevation, which is not visible from the facade. Most of the materials are original to the 1860s remodel, but some windows and exterior cladding materials appear to be mid-twentieth-century replacements.

Historical or Architectural importance:

The Wheeler House was originally constructed ca. 1795 by Captain Ebenezer Coley for his son, Michael. The Coley's sold the property to Anne Avery and her mother, Mary Kent, in 1799. Avery married David Ripley and converted a portion of the house into a millinery shop. Through the 1830s and 1840s, the house had multiple owners. Farmin Patchin, who owned the property in 1846, built a second residence on the west end of the property. By the late 1850s, the house was purchased by Morris Bradley, who oversaw an extensive renovation that resulted in the extant Italianate villa. Bradley, who by 1870 owned \$90,000 worth of property in Westport and Weston, died in 1886 and left the house to his wife, Mary willed the property to her daughter Julia and son-in-law, Charles Wheeler. The Wheelers lived there until the early 1930s, when it passed to their son, William Wheeler. Wheeler lived in the house until his death in 1958, and operated a medical practice on the first floor. By 1960 the house was occupied by Mrs. Charlotte P. Darby, who remained there through the late 1970s. The 1980 directory listed the house as vacant, but by 1985 the property was purchased by the current tenants, the Westport Historical Society.

FOR OFFICE USE ONLY

TOWN NO.: SITE NO.: UTM: 18/_/_/_/_/_

QUAD: DISTRICT:

NR: Actual Potential

COMMISSION ON CULTURE & TOURISM STATE HISTORIC PRESERVATION OFFICE

One Constitution Plaza, Second Floor, Hartford, CT 06103

HISTORIC RESOURCE INVENTORY FORM

For Buildings and Structures

CONTINUATION SHEET

Item Number: ____ Date: October 2011

PAL, Pawtucket, RI 02860

25 Avery Place, Westport, CT

Sources:

Beers, J.H. & Co. Atlas of the County of Fairfield. 1867; Hopkins, G.M. Atlas of the County of Fairfield. 1879; Malm, Dorothea. Westport, Connecticut, 1842. 2000; Sanborn Fire Insurance Maps. 1891-1940; Westport Directory (W.D.). Loveland, CO: US West Marketing Resources, 1991; W.D. Chicago, IL: Johnson Publishing Co., 1985; W.D. Providence, RI: C. DeWitt White Co., 1917-1918; W.D. New Haven: The Price & Lee Co., 1923-1974; Westport Assessor's Online Database, 2012; Wheeler House. Westport Historical Society. Accessed 3/1/2012 from http://westporthistory.org/wheelerhouse/.

| FOR OFFICE U | SE ONLY | |
|-----------------------------------|-------------------------|--|
| TOWN NO.: UTM: 18//_/ QUAD: | SITE NO.: _/_/_/_ | |
| DISTRICT: | NR: Actual Potential | |

COMMISSION ON CULTURE & TOURISM STATE HISTORIC PRESERVATION OFFICE

One Constitution Plaza, Second Floor, Hartford, CT 06103

HISTORIC RESOURCE INVENTORY FORM

For Buildings and Structures

CONTINUATION SHEET

Item Number: __ Date: October 2011


PAL, Pawtucket, RI 02860

25 Avery Place, Westport, CT

PHOTOGRAPHS



View of the south and east elevations.

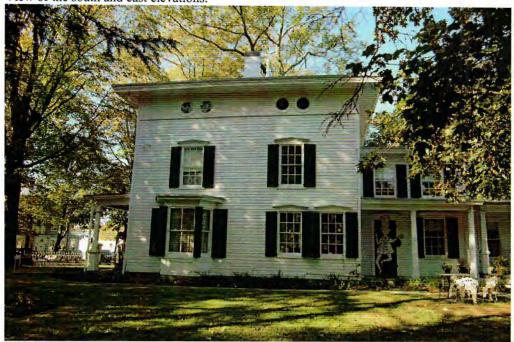

View of the east elevation.

FOR OFFICE USE ONLY

TOWN NO .: SITE NO .: UTM: 18/__/_/_/__/__

QUAD: DISTRICT:

NR: Actual

Potential

COMMISSION ON CULTURE & TOURISM STATE HISTORIC PRESERVATION OFFICE

One Constitution Plaza, Second Floor, Hartford, CT 06103

HISTORIC RESOURCE INVENTORY FORM

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25 Avery Place, Westport, CT

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TOWN NO .:


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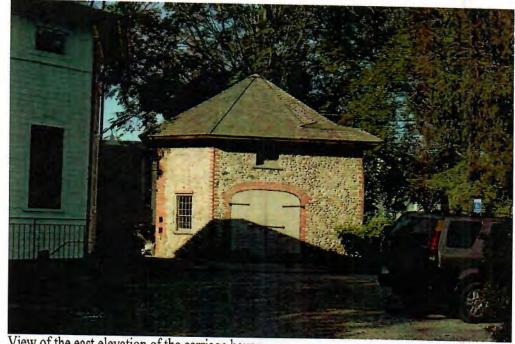
UTM: 18/_/ QUAD:

DISTRICT:

NR: Actual

Potential



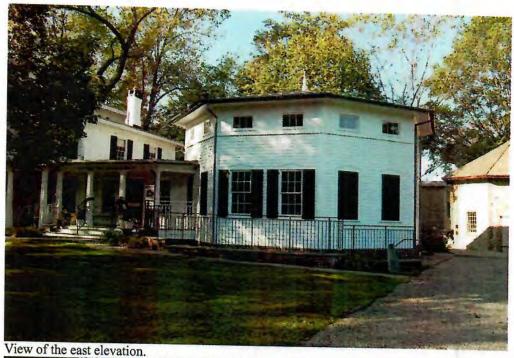

View of the east elevation of the carriage house.

Historic Barns of Connecticut A CONNECTICUT TRUST FOR HISTORIC PRESERVATION PROJECT

| Bradley-Wheeler Barn Museum of | | | | | 1 | The state of the s | 40 30 |
|---|------------------------------|--------------------|-------------------------|-----|-------------------|--|-------|
| Westport Current Name | Current Owner | | _ | | | | |
| Coley-Bradley-Wheeler House | Ownership | | | | | | |
| Historic Name | O private O pub | olic non-prof | it | | | | - 90 |
| 25 Avery Place, Westport | | | | | | KENTIN | - |
| House #, Street, Town | | | | | 1 | _ | |
| 25 feet diameter. | | | | | | | |
| Dimensions | | | _ | | | 3 - | 3 |
| Use & Accessibility | | | | | | | |
| Visible from Public Road ● Yes ○ Interior Accessible ○ Yes ● No | No | agriculture | | Н | CO | poultry | H C |
| Accessibility Notes | | animals, not I | isted | | ŏ | re-use | 00 |
| | | apple | | | 0 | residence | 00 |
| | | carriage barn | | | 0 | retail | 00 |
| | | corn crib dairy | | | 0 | shed | 00 |
| | | equestrian | | 00 | 00 | sheep storage | 000 |
| | | garage | | 0 | 0 | tobacco | 000 |
| | | gentleman | | Õ | O | unknown | 00 |
| | | mill | | 0 | 0 | vegetables | 00 |
| | | museum | | 0 | • | vineyard | 00 |
| | | onion | | | 0 | workspace | 00 |
| | | potato | | 0 | 0 | | |
| Environment | | | | | | | |
| environment features | | | elated featu | res | | | |
| O Active Agriculture (| O Commercial O Industrial | | Barn | | | O Carriage House | |
| O Open Land | Residential | 2 | Cupola Garden | | | O Garage O Shed | |
| Rural (| O Scattered Buildings | | Shop | | | O Silo | |
| Woodland | | | Stone Walls | | | | |
| Relationship to Surroundings Located on Avery Place, in the center of | What are | 1.2 | hreats | | _ | | |
| Located on Avery Place, in the center of | vvestport. | (| Deterioration | 00 | evelo | opers O Highw | ay |
| | | | None Known Vandalism | | Private Coning | e O Renev | wal |
| | | - | | | _ | | |
| | | | Threat Details | | | | |
| | | | | | | | |

| Type & Materia | ils | | | | |
|--|--|--|--|---|---|
| materials Aluminum Siding Board & Batten Cobblestone Cut Stone Horizontal Siding Stucco Wood Shingle | O Asbestos Sid O Brick O Concrete O Fieldstone O Metal Panels O Vertical Sidir | 0 c 0 c 0 FI 0 PI | sphalt Siding lapboard oncrete Block ush-board lywood inyl Siding | typology Carriage House Connected English English/New England Hybrid Gambrel Bank Mill New England Other Shed Polygonal/Round Tobacco Shed Wagon Shed | Chicken Coop Corn Crib English Bank Gambrel Ground-Level Stable Multi-tiered New England Bank Pole Prefab Unknown |
| roof materials Asphalt Shingle Built Up Metal Rolled Slate Tile Tin Wood Shingle | | Doof type Dutch Gamb Gable Gothic Mansard Octagonal Saltbox Shed | rel O Flat O Gambrel O Hip O Monitor O Round O Sawtooth | Structural system Balloon Frame Load-bearing Masonry Pole Barn Post & Beam Frame Structural Steel or Iron Wood Frame | layout system Scribe Rule Square Rule Transition |
| ntegrity & Prov | | e de maria | | | |
| 1846-1857 | Farmin | Patchin | | | |
| Construction Date esignations | Builder | O Nat | tional Historic Landi te Register | Architect mark National R Village Distr | e gister rict |
| lesignations Local Historic Distr State Historic Resou Importance Architectural descrip | Builder rict rce Inventory | O Nat Sta | te Register | mark National Re | rict |
| lesignations Description Descr | Builder rict rce Inventory stion: andomly set cobt uble doors. Brick ide. An exterior v like the base is o width of each of th ft. wide double, ri - 17 ft. 9 in. with a either larger 12 o have the larger v s and framing are f the roof with we the masonry wall ecessary to meel The walls of the k loor joists are set | lestone and intels are over rought iron detagonal. Under seven face und-topped in exterior do er 8 or 2 over indow on the exposed. The den pegs. Even to the modern structurar complete into the mas | mortar on all side er first floor windo door handle and lo derneath is a part ades are as follow door; B - 10 ft.; Coor measuring 5 ft er 2 larger panes. Each rafter termin was bolted down cutral requirements of the weight of the second of the conical roof structural requirements of the second of the conical roof structural requirements of the second | mark National Re | n all but one back corner and arounteavy wrought iron strap hinge secure the building. The roof is and ice storage and is accessed façade and moving left: Façade A of loard cellar door 5 ft. high; E - 10 dt. Iller window on the 2nd story while the vindow on the 2nd story while st" plate of steel that was fabricated by the barn open. |
| lesignations Description Descr | Builder rict rce Inventory stion: andomly set cobb uble doors. Brick ide. An exterior w like the base is o width of each of the stide of the stid | lestone and intels are over rought iron detagonal. Under seven face und-topped in exterior do er 8 or 2 over indow on the exposed. The den pegs. Even to the modern structurar complete into the mas | mortar on all side er first floor windo door handle and lo derneath is a part ades are as follow door; B - 10 ft.; Coor measuring 5 ft er 2 larger panes. Each rafter termin was bolted down cutral requirements of the weight of the second of the conical roof structural requirements of the second of the conical roof structural requirements of the second | s, with decorative brick as quoins on the control of the grant of the | n all but one back corner and around eavy wrought iron strap hinge secure the building. The roof is estand ice storage and is accessed façade and moving left: Façade A I board cellar door 5 ft. high; E - 10 dt. Iller window on the 2nd story while straight of rafters, secured to one another straight of steel that was fabricated by the bear open. |

05/18/2011

Charlotte Hitchcock, reviewed by CT Trust

203-562-6312 barns@cttrust.org

Date Compiled

Compiled By

Compiler Phone/Email

Field notes

The circa 1846-1857 heptagonal base, 2-story stone barn, known officially as the "Bradley-Wheeler Barn Museum of Westport" is owned by the Westport Historical Society and is located on the same property near the downtown. The originally Federal, now Italianate style home, known as the "Coley-Bradley-Wheeler House" has a built date of 1795 and houses administrative offices, a museum, exhibit space, an archives/vault area, and educational instruction rooms for children.

The barn's construction is attributed to the owner, Farmin Patchin, who was also a stonemason and blacksmith. He flattened one side of the barn, removing the 8th façade, so that a rectangular, wood frame barn (no longer standing) could be joined.

The barn is believed to be the only extant authentically restored heptagonal barn in the Northeast. All materials and fabrication methods are said to be original or replicated precisely. The mortar was chemically analyzed and reproduced and wood was imported from Holland for the rafters.

Multiple views of the stone barn can be seen at http://www.westporthistory.org/museum. The barn is open to the public daily April 1 - Nov. 30 and by appt. through the Westport Historical Society 203-222-1424.

Sources

Photography, research, and field notes by Betsy Wacker, Maggie Feczko, 05/18/2011.

Aerial views from:

http://maps.google.com/

http://www.bing.com/maps/ accessed 8/02/2011.

Ohno, Kate, Bradley-Wheeler House National Register Nomination No. 84000791, National Park Service, 1984.

Sexton, James, PhD; Survey Narrative of the Connecticut Barn. Connecticut Trust for Historic Preservation, Hamden, CT, 2005, http://www.connecticutbarns.org/history.

Visser, Thomas D., Field Guide to New England Barns and Farm Buildings, University Press of New England, 1997, 213 pages.

Local Historic District - New Town Common